

#### **GENERAL PLAN NOTES:**

- 1. DIMENSIONS SHOWN ARE TO FACE OF STUD, FACE OF MASONRY OR CENTERLINE OF COLUMN OR GRID LINE UNLESS NOTED OTHERWISE.
- 2. DOORS NOT LOCATED BY DIMENSION ARE TO BE CENTERED IN WALLS AS SHOWN OR LOCATED 4 1/2" FROM FACE OF STUD TO FACE OF JAMB.
- 3. NOTED WALL TYPE DEPICTS TYPICAL WALL CONSTRUCTION. SEE
- 4. DIMENSIONS AT GLAZING ASSEMBLIES ARE TO CENTER OF ASSEMBLY UNLESS NOTED OTHERWISE.

ELEVATIONS, SECTIONS, AND DETAILS FOR ADDITIONAL INFORMATION.


- 5. USE DIMENSIONS SHOWN; IN NO CASE SHALL WORKING DIMENSIONS BE SCALED FROM DRAWINGS. CROSS CHECK DETAILS AND DIMENSIONS SHOWN ON THE ARCHITECTURAL DRAWINGS WITH RELATED REQUIREMENTS ON THE STRUCTURAL, MECHANICAL, ELECTRICAL, PLUMBING, AND OTHER DRAWINGS AS APPLICABLE. NOTIFY ARCHITECT OF ANY DISCREPANCIES BEFORE PROCEEDING WITH THE WORK.
- 6. CONDITIONS AND DETAILS MARKED "TYPICAL" SHALL APPLY IN ALL CASES UNLESS SPECIFICALLY INDICATED OTHERWISE. TYPICAL DETAILS NOT REFERENCED ON DRAWINGS APPLY UNLESS NOTED OTHERWISE BY SPECIFIC NOTES AND DETAILS. WHERE NO SPECIFIC DETAIL IS SHOWN, THE CONSTRUCTION SHALL BE IDENTICAL OR SIMILAR TO THAT INDICATED FOR THE TYPICAL CONSTRUCTION OF THE
- . WHERE NO SPECIFIC STANDARDS ARE APPLIED TO A MATERIAL OR METHOD OF CONSTRUCTION TO BE USED ON THE WORK, ALL SUCH MATERIAL AND METHODS ARE TO MAINTAIN STANDARDS OF THE INDUSTRY AND, WHERE APPLICABLE, MANUFACTURER'S INSTRUCTIONS.
- 8. LOADING OF CONSTRUCTION MATERIALS SHALL NOT EXCEED THE DESIGN LIVE LOAD PER SQUARE FOOT.
- 9. ESTABLISH AND VERIFY ALL OPENINGS AND INSERTS FOR ARCHITECTURAL, MECHANICAL, ELECTRICAL, AND PLUMBING WITH APPROPRIATE TRADES, DRAWINGS, AND SUBCONTRACTORS PRIOR TO CONSTRUCTION.
- 10. PROVIDE ALL NECESSARY ANCHORAGE BLOCKING, BACKING, FRAMING FOR HANDRAILS, DOOR STOPS, CASEWORK, SHELVING, MIRRORS, WALL MOUNTED EQUIPMENT, AND ALL OTHER ITEMS AS REQUIRED FOR COMPLETE INSTALLATION.

- 11. CONFIRM ALL ROUGH OPENING DIMENSIONS FOR DOORS AND WINDOWS PRIOR TO COMMENCEMENT OF CONSTRUCTION.
- 12. WHERE A LENGTH OF WALL IS INTERSECTED BY PERPENDICULAR WALLS, WALL TYPE TO BE CONTINUOUS BETWEEN TAGS UNLESS NOTED OTHERWISE.
- 13. PROVIDE SOLID BLOCKING BETWEEN ROOF JOISTS WHERE WALL RUNS PERPENDICULAR TO ROOF JOISTS. GYPSUM BOARD TO TERMINATE AT ROOF JOISTS.
- 14. SEE DETAILS FOR DEFLECTION HEAD DETAILS.
- 15. AT ALL LOCATIONS WHERE WALLS, CEILINGS, EQUIPMENT OR FINISHES HAVE BEEN REMOVED, REPAIR SERVICES TO ORIGINAL CONDITION.
- 16. PROVIDE TILE BACKER BOARD BEHIND ALL CERAMIC TILE APPLICATIONS. MOISTURE RESISTANT GYPSUM BOARD SHALL ALSO BE USED AT ALL KITCHEN AREAS AND BEHIND DRINKING FOUNTAINS.
- 17. SEE INTERIOR ELEVATIONS FOR LOCATIONS AND EXTENTS OF APPLIED WALL FINISHES.
- 18. SEE FINISH LEGEND FOR MATERIAL DESIGNATIONS.
- 19. EXTEND FLOOR FINISHES UNDER TOEKICKS, OPEN COUNTERTOPS AND EQUIPMENT, TYPICAL.
- 20. PROVIDE TRANSITION STRIPS WHERE UNLIKE MATERIALS MEET,
- 21. WHERE FLOOR FINISH CHANGES MATERIAL, PATTERN OR COLOR AT A DOOR, LOCATE TRANSITION UNDER CENTERLINE OF DOOR.

### **GENERAL DEMO NOTES:**

- A. DEMOLITION DRAWINGS ARE DIAGRAMMATIC AND ARE TO ASSIST THE CONTRACTOR IN ESTABLISHING THE GENERAL SCOPE OF WORK. PROVIDE ALL DEMOLITION REQUIRED TO COMPLETE THE WORK AS INDICATED ON THE NEW CONSTRUCTION DRAWINGS AND AS SPECIFIED.
- B. NOTATIONS FOR SAW CUTTING CONCRETE SLABS ARE APPROXIMATE -VERIFY WITH STRUCTURAL MECHANICAL AND PLUMBING DRAWINGS AND WITH FIELD CONDITIONS. PATCH AND POUR BACK ANY SAW CUT CONCRETE FOR TRENCHES OR ANY HOLES FROM DEMOLISHED WALLS, CONDUIT OR PLUMBING WITH NEW CONCRETE TO MATCH EXISTING. SEE STRUCTURAL FOR POUR BACK DETAIL INFORMATION.
- C. SEE MECHANICAL, PLUMBING, ELECTRICAL AND TECHNOLOGY DRAWINGS FOR ADDITIONAL DEMOLITION INFORMATION.
- D. WHERE DEMOLITION OR REMOVAL OF AN ITEM OCCURS, PATCH REMAINING WALLS, FLOORS AND CEILING TO MATCH EXISTING ADJACENT MATERIAL, COLOR AND FINISH, UNLESS OTHERWISE NOTED.
- REMOVE MATERIALS TO BE REINSTALLED OR RETAINED IN A MANNER TO PREVENT DAMAGE, STORE AND PROTECT.
- F. PRIOR TO SAWCUTTING ANY EXISTING CONCRETE FLOOR SLAB, PROVIDE FIELD ENGINEERING AND UTILITIES LOCATION SERVICES TO LOCATE ANY EXISTING ELECTRICAL, TELEPHONE, WATER, SANITARY SEWER OR STORM DRAIN LINES WITHIN THE AREA OF WORK.
- G. THE TERM "DEMO" INDICATES THAT THE ITEM BECOMES THE PROPERTY OF THE GENERAL CONTRACTOR FOR DISPOSAL.
- H. FOR ITEMS IN WORK AREAS NOT DESIGNATED EITHER "TO REMAIN" OR "BE REINSTALLED" ARE TO BE SALVAGED AND TURNED OVER TO THE OWNER.
- CONTRACTOR TO REMOVE ANY EXISTING DUCTS, PIPES, DEVICES THAT HAVE BEEN ABANDONED OR ARE NOT PART OF THE NEW BUILDING SYSTEM.. PATCH AND REPAIR SURFACES TO MATCH ADJACENT SURFACES, TYPICAL.
- J. CAP WIRING AT ANY OUTLETS TO BE REMOVED.
- K. PANELS, SWITCHES, DEVICES IN WALLS TO BE DEMOLISHED ARE TO BE REMOVED PRIOR TO WALL REMOVAL. COORDINATE WITH ELECTRICAL DRAWINGS FOR ADDITIONAL INFORMATION.
- L. WHERE CEILING IS NOTED TO BE DEMOLISHED, REMOVE LIGHT FIXTURES. SEE ELECTRICAL DRAWINGS FOR ADDITIONAL INFORMATION.

- M. FLOORING/SLAB TO BE PATCHED WHERE EXISTING PLUMBING FIXTURES ARE PERMANENTLY REMOVED. FLOOR SURFACE/FINISH SHOULD BE PREPARED TO RECEIVED SCHEDULED FLOORING.
- N. WHERE EXISTING CEILING AND CEILING GRID/TRIM ARE TO BE DEMOLISHED AND NO NEW CEILING INSTALLED, WALL ABOVE EXISTING CEILING LINE WILL BE PATCHED/REPAIRED AS A RESULT OF DEMOLITION. WALLS WILL BE CLEANED AND PAINTED P-1, UNLESS NOTED OTHERWISE.
- ASBESTOS-CONTAINING MATERIALS (ACM) HAVE NOT BEEN IDENTIFIED AT THIS SITE; HOWEVER SUSPECT ASBESTOS-CONTAINING MATERIALS MAY STILL BE PRESENT. IMMEDIATELY UPON DISCOVERY OF ANY SUSPECT ACM OR OTHER HAZARDOUS MATERIALS, STOP WORK AND DO NOT CARRY ON ANY ACTIVITY IN THAT AREA WHICH COULD DISTURB THE SUSPECTED ACM OR OTHER HAZARDOUS MATERIALS. NOTIFY THE ARCHITECT IMMEDIATELY. IN SUCH AN EVENT, THE ARCHITECT WILL EVALUATE CIRCUMSTANCES AND INSTRUCT CONTRACTOR ON HOW AND WHEN TO PROCEED. INSTRUCT WORKERS ONSITE TO BE ALERT FOR MATERIALS THAT MAY CONTAIN ASBESTOS OR OTHER HAZARDOUS MATERIALS, AND NOT TO DISTURB OR ATTEMPT TO REMOVE SUCH MATERIALS. TAKE PRECAUTIONS TO PREVENT SPREAD OF ASBESTOS FIBERS OR OTHER HAZARDOUS MATERIALS THROUGHOUT THE PROJECT. DO NOT BREAK UP OR ATTEMPT TO REMOVE FROM THE SITE ANY MATERIALS SUSPECTED OF CONTAINING ASBESTOS OR OTHER HAZARDOUS MATERIALS ASBESTOS-CONTAINING MATERIALS OR OTHER HAZARDOUS MATERIALS CARRIED AROUND THE WORK AREA OR INTO THE EXISTING BUILDING(S) DUE THE CONTRACTOR'S CARELESSNESS OR FAILURE TO FOLLOW ABOVE PROCEDURAL PRECAUTIONS SHALL BE REMEDIATED AT THE CONTRACTOR'S

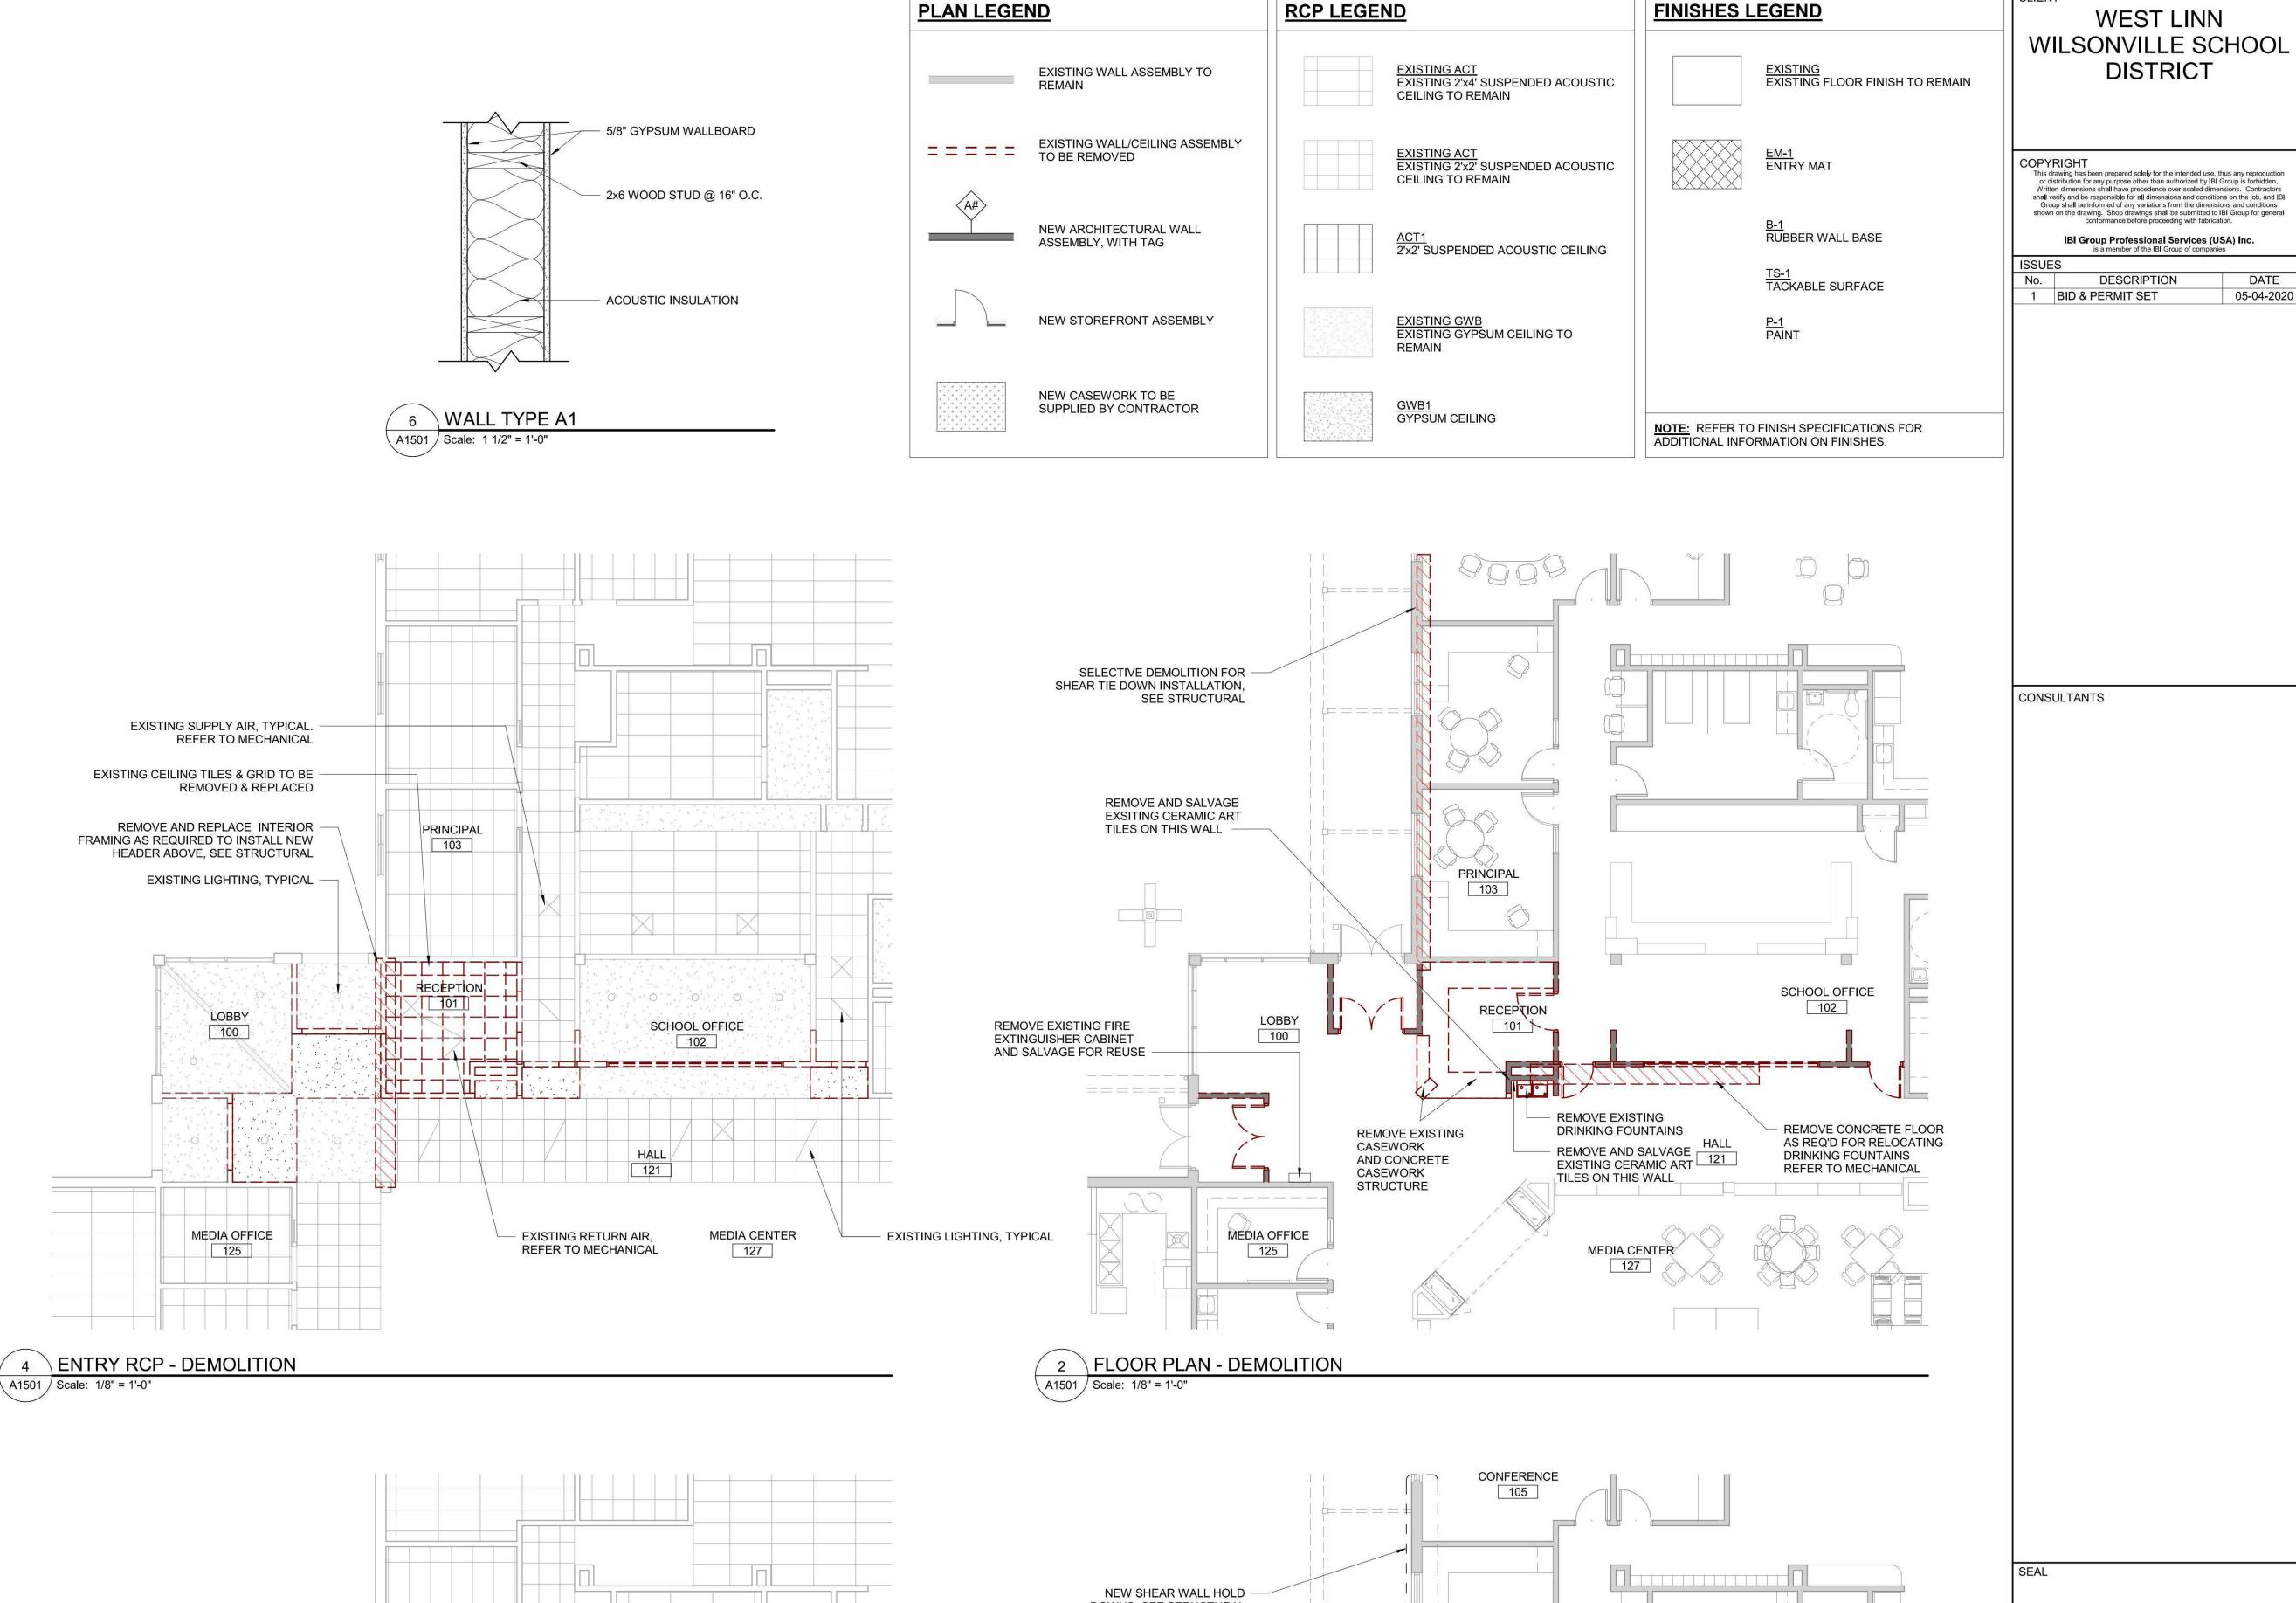

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conformance before proceeding with fabrication.

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Portland, OR 97205, USA

BOONES FERRY PRIMARY

SCHOOL SECURITY UPGRADES

11495 SW Wilsonville Rd

Wilsonville, OR 97070

ENTRY PLANS, RCPS AND **FINISH PLAN** 

A1501

WL BID PACK 19045.009

CHECKED BY:

APPROVED BY:

ISSUE

124743

DRAWN BY:

PROJECT MGR:

SHEET TITLE


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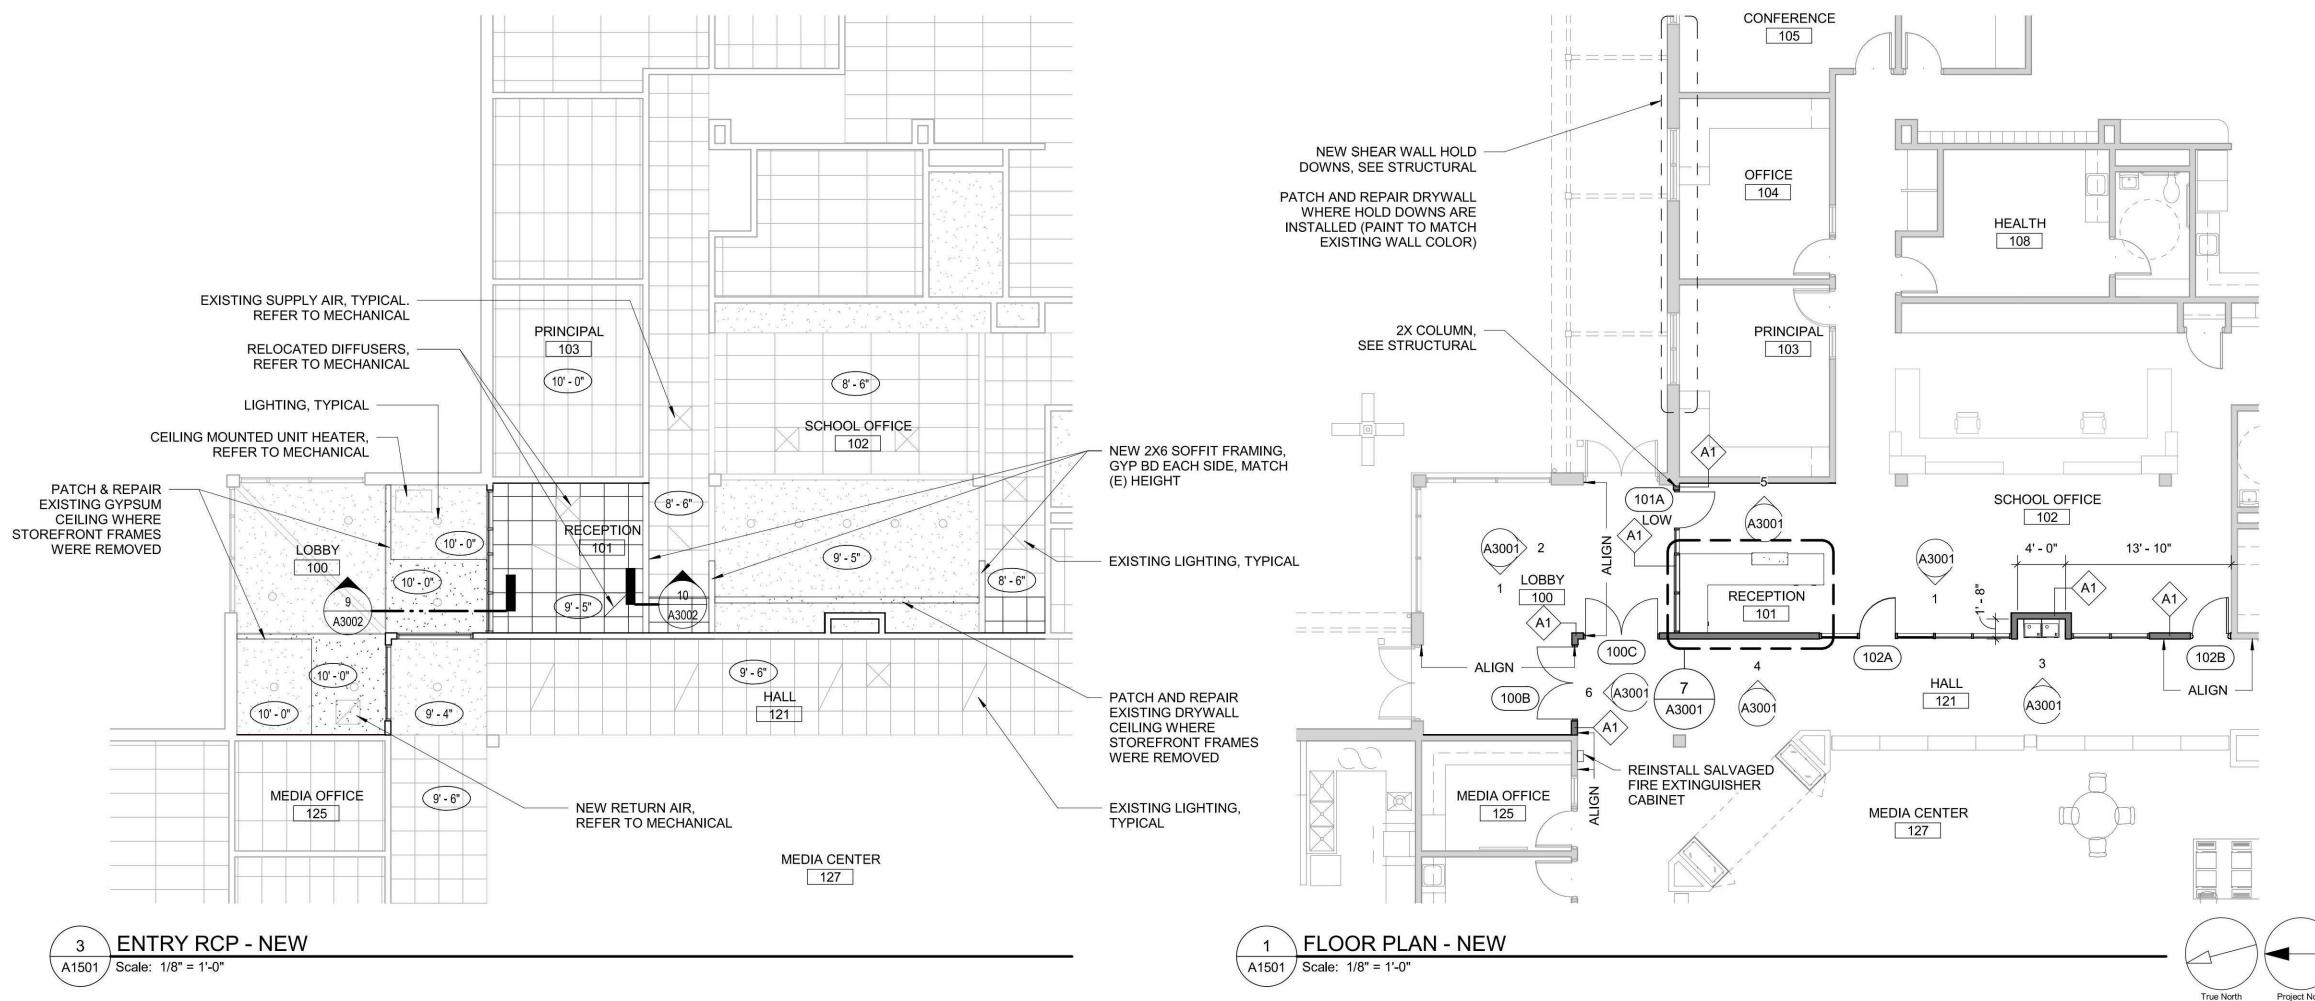
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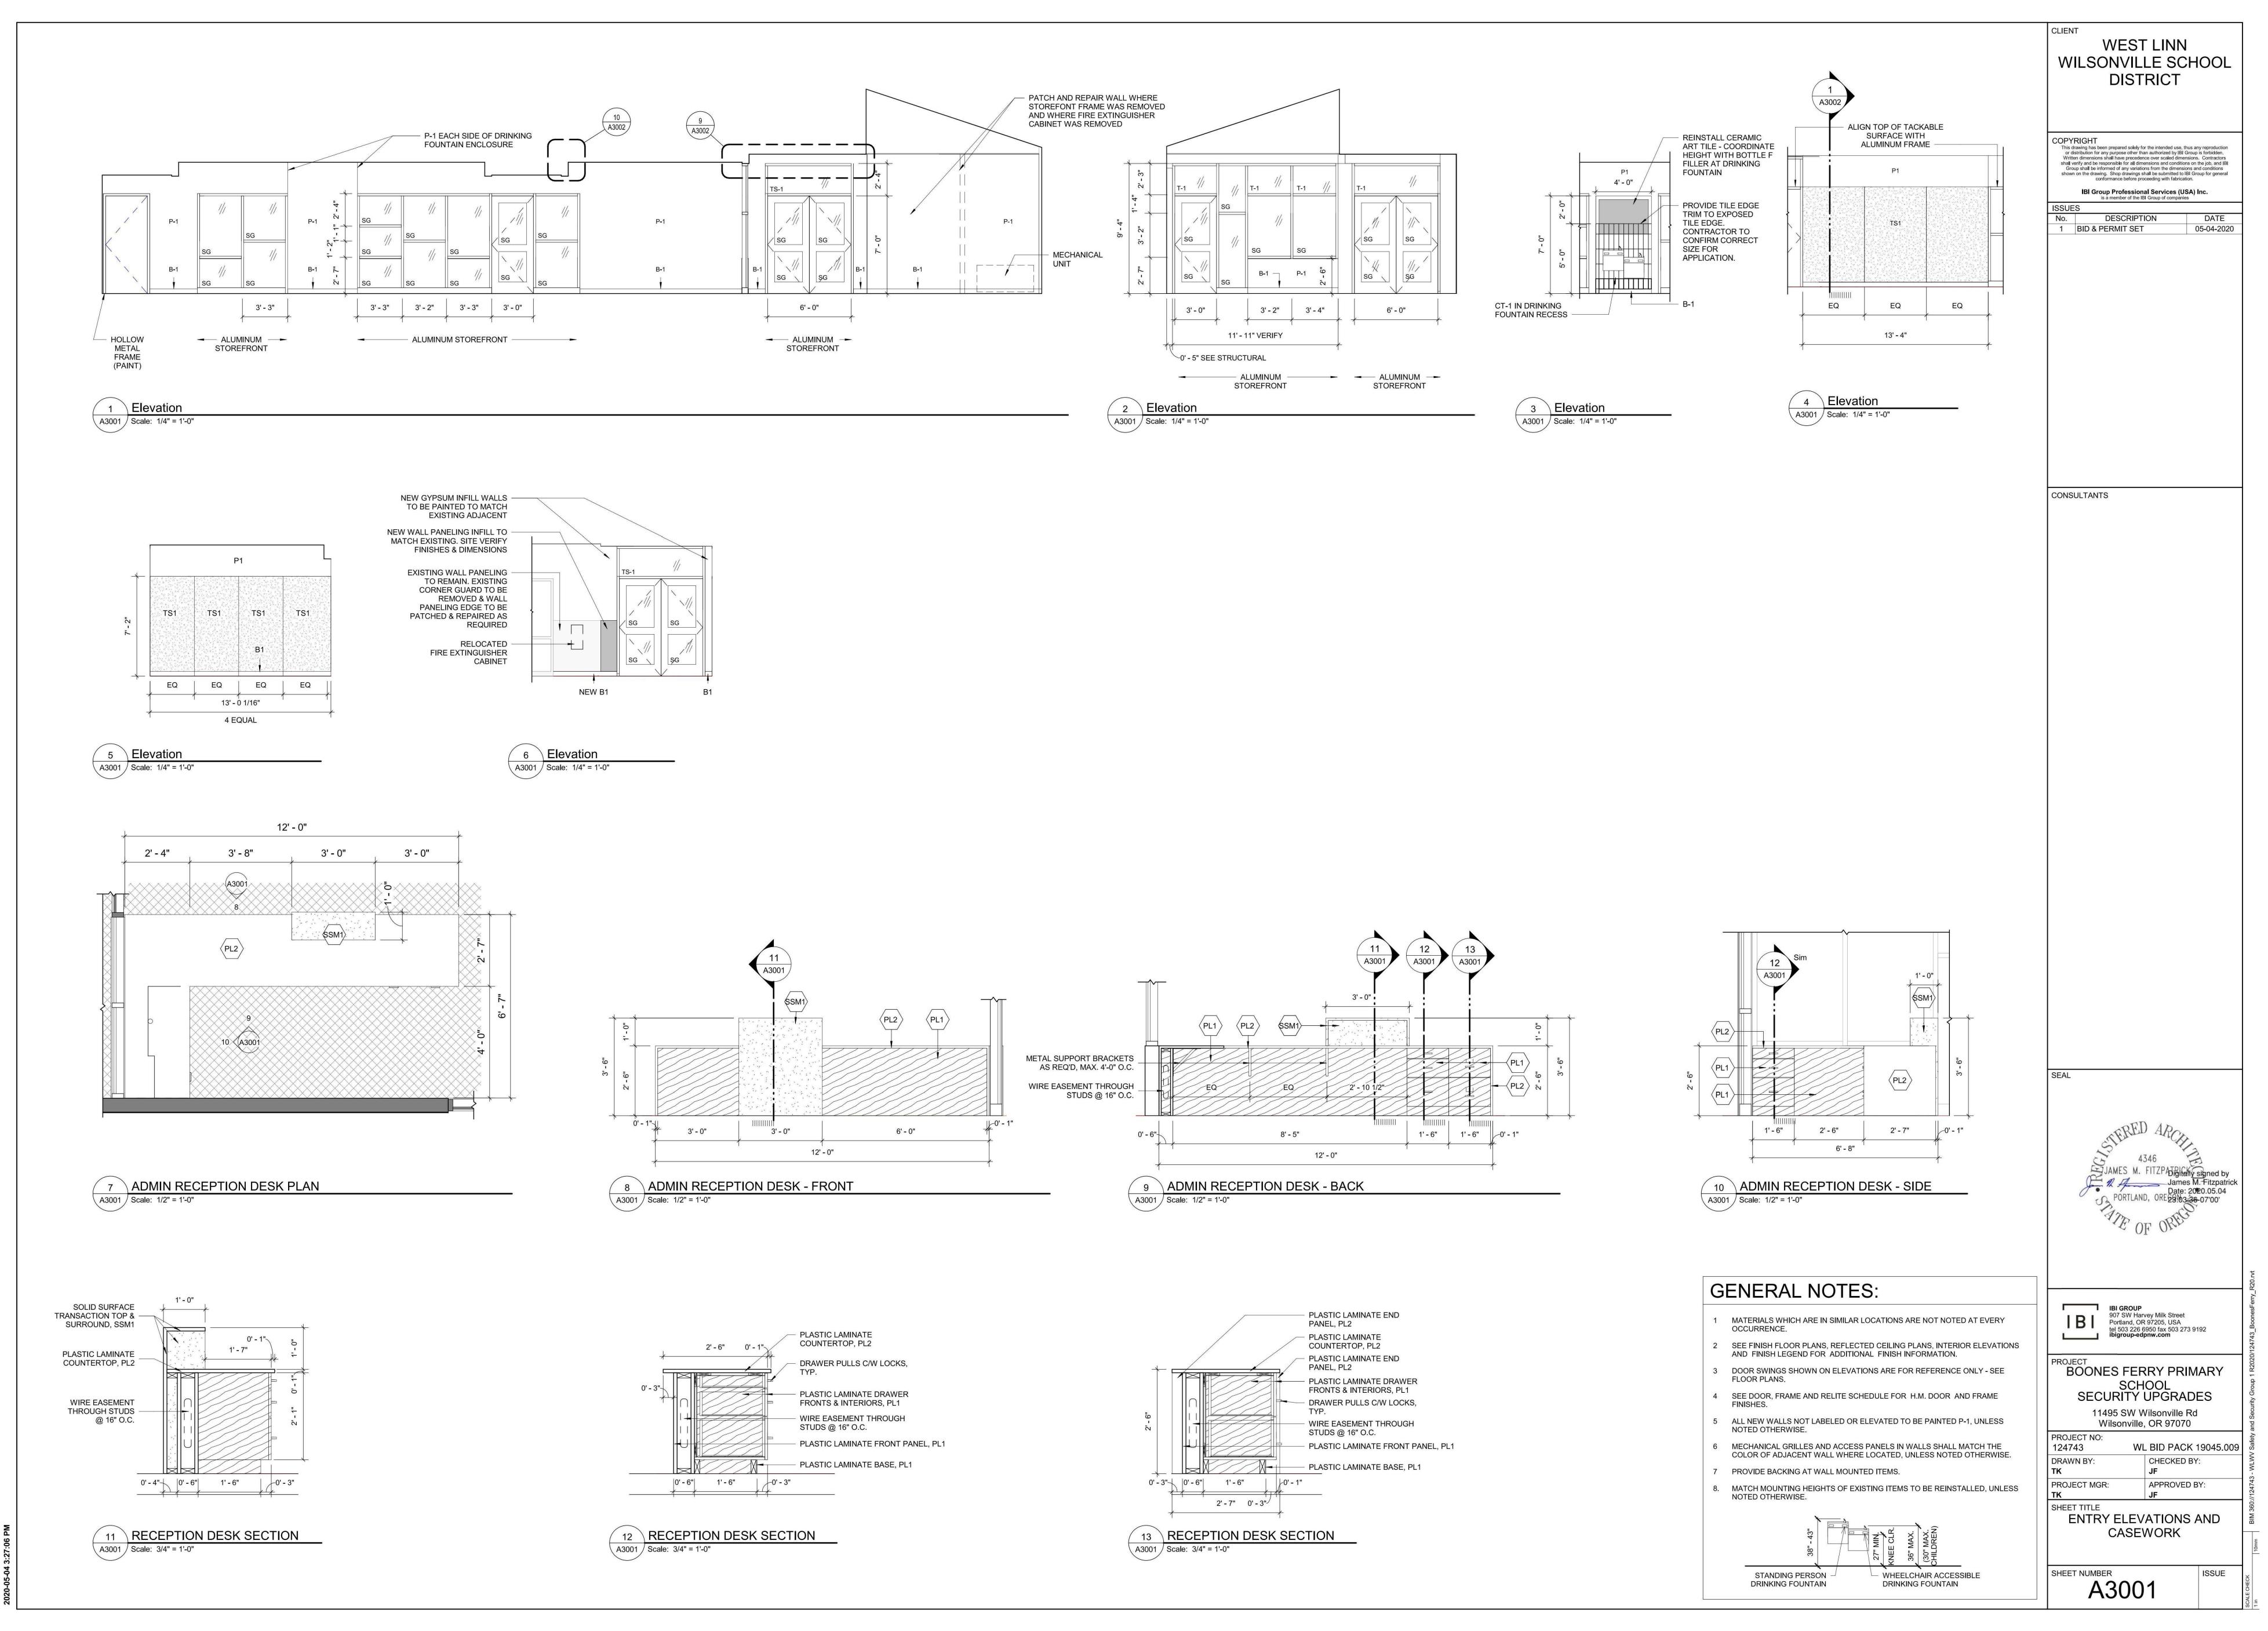
05-04-2020


DESCRIPTION

**BID & PERMIT SET** 





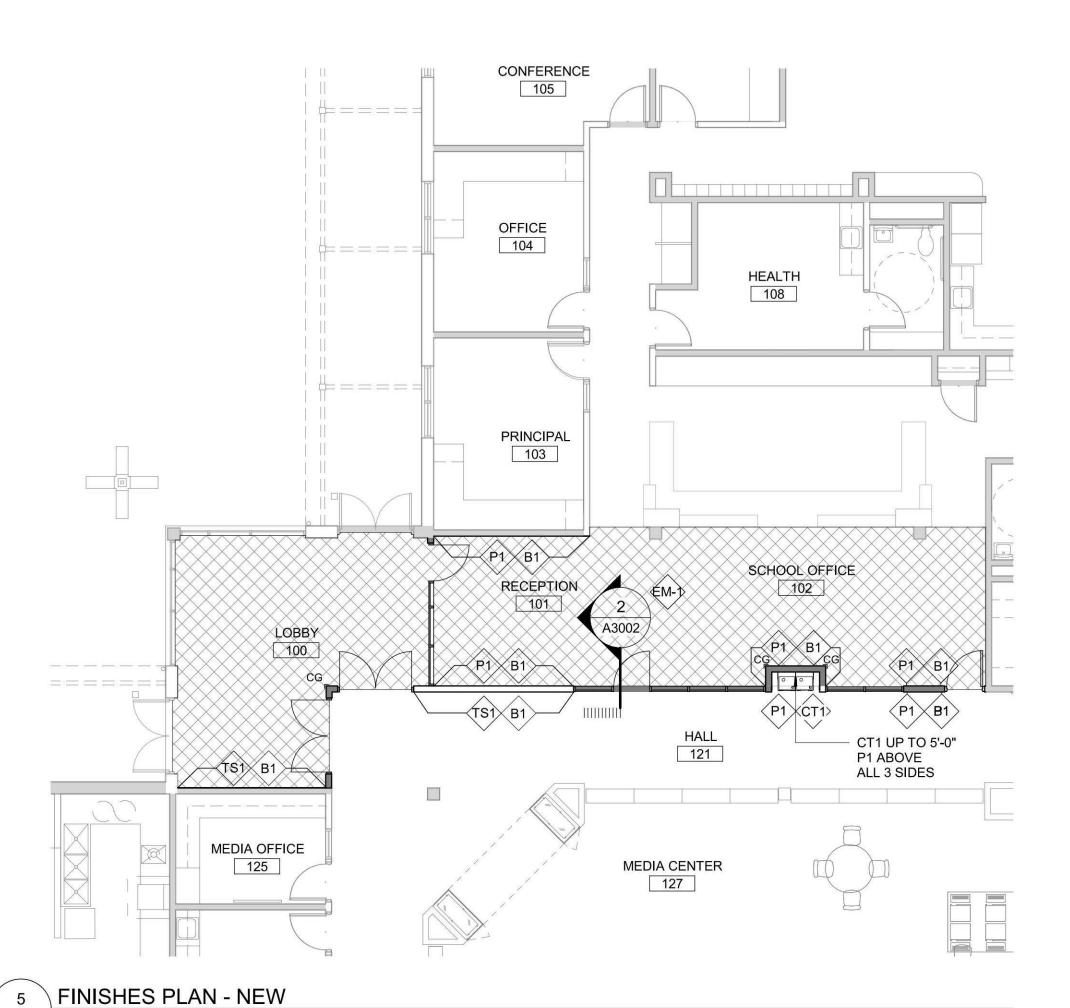

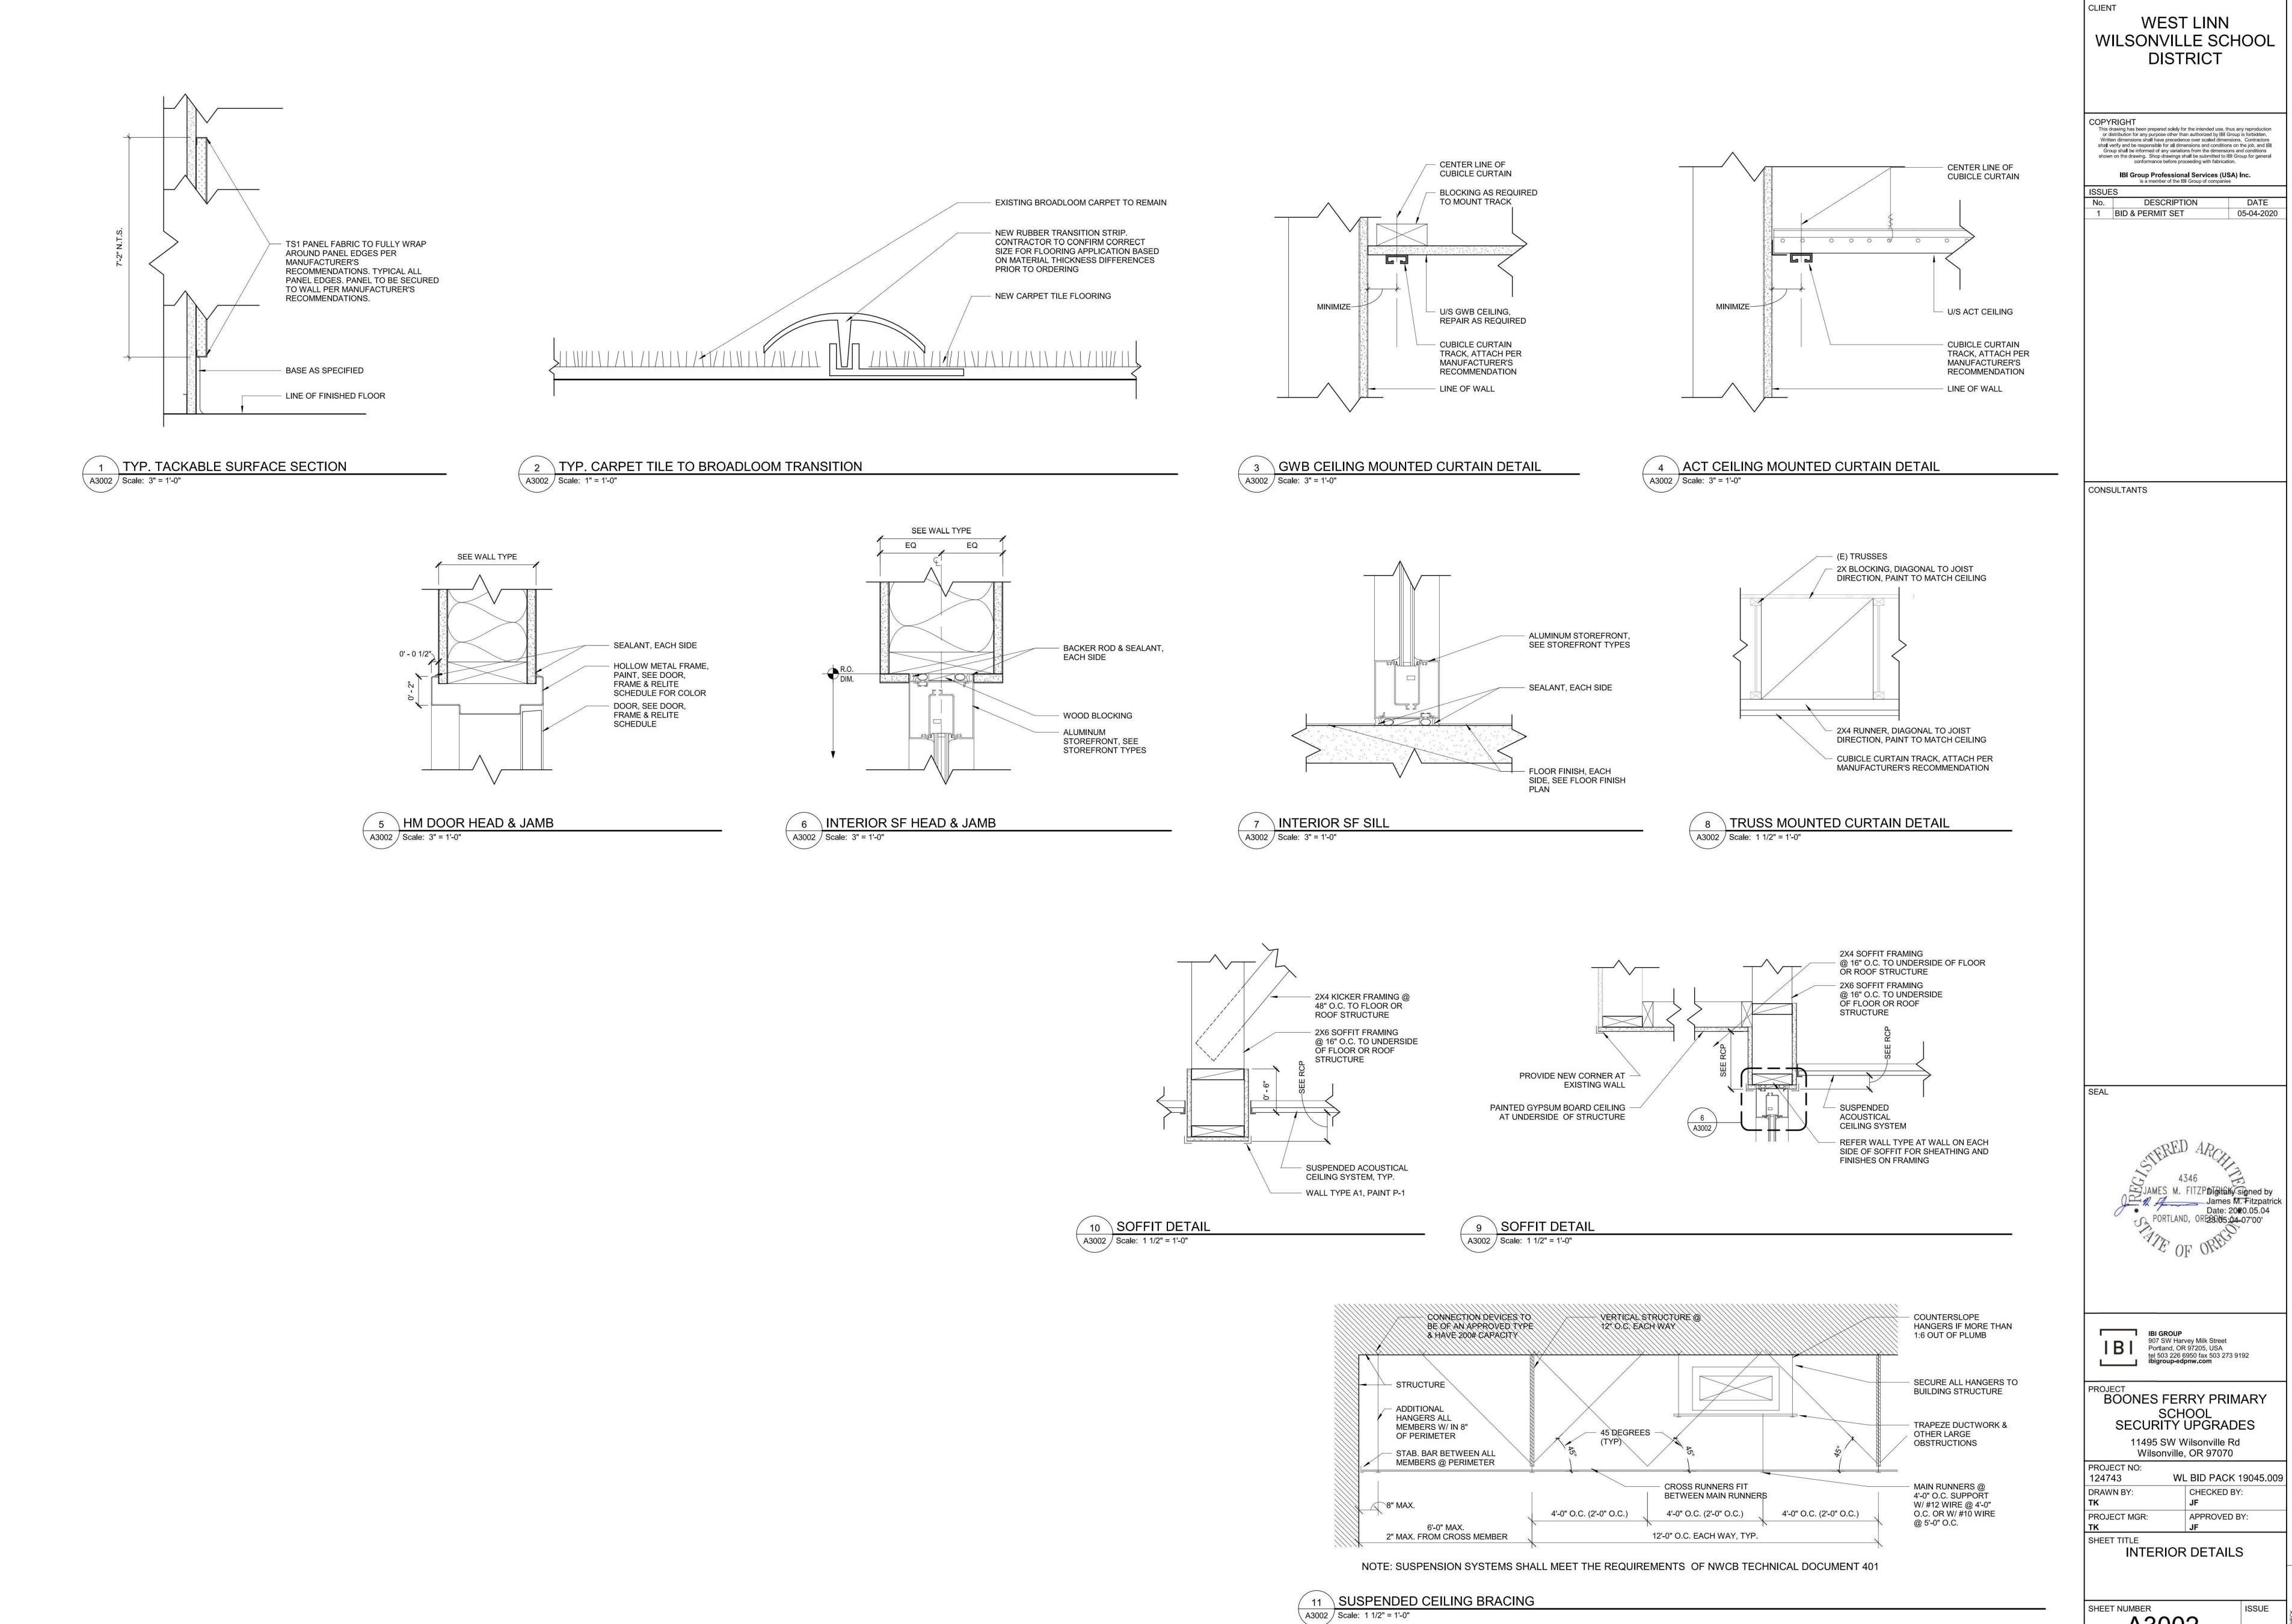

A3002

	Door	Frame	Fire Rating	***************************************	
No.	Туре	Туре	(minutes)	Hardware	Comments
EVEL 0	11		,	¥. <del>2000000000000000000000000000000000000</del>	
113B	(E)	(E)	NA	01	1.,2.
116A	(E)	(E)	(E)	02	1.,2.
120A	(E)	(E)	(E)	01	1.
130A	(E)	(E)	(E)	01	1.
132A	(E)	(E)	(E)	02	1.,2.
133A	(E)	(E)	(E)	01	1.
138A	(E)	(E)	(E)	01	1.
301A	(E)	(E)	(E)	01	1.
302A	(E)	(E)	(E)	01	1.
303A	(E)	(E)	(E)	01	1.
304A	(E)	(E)	(E)	01	1.
401A	(E)	(E)	(E)	01	1.
402A	(E)	(E)	(E)	01	1.
403A	(E)	(E)	(E)	01	1.
404A	(E)	(E)	(E)	01	1.
501A	(E)	(E)	(E)	01	1.
502A	(E)	(E)	(E)	01	1.
503A	(E)	(E)	(E)	01	1.
504A	(E)	(E)	(E)	01	1.
601A	(E)	(E)	(E)	01	1.
602A	(E)	(E)	(E)	01	1.
603A	(E)	(E)	(E)	01	1.
604A	(E)	(E)	(E)	01	1.
801A	(E)	(E)	(E)	01	1.
802A	(E)	(E)	(E)	01	1.
803A	(E)	(E)	(E)	01	1.
804A	(E)	(E)	(E)	01	1.
901A	(E)	(E)	(E)	01	1,
902A	(E)	(E)	(E)	01	1,
903A	(E)	(E)	(E)	01	1.
904A	(E)	(E)	(E)	01	1.
001A	(E)	(E)	(E)	01	1.
1002A	(E)	(E)	(E)	01	1.
1003A	(E)	(E)	(E)	01	1.
004A	(E)	(E)	(E)	01	1.
101A	(E)	(E)	(E)	01	1.
102A	(E)	(E)	(E)	01	1.
103A	(E)	(E)	(E)	01	1.
104A	(E)	(E)	(E)	01	1.


#### NOTES:


1. EXISTING DOOR AND FRAME TO REMAIN "AS IS" EXCEPT FOR NEW HARDWARE. SIZE SHOWN FOR FOR CLARITY ONLY.
2. NOT USED

SEQUENCING OF ADA BUTTONS AND DOORS										
#	LOCATION	DOORS								
1	EXTERIOR	A100A and A101A								
2	LOBBY	A100A, A101A and A100C								
3	RECEPTION	A101A								
4	LOBBY/HALLWAY	A100C								

SECURITY BUTTONS - LC	CATED AT RECEPTION
SECURITY BUTTON A	RELEASE OF 100C
SECURITY BUTTON B	RELEASE OF 101A, 102A



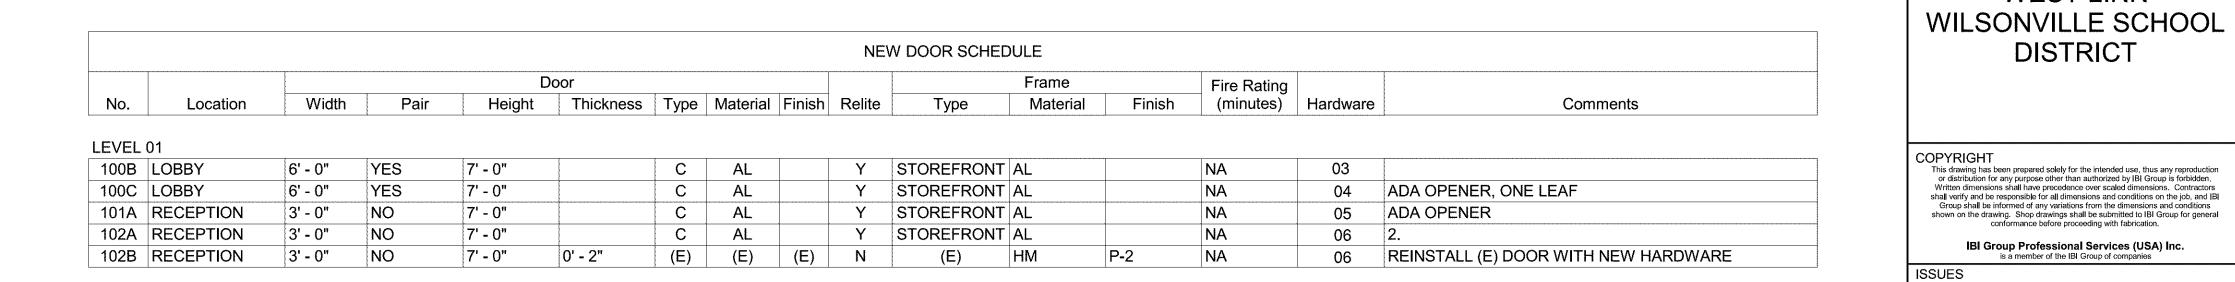

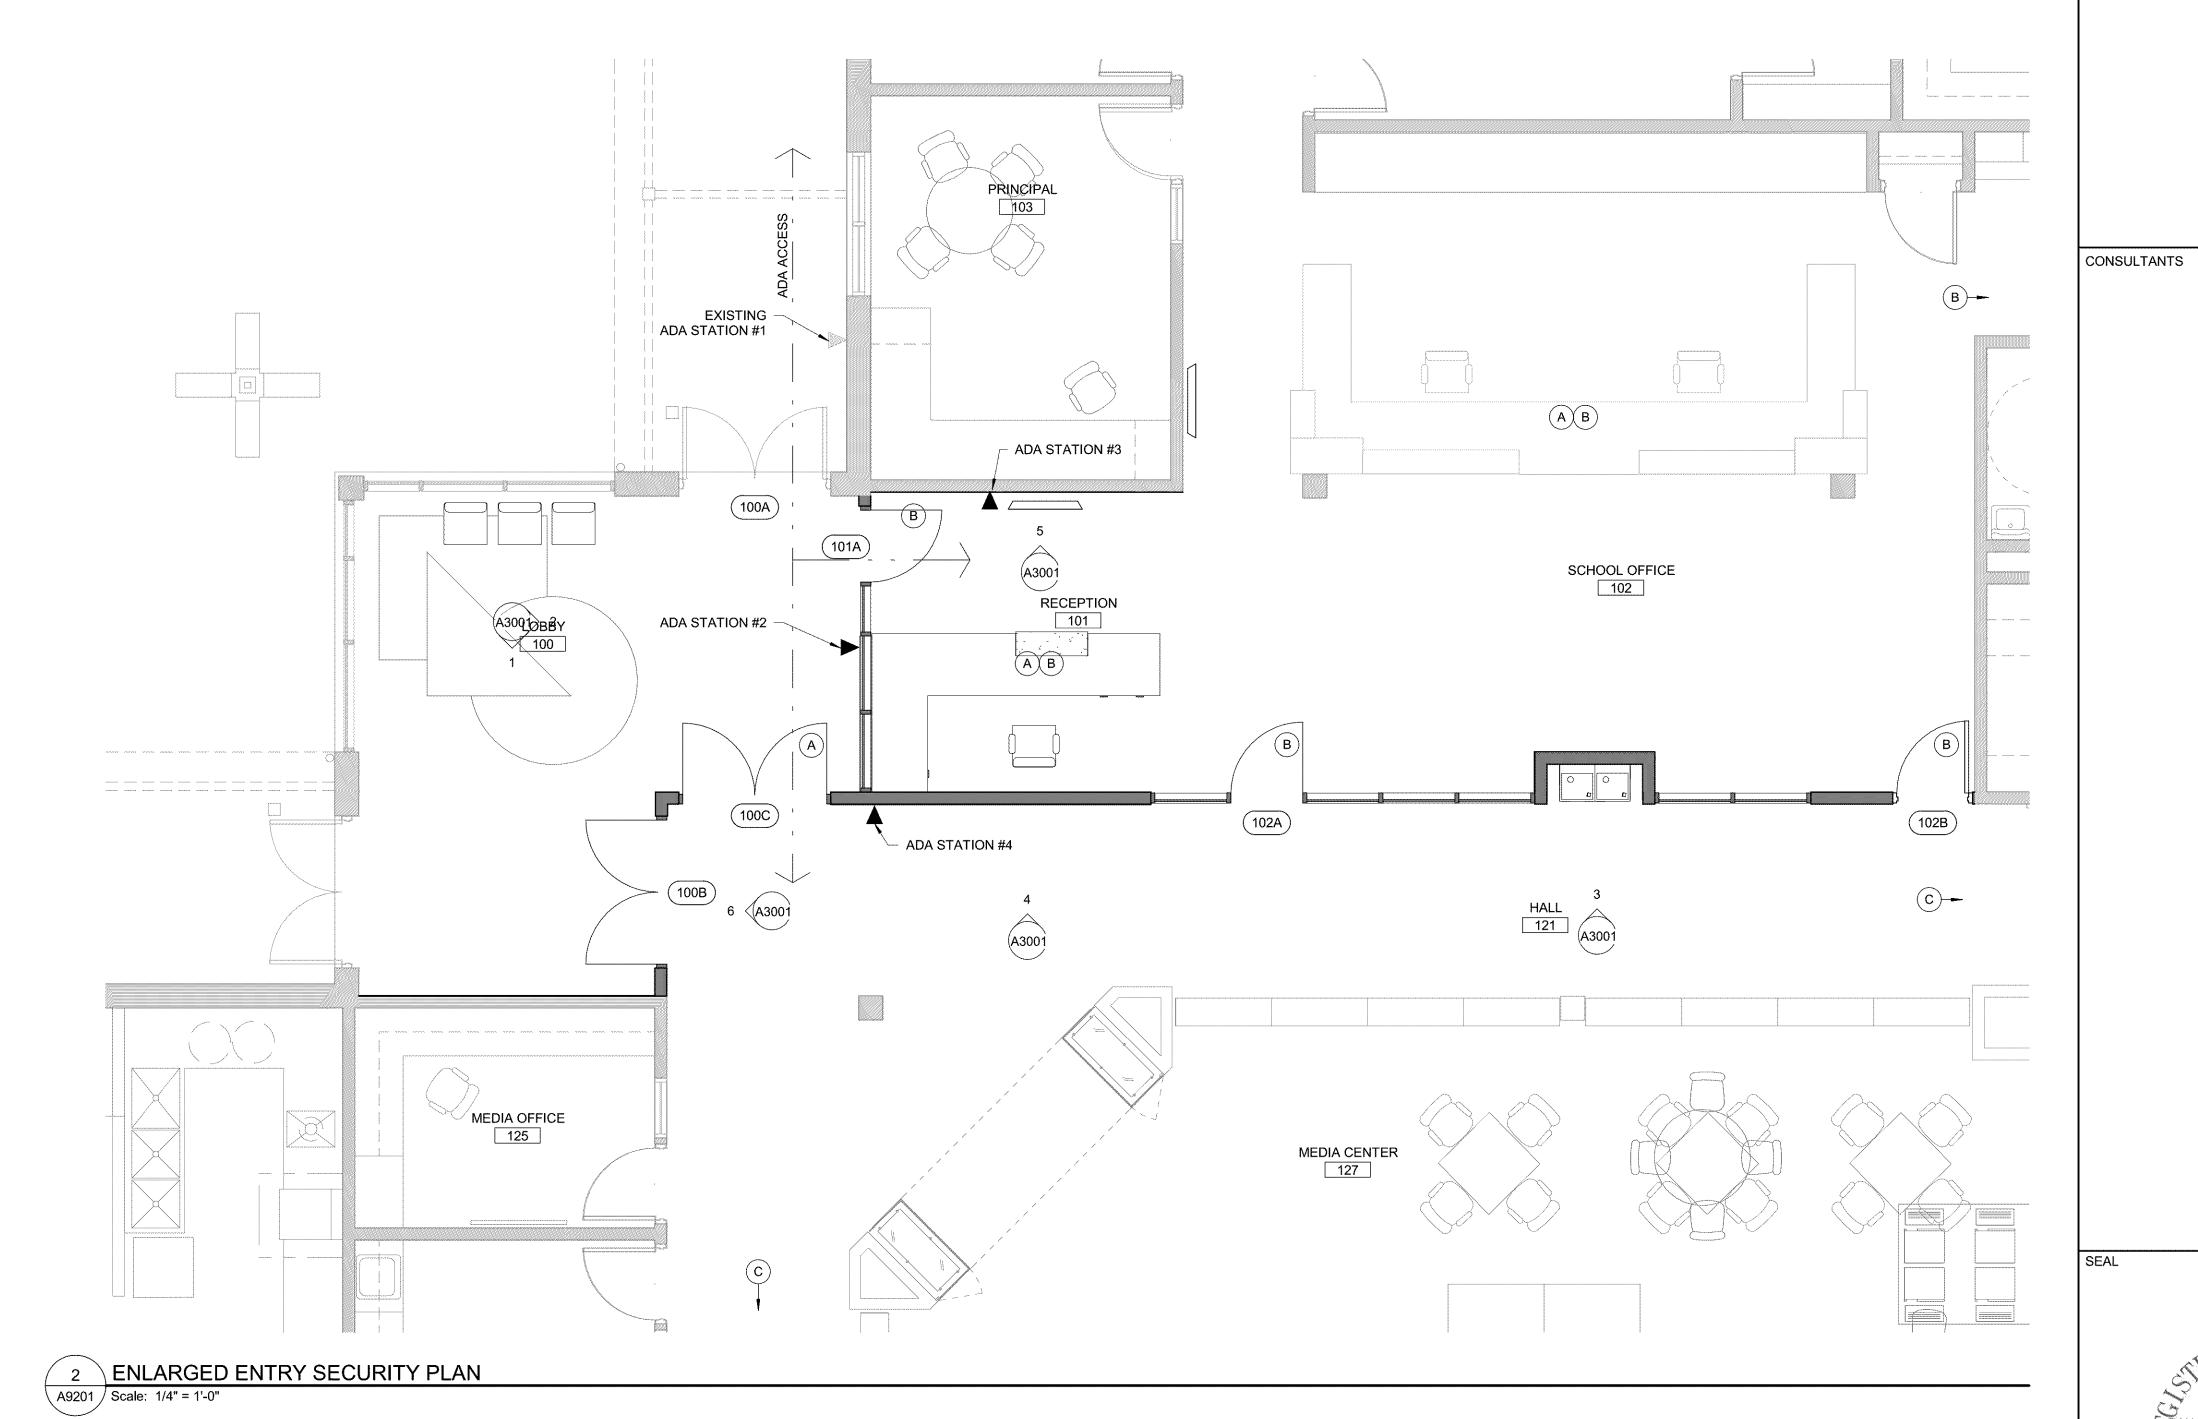

## NOTES:

- 1. ALL SECURITY GLAZING TO EXTEND 7' A.F.G.
- 2. ALL STOREFRONT FRAME COLOR AND FINISH TO MATCH EXISTING
- 3. VERIFY IN FIELD ALL ROUGH OPENINGS.

BOONES FERRY PRIMARY SCHOOL SECURITY UPGRADES 11495 SW Wilsonville Rd Wilsonville, OR 97070

CLIENT

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DISTRICT

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05-04-2020

DESCRIPTION

1 BID & PERMIT SET

WL BID PACK 19045.009 CHECKED BY: APPROVED BY: PROJECT MGR:

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DOOR SCHEDULE, TYPES & SECURITY PLANS

SHEET NUMBER A9201

## WEST LINN WILSONVILLE SCHOOL DISTRICT

# BOONES FERRY PRIMARY SCHOOL

## **SAFETY & SECURITY GROUP 1A** WL BID PACK 19045.009

11495 SW Wilsonville Rd Wilsonville, OR 97070


#### PROJECT DESCRIPTION

THERE ARE THREE DISTINCT PORTIONS OF WORK, ALL RELATED TO UPGRADING STUDENT AND STAFF SAFETY

1. REMODEL MAIN ENTRY AND RECEPTION AREA TO PROVIDE SECURE VESTIBULE AND CONTROLLED ENTRY SEQUENCE FOR VISITORS. THIS INCLUDES DOOR HARDWARE WITH LOW-VOLTAGE CONTROLS AND INSTALLATION OF IMPACT

2. INSTALLATION OF REMOTELY TRIGGERED LOCKDOWN DOOR HARDWARE AT SELECT DOORS, PRIMARILY AT CLASSROOM

3. INSTALLATION OF OPAQUE CUBICLE CURTAINS AT INTERIOR WINDOWS OF CLASSROOM AND OTHER STUDENT OCCUPIED ROOMS.

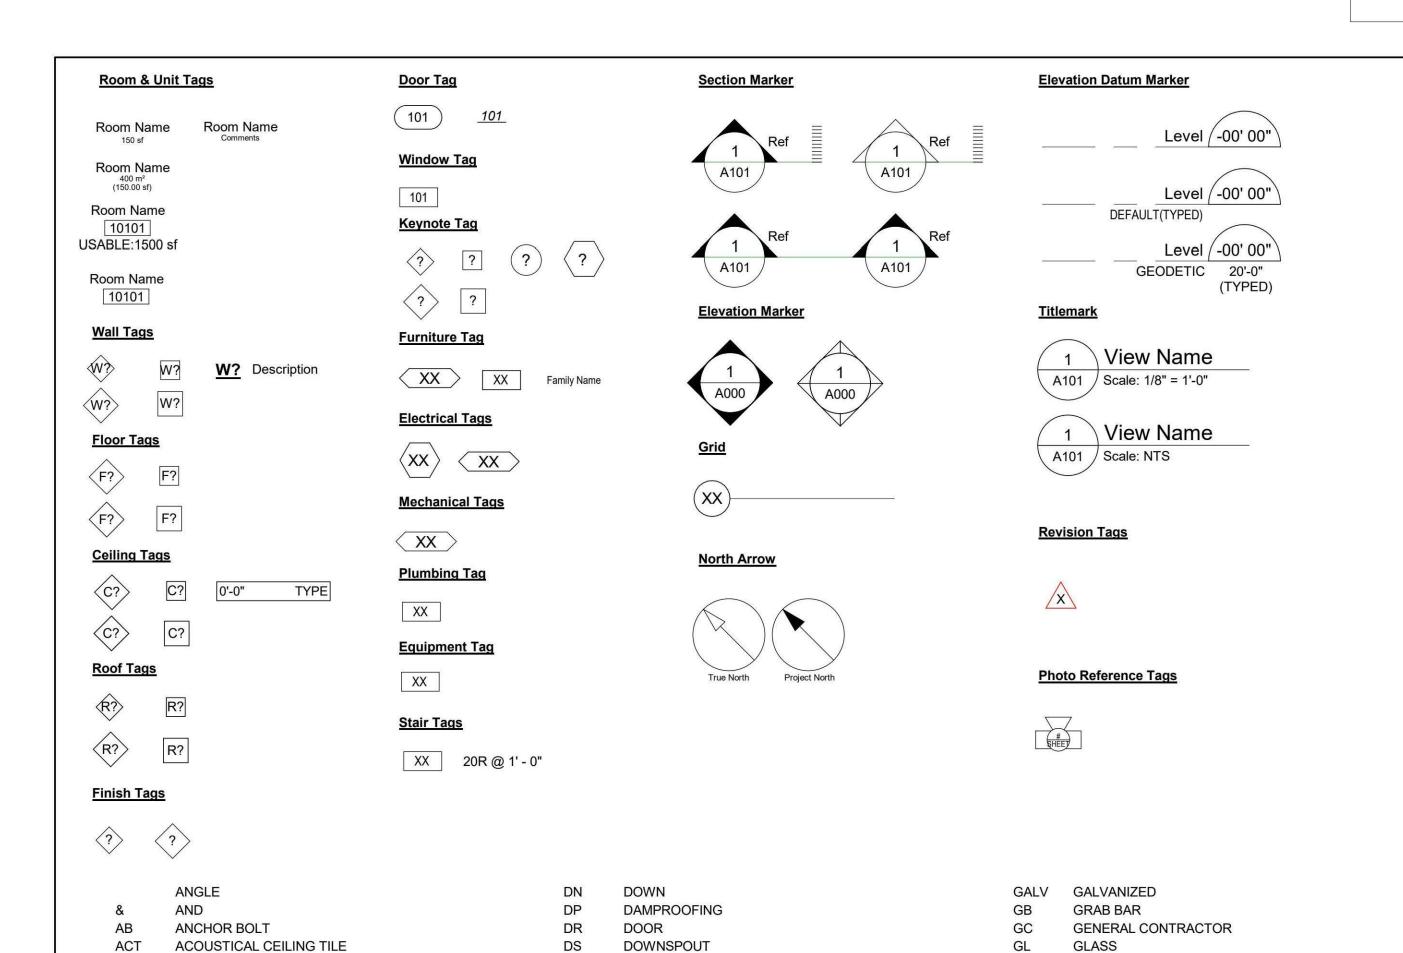

DWG DRAWING

**EXISTING** 

**EXHAUST FAN** 

**ELEVATION** 

**EACH WAY EXPANSION** 

FIRE ALARM

FDN FOUNDATION

FLOOR DRAIN

FINISH FLOOR

**FLOOR** 

FOF FACE OF FINISH

FOS FACE OF STUD

FTG FOOTING

FURR FURRING

GA GAUGE

FIRE EXTINGUISHER

FACE OF CONCRETE

FACE OF MASONRY

FRT FIRE RETARDANT TREATED

FIRE EXTINGUISHER CABINET

ELEC ELECTRICAL

ENGR ENGINEER

EQUIP EQUIPMENT

EQ EQUAL


FD

FF

FL

EOS EDGE OF SLAB

**EXPANSION JOINT** 

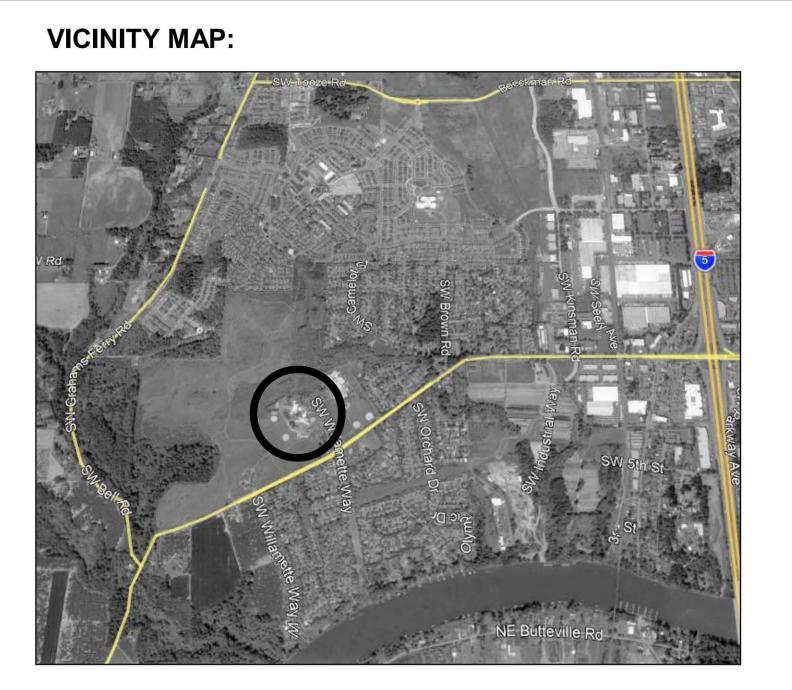

SEISMIC JOINT

SHEET METAL

STAINLESS STEEL

TEMPERED GLAZING

**SQUARE** 

TO MATCH

THICK

TOP OF CURB

**TELEPHONE** 

**TOOL JOINT** 

#### NOT IN CONTRACT **NELSON STUD** NOT TO SCALE STD STANDARD STL STEEL ON CENTER STOR STORAGE OUTSIDE DIAMETER STRUCT STRUCTURAL OVERFLOW DRAIN OWNER FURNISHED CONTRACTOR INSTALLED SUSP SUSPENDED OWNER FURNISHED OWNER INSTALLED **OVERHEAD** T&G TONGUE AND GROOVE OPNG OPENING OPP OPPOSITE OS OUTSIDE PL PROPERTY LINE PLAS PLASTER PLYWD PLYWOOD PSF PER SQUARE FOOT PT PRESSURE TREATED PVMT PAVEMENT **RADIUS** RCP REFLECTED CEILING PLAN **ROOF DRAIN**

TOP OF TOP OF DECK TOP OF STRUCTURE **TOILET PAPER** TUBE STEEL **TYPICAL** UNFIN UNFINISHED REFERENCE UNO UNLESS NOTED OTHERWISE REFR REFRIGERATOR VAPOR BARRIER VERT VERTICAL REQ'D REQUIRED REV REVISE OR REVISION VEST VESTIBULE RO ROUGH OPENING WITH WITHOUT SAHTS SELF-ADHERED HIGH TEMPERATURE SHEET SAM SELF-ADHERED MEMBRANE WATER CLOSET SC SOLID CORE WOOD WIDE FLANGE SECTION SQUARE FOOT WATER HEATER SHEET WATERPROOFING SHTG SHEATHING WRB WATER-RESISTIVE BARRIER WEIGHT SHWR SHOWER WT

## SHEET INDEX

AG0000

Architecture **CODE PLAN - EXITING** OVERALL FIRST FLOOR PLAN ENTRY PLANS, RCPS AND FINISH PLAN **ENTRY ELEVATIONS AND CASEWORK** A3002 INTERIOR DETAILS

A9201 DOOR SCHEDULE, TYPES & SECURITY PLANS

Structural S0001 **COVER SHEET** 

S1501 FLOOR PLAN AND DETAILS

Mechanical

M0001 SYMBOLS, LEGENDS AND ABBREVIATIONS - MECHANICAL M1101 OVERALL FIRST FLOOR PLAN - MECHANICAL

M1501 **ENTRY PLANS - MECHANICAL** 

Plumbing P0001 SYMBOLS, LEGENDS AND ABBREVIATIONS - PLUMBING P1101 **OVERALL FIRST FLOOR PLAN - PLUMBING** 

**ENTRY PLANS - PLUMBING** 

Electrical E0001

P1501

SYMBOLS, LEGENDS AND ABBREVIATIONS - ELECTRICAL E1101 **OVERALL FIRST FLOOR PLAN - ELECTRICAL** 

E1501 **ENTRY PLANS - ELECTRICAL** 

Technology TG0001

T1601

SYMBOL LIST AND GENERAL NOTES - TECHNOLOGY

**OVERALL FIRST FLOOR PLAN - TECHNOLOGY** T1501 **ENTRY PLANS - TECHNOLOGY** 

**DETAILS - TECHNOLOGY** 

**WEST LINN** 

WILSONVILLE SCHOOL

DISTRICT

2455 COUNTRY CLUB ROAD LAKE OSWEGO, OR 97034

DESCRIPTION

1 BID & PERMIT SET

## **DELEGATED DESIGN**

#### Delegated Design components include, but are not limited to the following:

1. Aluminum Storefront, Section 08 43 13 - Aluminum-Framed Storefronts. Seismic Anchorage for Suspended Acoustical Ceilings, Section 09 51 00 - Suspended Acoustical Ceilings.

**ARCHITECTURE** 

PHONE: 503 226 6950

ADD ADDENDUM

ALUM ALUMINUM ANOD ANODIZED

BD BOARD

BLDG BUILDING

BLKG BLOCKING

BTWN BETWEEN

CLR CLEAR

CONT CONTINUOUS

CORR CORRIDOR

CSMT CASEMENT CT CERAMIC TILE

CTR CENTER

DBL DOUBLE

DIAG DIAGONAL

DIM DIMENSION

DISP DISPENSER

CR CLASSROOM

BM BENCH MARK

CB CATCH BASIN

CG CORNER GUARD

AESS ARCHITECTURAL EXPOSED STRUCTURAL STEEL

ABOVE FINISH FLOOR

CCTV CLOSED CIRCUIT TELEVISION

CIP CAST IN PLACE CONCRETE

CMU CONCRETE MASONRY UNIT

CSJ CONSTRUCTION JOINT

DF DRINKING FOUNTAIN

CONTROL JOINT

CENTERLINE

ALS AREA LIGHT STANDARD

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STRUCTURAL FROELICH ENGINEERS Froelich Engineers Inc. 17700 SW Upper Boones Ferry Rd.

PHONE: 503 624 7005

**MECHANICAL** #1500 - 522 SW 5th Ave Portland, OR 97204, USA NAME: Paul Ganz

PHONE: 503 226 2921

**ELECTRICAL** 

#1500 - 522 SW 5th Ave Portland, OR 97204, USA NAME: Mike Streb EMAIL: paul.ganz@pae-engineers.com EMAIL: mike.streb@pae-engineers.com EMAIL: darcyt@vertex-tech.com PHONE: 503 226 2921

LOW VOLTAGE / SECURITY 25085 SW Rainbow LN

GYPSUM VENEER PLASTER

HIGH PERFORMANCE COATING

HEATING, VENTILATION, AND AIR CONDITIONING

GYPSUM WALL BOARD

**HANDICAP** 

INSULATION

**JOINT** 

**LENGTH** 

LAVATORY

LAG BOLT

LANDSCAPING

**MARKERBOARD** 

MANUFACTURER

**MISCELLANEOUS** 

NOT APPLICABLE

**MECHANICAL** 

**MEZZANINE** 

**MIRROR** 

MOUNTED

**NEW** 

MTL

LOCKER

LOUVER

MATERIAL

MAXIMUM


**HOLLOW METAL** 


Hillsboro, OR, 97123, USA NAME: Darcy Tucker PHONE: 503 201 6568

PRIME CONSULTANT IBI GROUP 907 SW Harvey Milk Street Portland, OR 97205, USA tel 503 226 6950 fax 503 273 9192 PROJECT NO:

124743

MAY 4, 2020 SHEET NUMBER AG0000

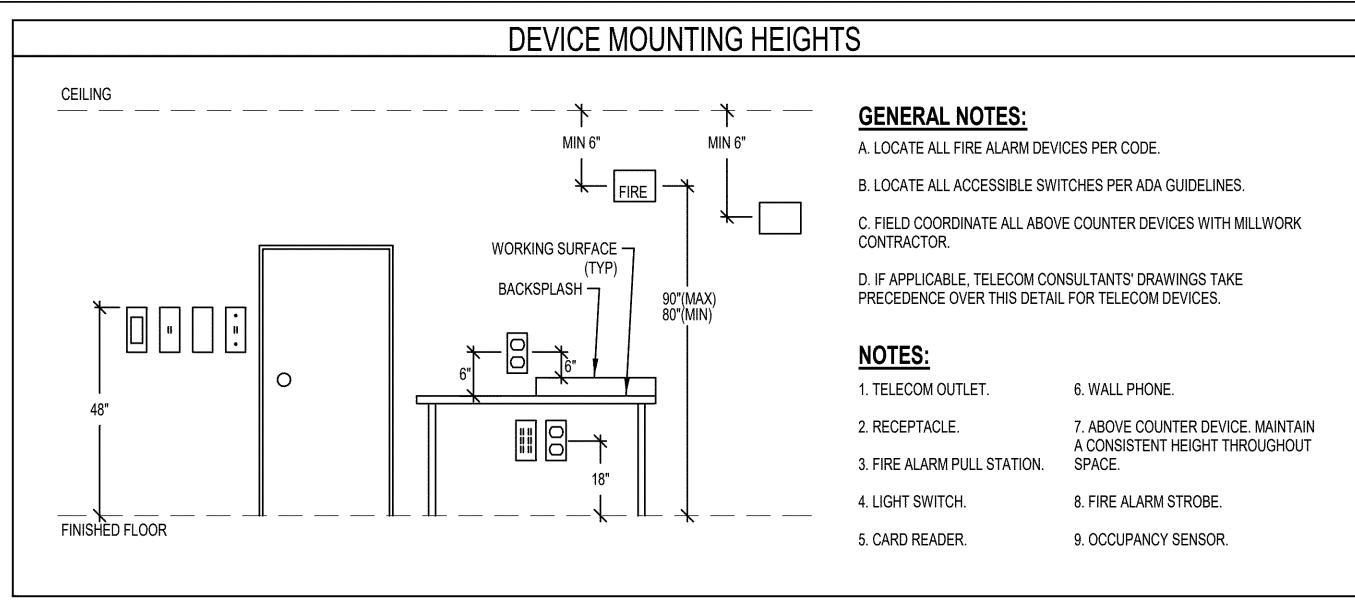

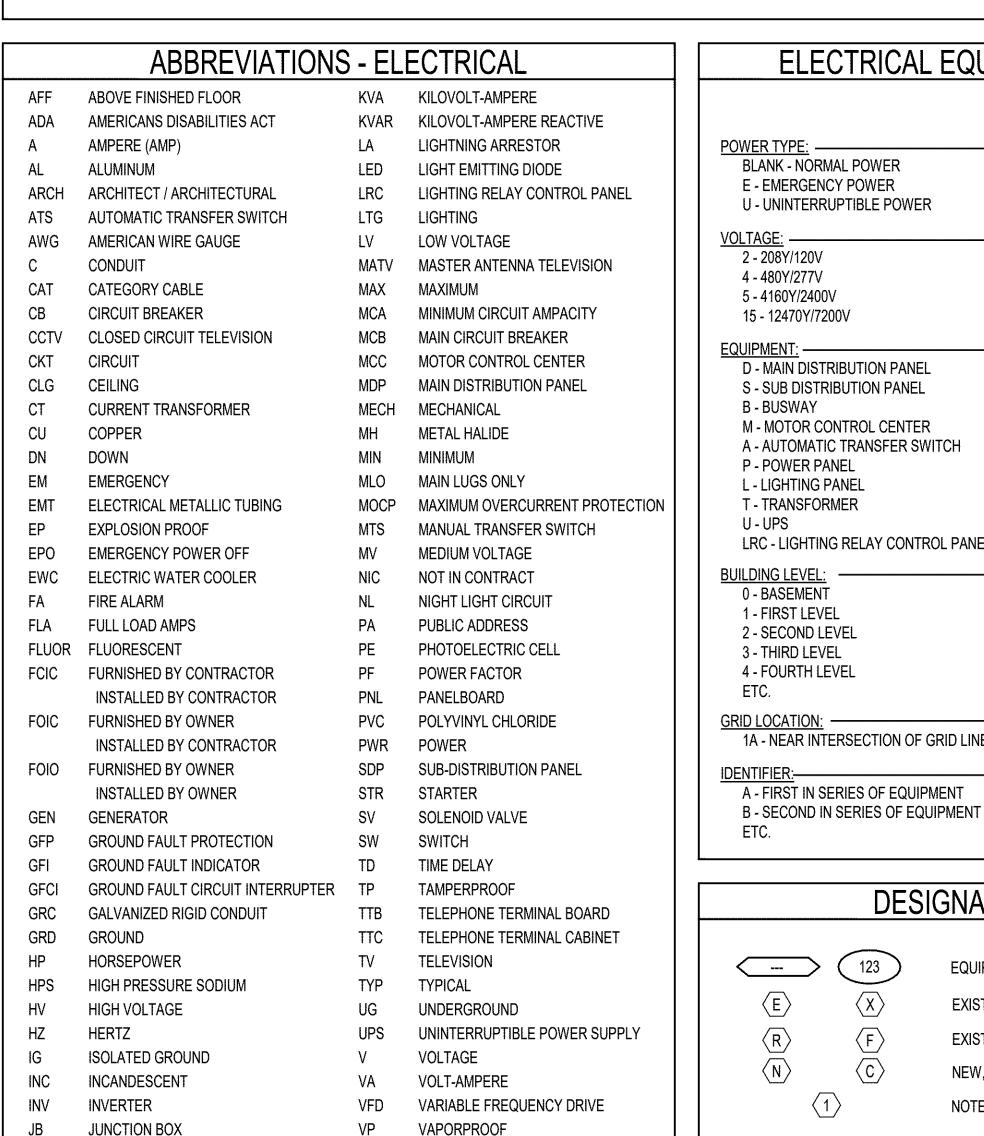

WATTS


WP WEATHERPROOF


XFMR TRANSFORMER


KW KILOWATT

KV KILOVOLT

KWH KILOWATT HOUR

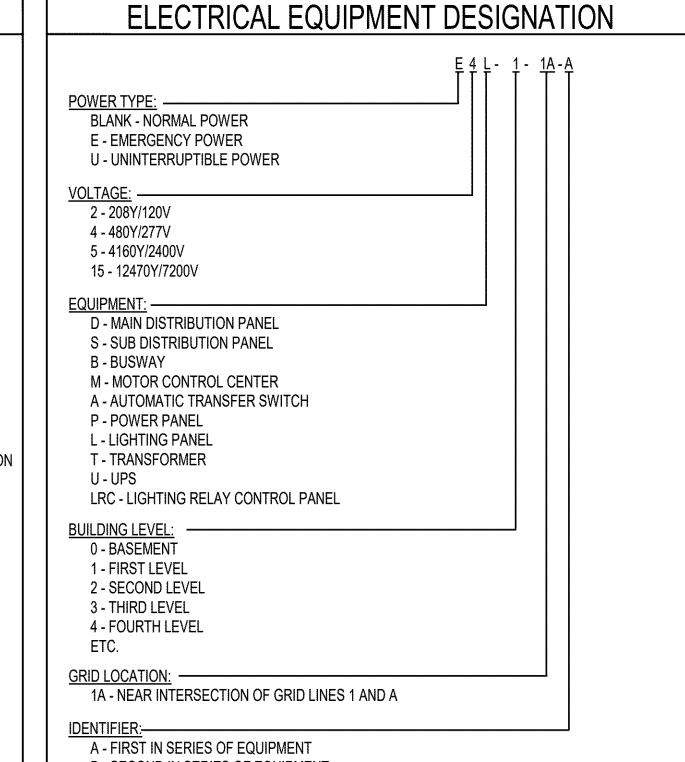


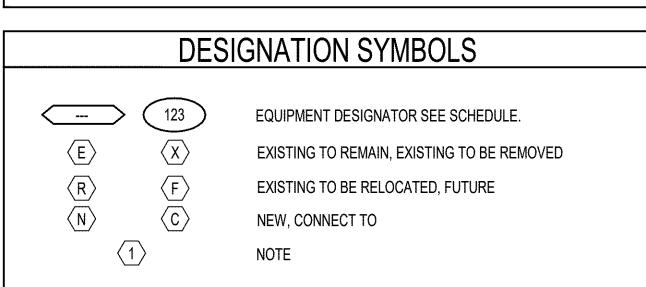

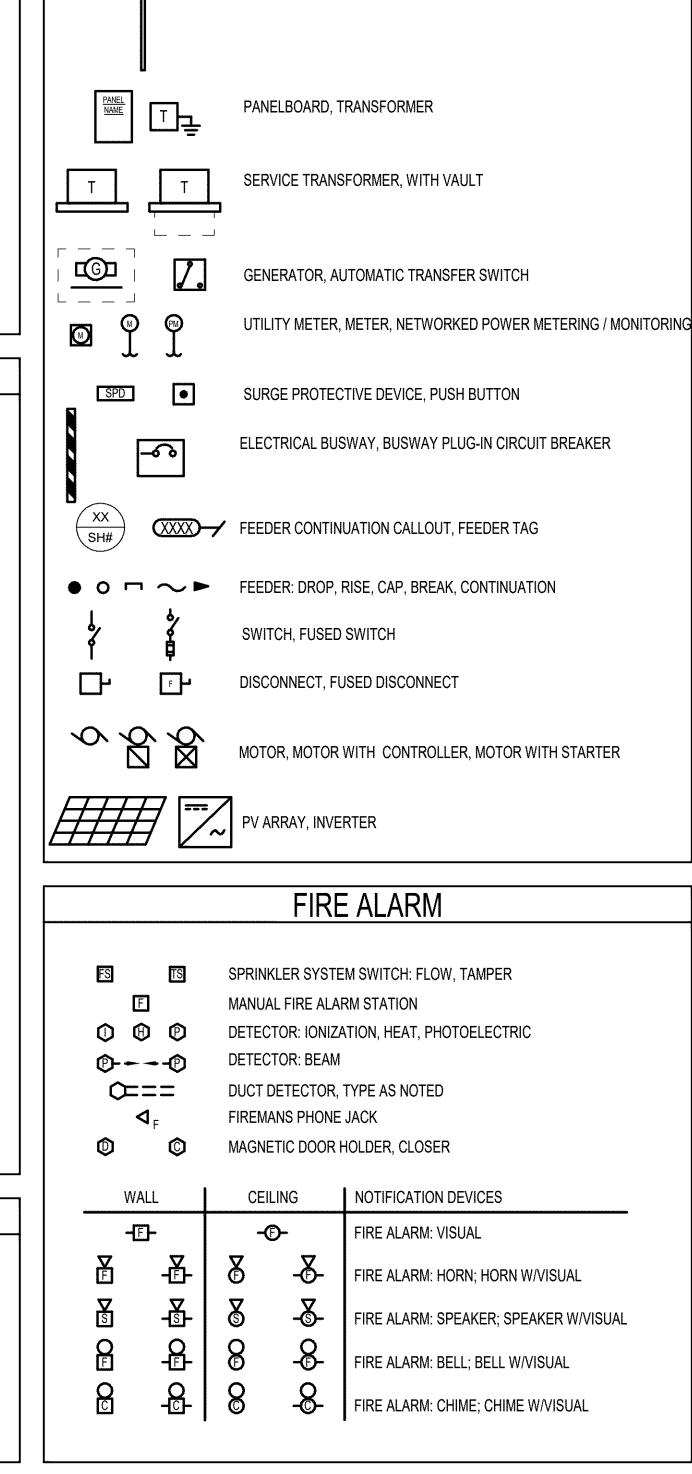


POWER - SINGLE LINE DIAGRAM & RISER

**UTILITY POLE** 

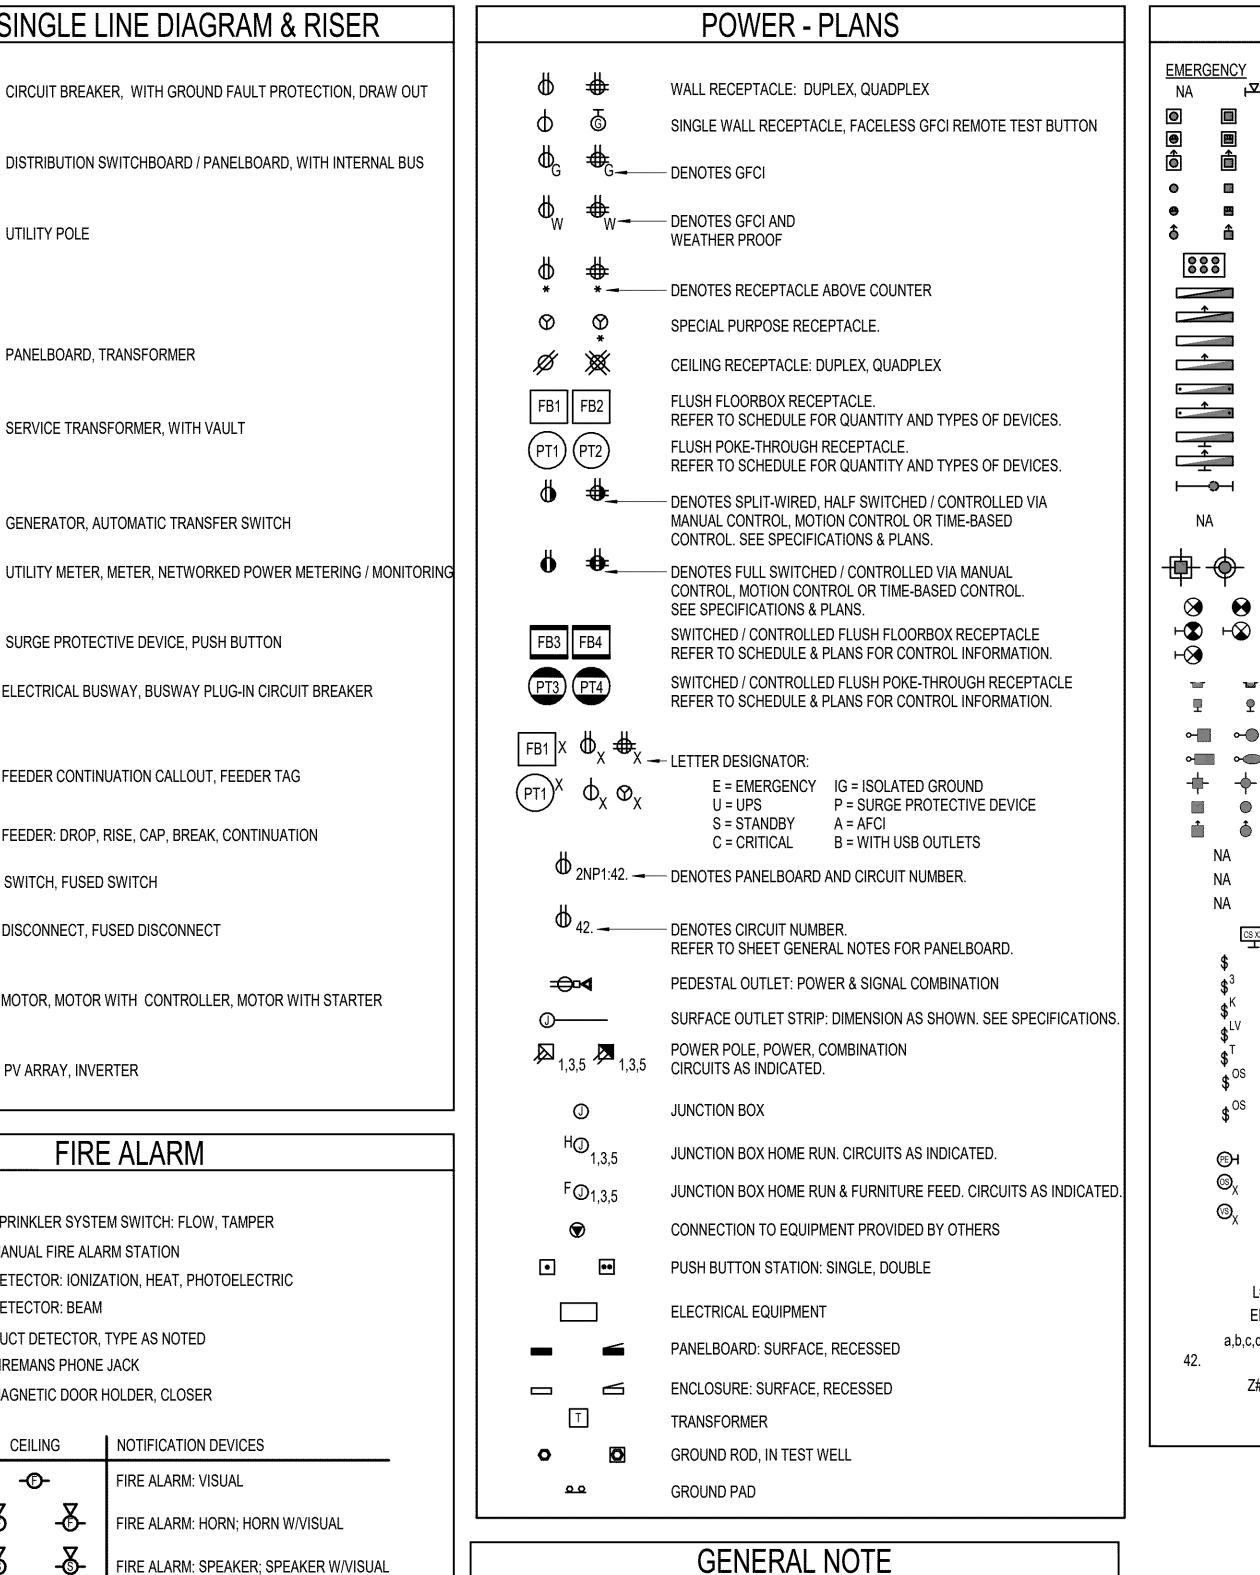

THIS IS A STANDARD LEGEND SHEET, THEREFORE, SOME SYMBOLS MAY

APPEAR ON THIS SHEET THAT DO NOT APPEAR ON THE DRAWINGS.

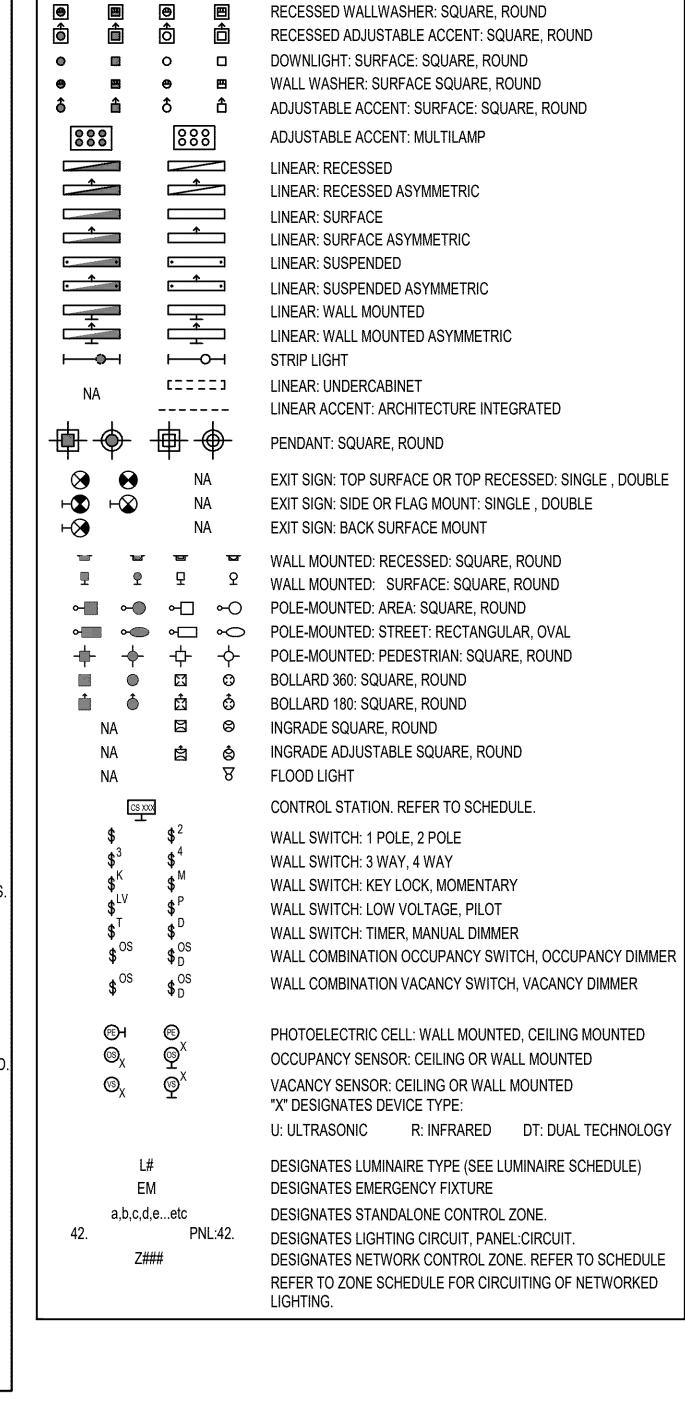

LIGHTING

RECESSED DOWNLIGHT:: SQUARE, ROUND

TRACK: WITH CURRENT LIMITER. WITHOUT CURRENT LIMITER

CLIENT WEST LINN WILSONVILLE SCHOOL DISTRICT

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CONSULTANTS





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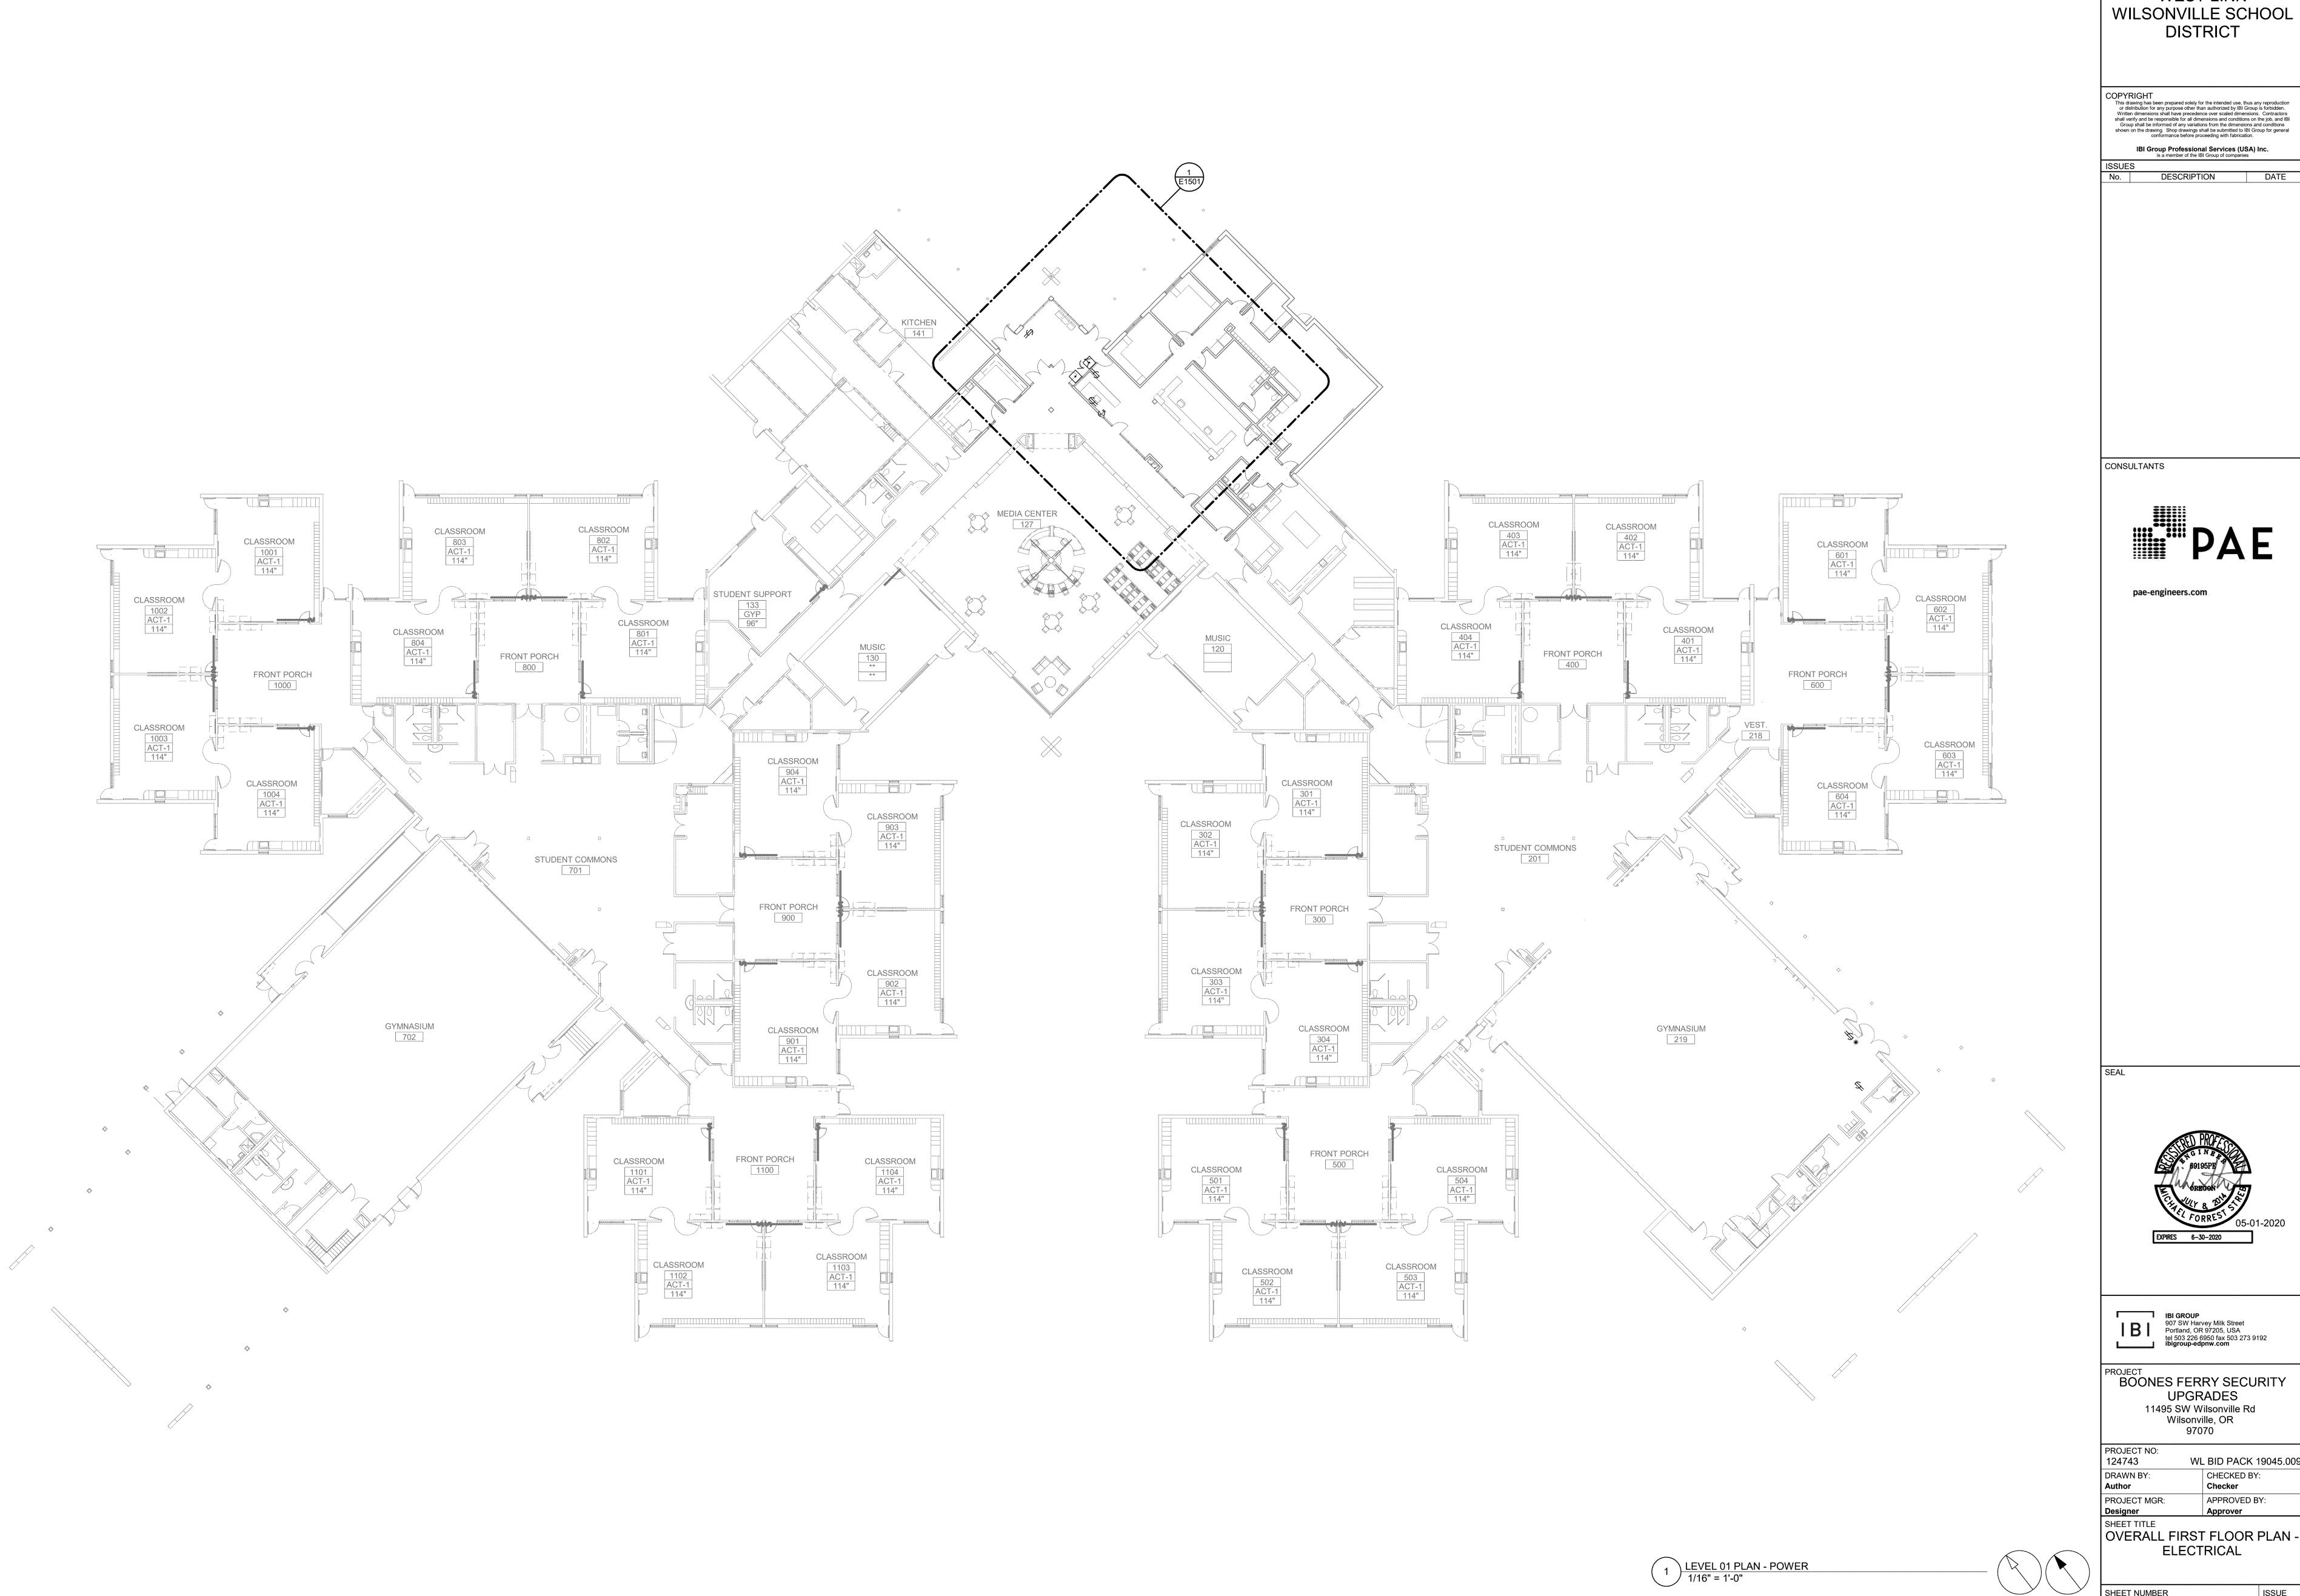
PROJECT NO: 124743 WL BID PACK 19045.009 DRAWN BY: CHECKED BY: Checker PROJECT MGR: APPROVED BY:

SHEET TITLE SYMBOLS, LEGENDS AND **ABBREVIATIONS -**

SHEET NUMBER

ELECTRICAL

E0001




CLIENT **WEST LINN** WILSONVILLE SCHOOL DISTRICT

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PROJECT
BOONES FERRY SECURITY UPGRADES 11495 SW Wilsonville Rd Wilsonville, OR 97070

WL BID PACK 19045.009 CHECKED BY: Checker APPROVED BY:

OVERALL FIRST FLOOR PLAN -ELECTRICAL

SHEET NUMBER E1101
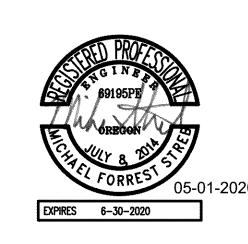
#### **GENERAL NOTES:**

A. MAINTAIN CONTINUITY OF EXISTING SYSTEMS WITHIN DASHED BOUNDARY DURRING REMOVAL OF INTERIOR AND EXTERIOR WALLS.

B. PRIOVIDE CONDUIT AND CONDUCTORS AS REQUIRED FOR DIVISION 28 SCOPE OF WORK. SEE DIVISION 28 HARDWARE SPECIFICATIONS FOR REQUIREMENTS.

C. EXISTING LIGHTING AND CONTROL TO REMAIN UNLESS OTHERWISE NOTED ON LIGHTING DETAIL.

CLIENT **WEST LINN** WILSONVILLE SCHOOL DISTRICT

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## NOTES:

1. REMOVE EXISTING RECEPTACLES. REUSE EXISTING CIRCUIT TO SERVE NEW DOUBLE DUPLEX RECEPTACLE VIA ACCESSIBLE CEILING.

2. PROVIDE 120V CONNECTIONS TO SECURITY LOCKDOWN "SHELTER" SYSTEM. REFERENCE DOOR HARDWARE SPECIFICATION FOR MORE INFORMATION. COORDINATE WITH SECURITY SYSTEM INTEGRATOR FOR CONNECTION POINTS.

3. RELOCATE EXISTING EXIT SIGN TO NEW LOCATION SHOWN.

4. RELOCATE EXISTING FIRE ALARM PULL STATION AND COVER TO NEW LOCATION SHOWN.

5. RELOCATE EXISTING CIRCUIT SERVING REFRIGERATED DRINKING FOUNTAIN TO NEW LOCATION SHOWN.

6. RELOCATE EXISTING DOOR OPERATOR POWER CONNECTION, PUSH BUTTONS AND CONTROL TO NEW LOCATION VIA ACCESIBLE CEILING.

7. RELOCATE EXISTING CONNECTION TO WALL MOUNTED CABINET UNIT HEATER TO CEILING HEATER.

8. REMOVE EXISTING SWITCH. EXISTING LIGHTING IN RECEPTION 101 TO BE SERVED BY EXISTING CIRCUIT AND CONTROL IN SCHOOL OFFICE






PROJECT
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UPGRADES
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Wilsonville, OR 97070


PROJECT NO: 124743	WL BID PACK 19045.009
DRAWN BY: Author	CHECKED BY: Checker
PROJECT MGR:	APPROVED BY:
Designer	Approver


SHEET TITLE
ENTRY PLANS - ELECTRICAL

SHEET NUMBER E1501

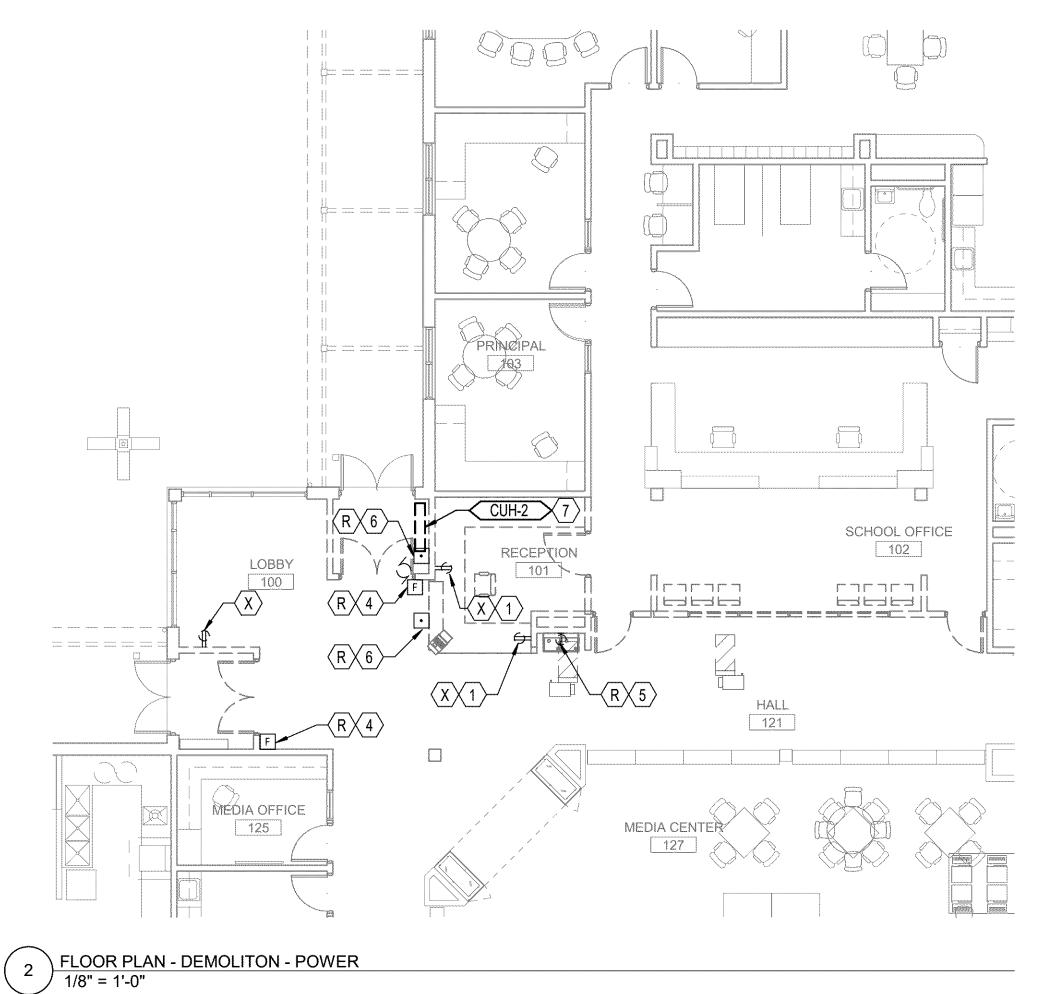



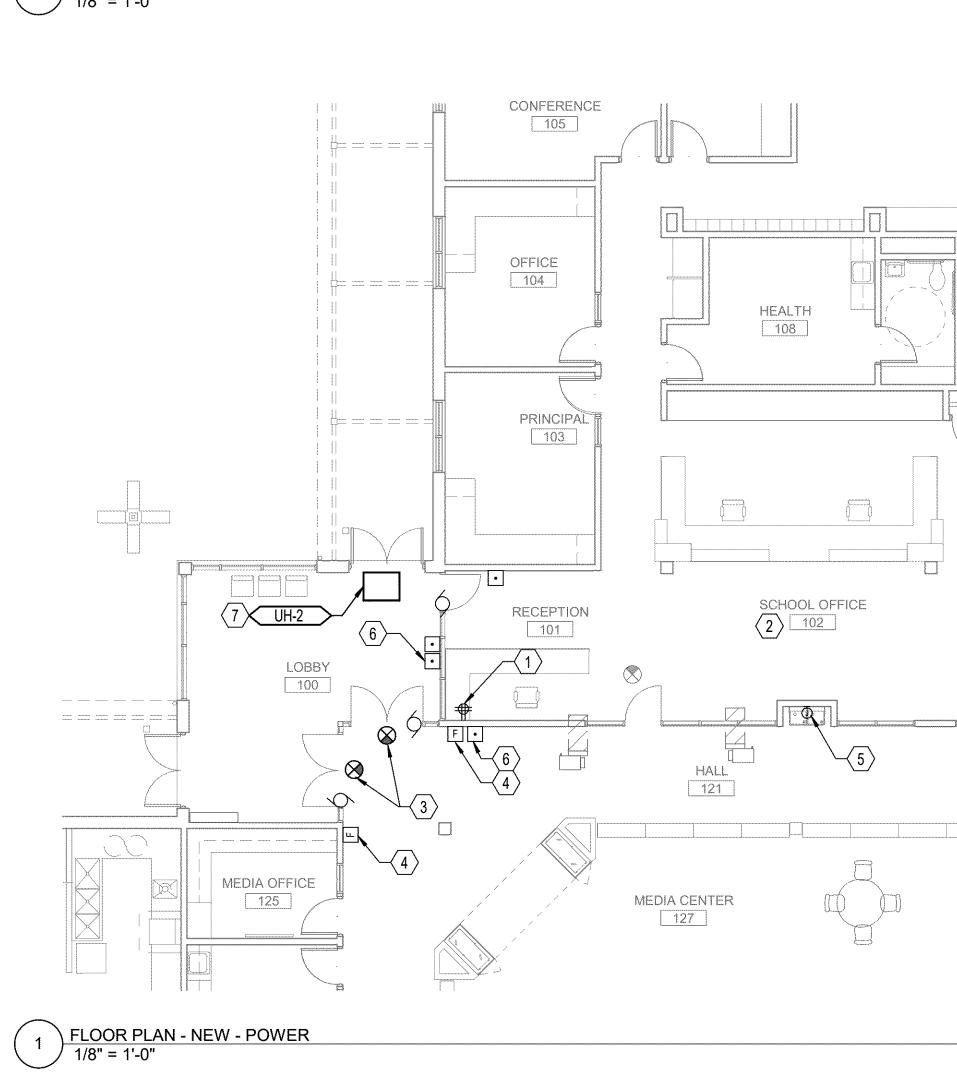

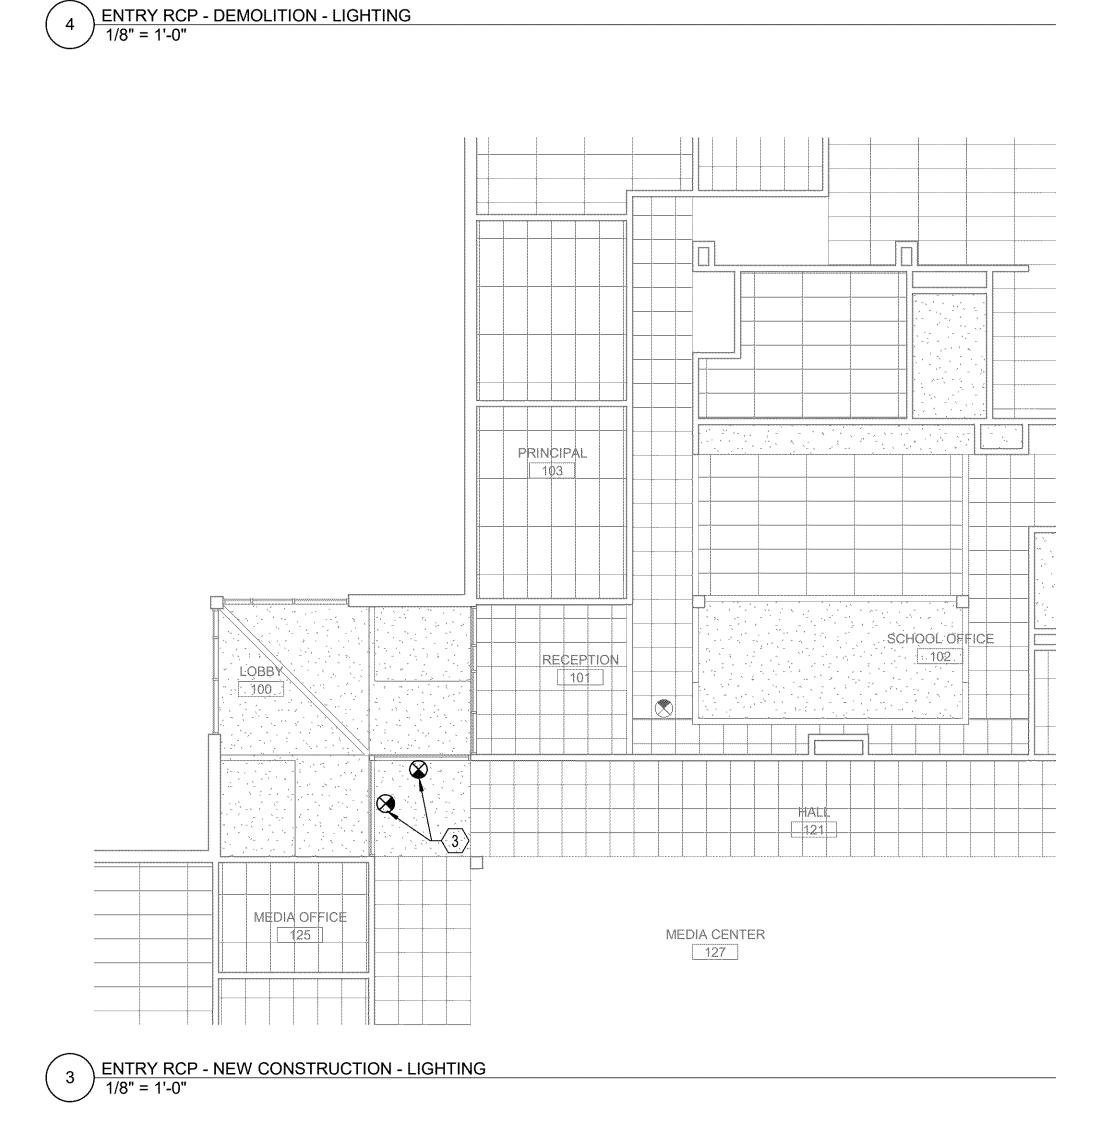

PRINCIPAL


SCHOOL OFFICE


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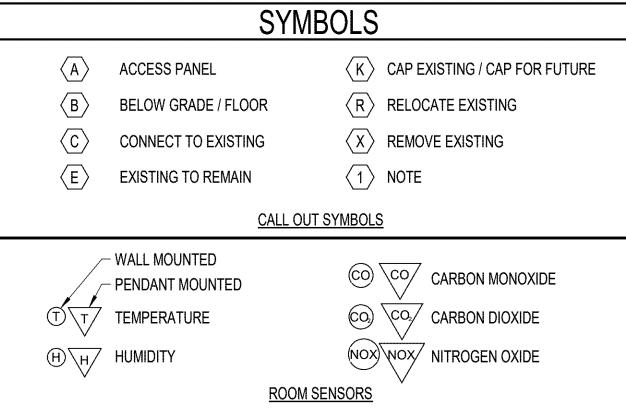
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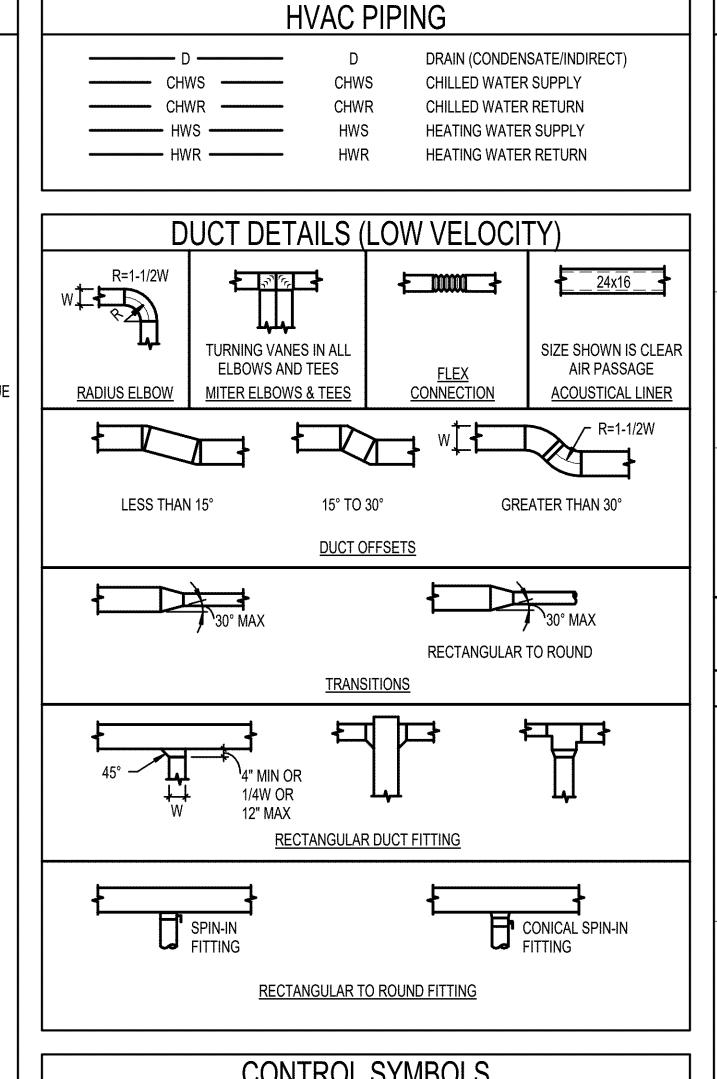
MEDIA OFFICE









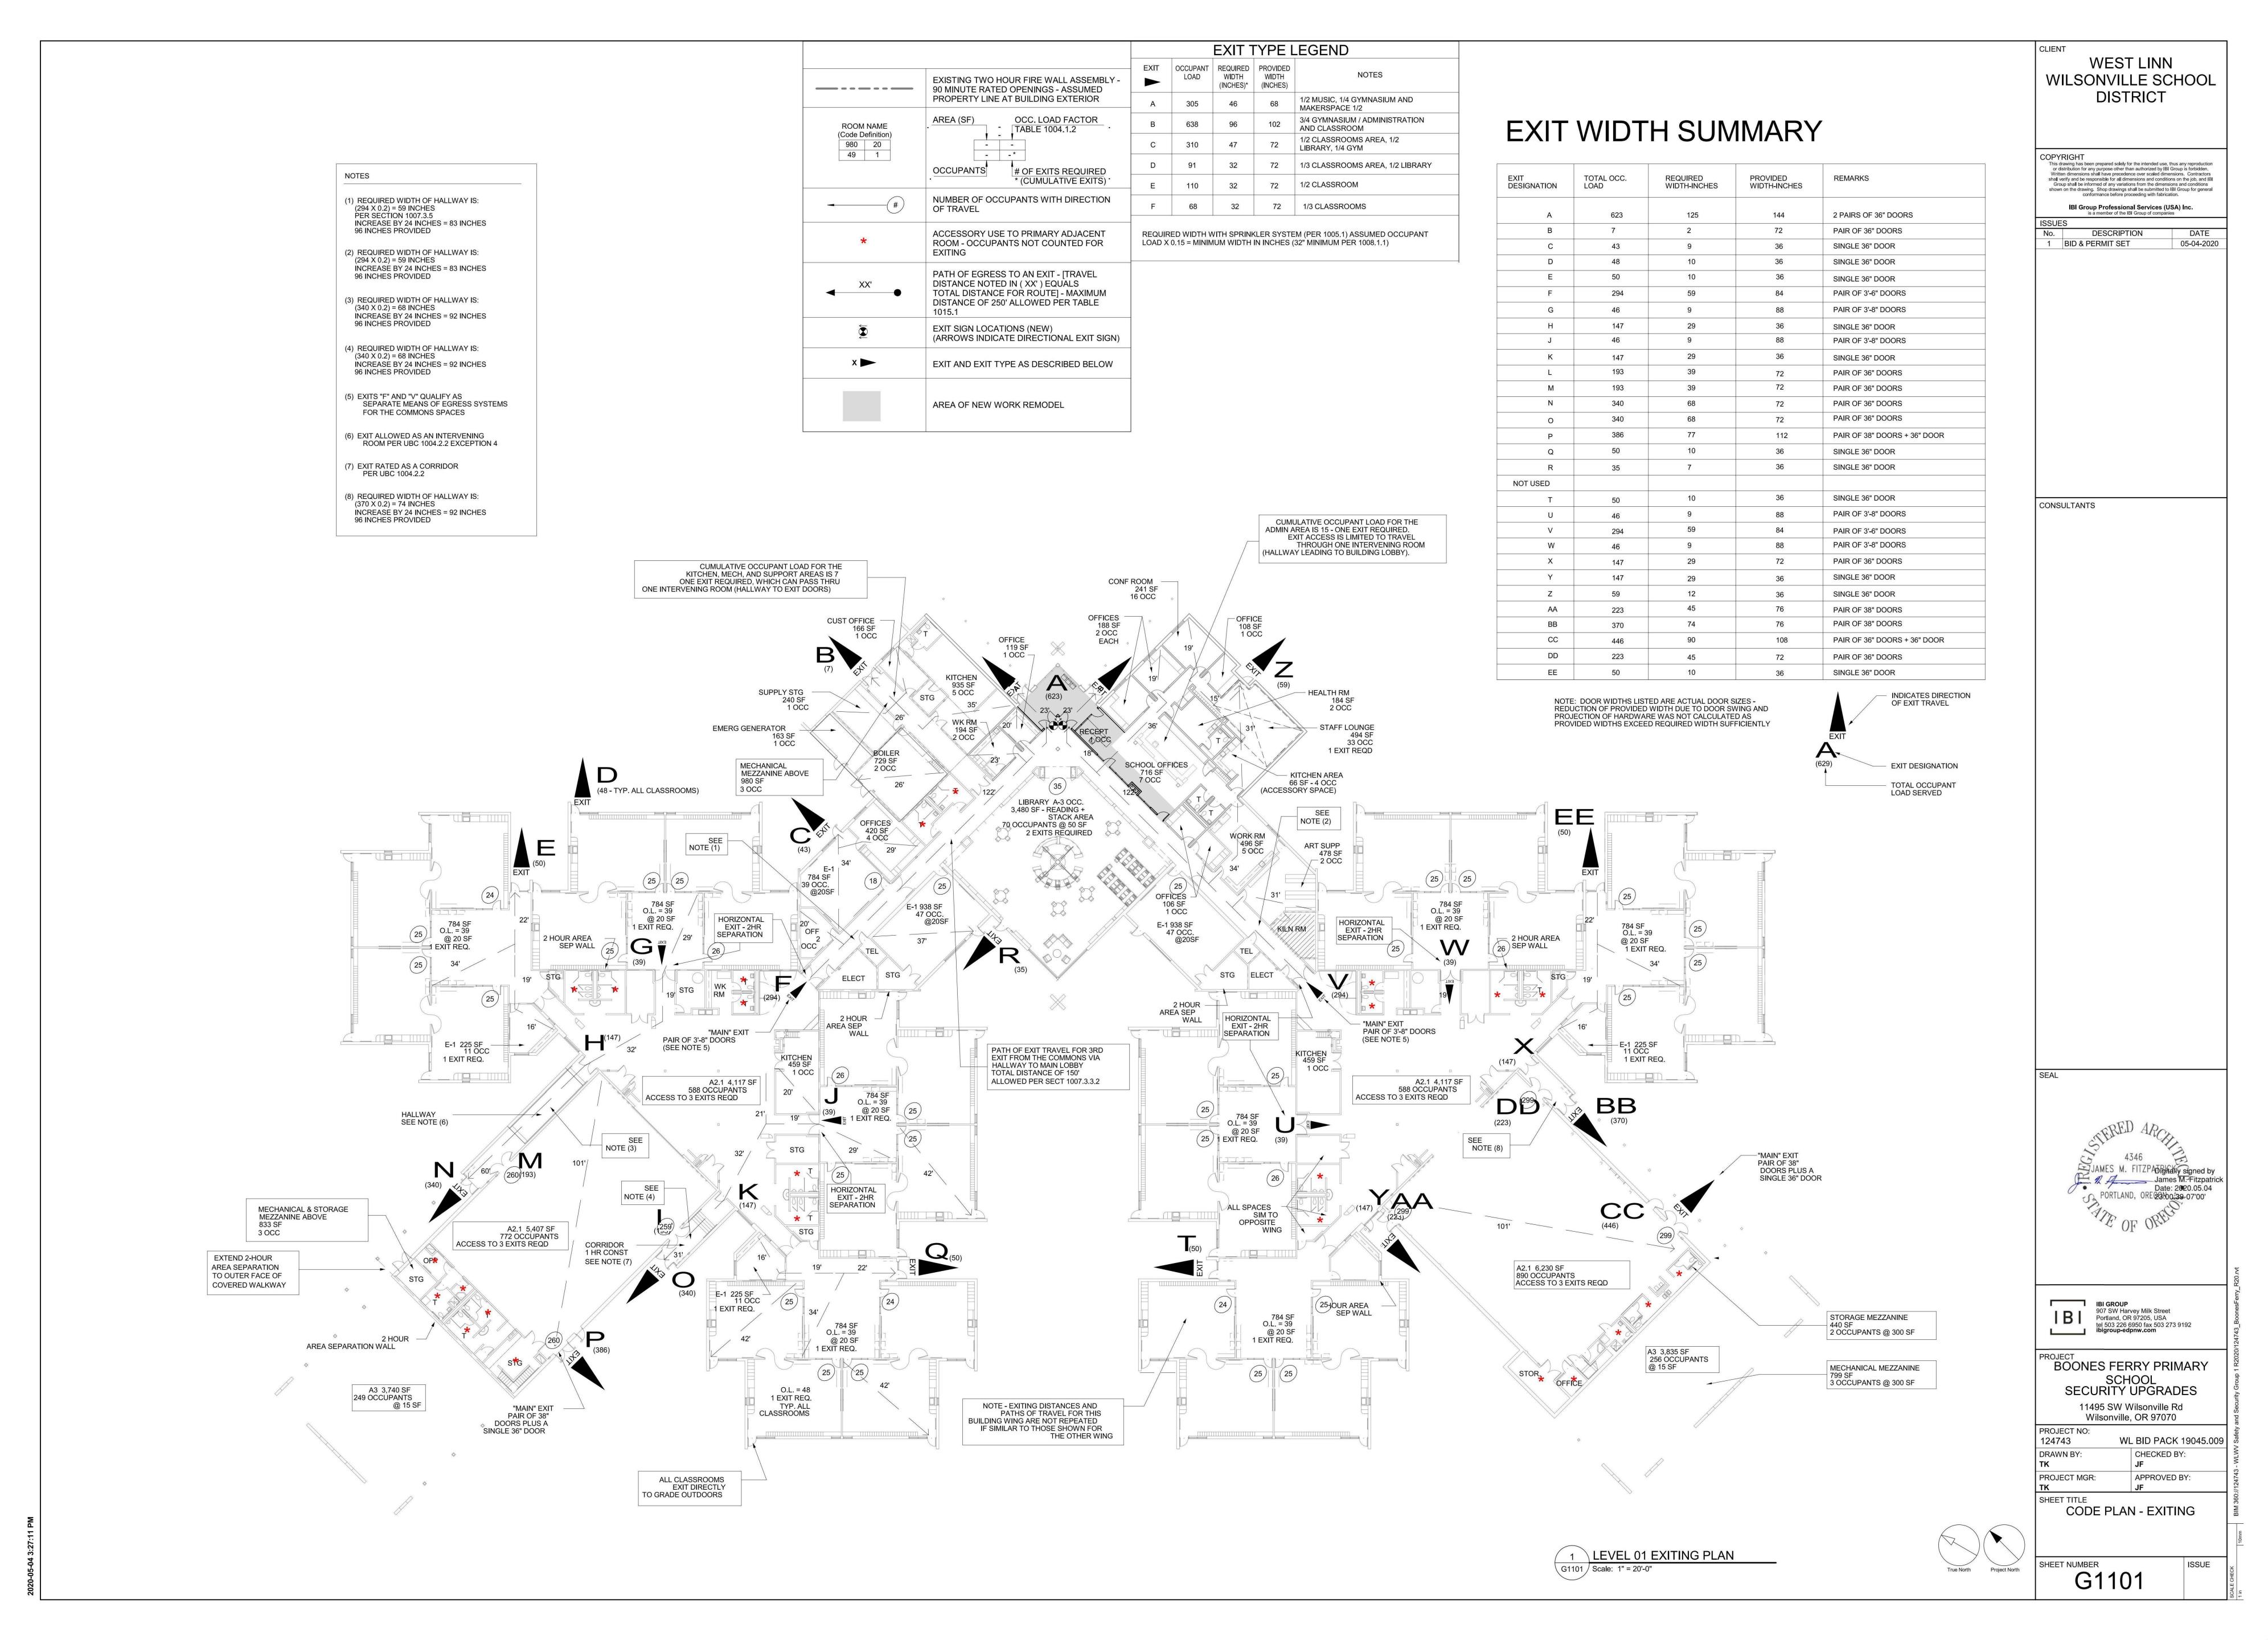

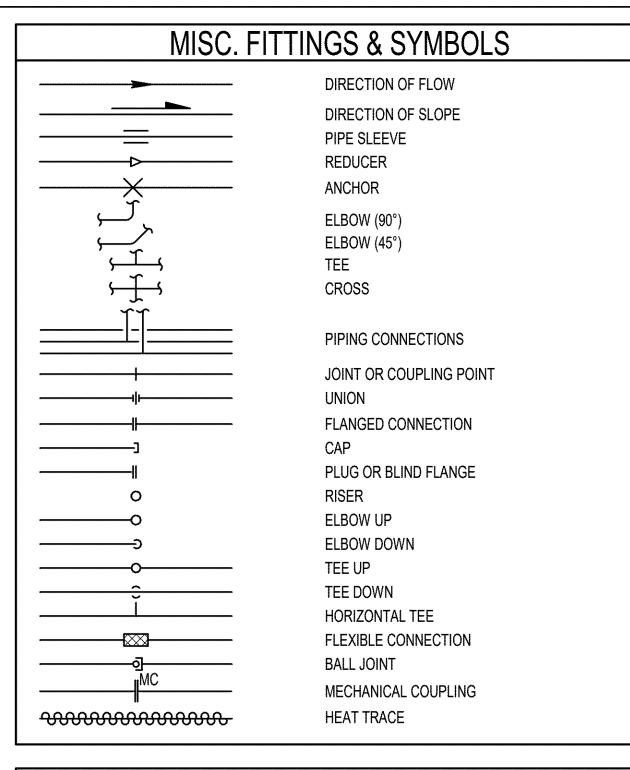

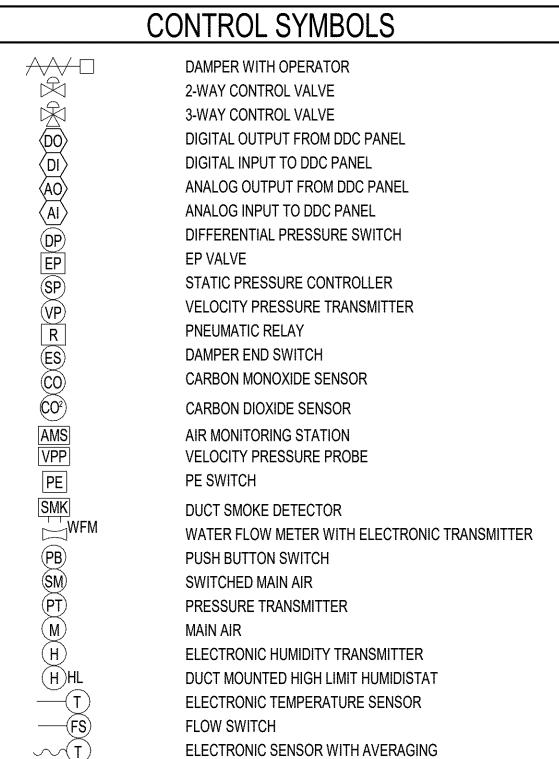

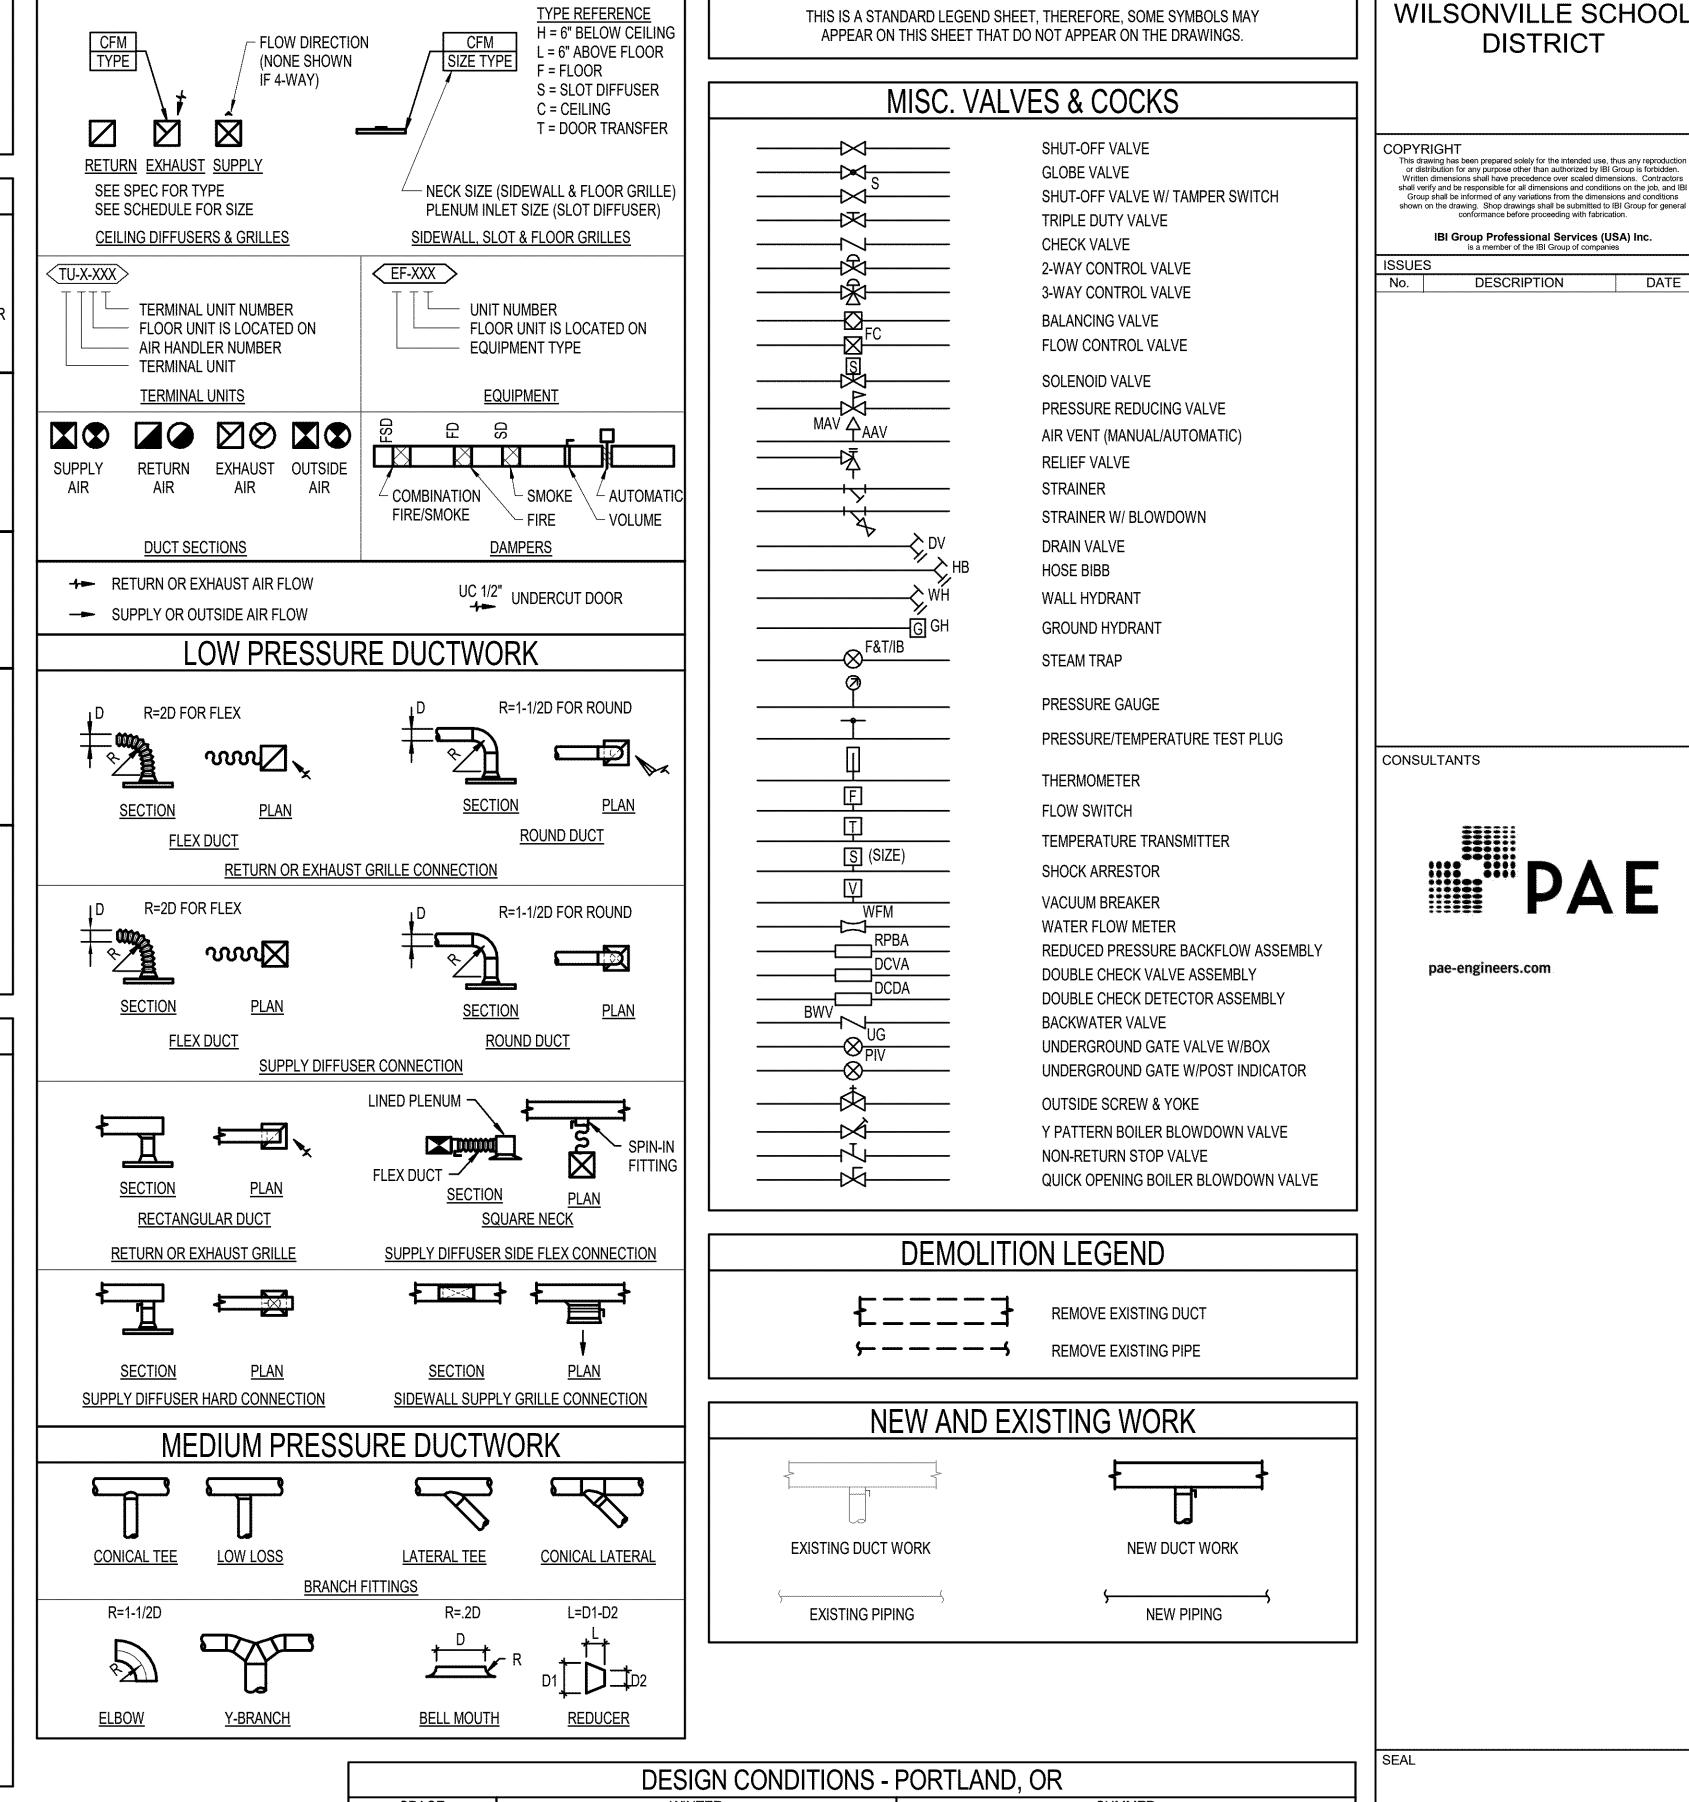

**DUCT LEGEND** 

			DIFFU	JSERS A	AND GF	RILLES					
			AIRFLOV	V RANGE	INLET	FACE	E SIZE				
			MIN	MAX	SIZE	T-BAR	HARD LID	MAX	THROW	MANUFACTURER	
TAG	TYPE	DESCRIPTION	(CFM)	(CFM)	(IN)	(IN)	(IN)	NC	(FT)	& MODEL	
			0	125	6x6	24x24	13x13	12	2-2-5		
	OFFILING OFFICE A	PERFORATED FACE, MODULAR CORE, ADJUSTABLE 4-WAY THROW	126	220	8x8	24x24	15x15	17	2-3-6	TITUS PMC	
C-1	CEILING SUPPLY DIFFUSER		221	345	10x10	24x24	17x17	21	3-4-8		
	DII I OOLK		346	500	12x12	24x24	19x19	24	3-5-9		
			501	780	16x16	24x24	23x23	28	4-6-11		
			0	340	10x10	24x24	12x12	17	**		
		PERFORATED FACE,	341	780	15x15	24x24	17x17	22	**	TITUS PAR	
C-2	CEILING RETURN/ EXHAUST GRILLE	STEEL, ROUND DUCT	781	1,125	18x18	24x24	20x20	24	**		
	LATIAUST GRILLE	CONNECTION	1,129	1,670	22x22	24x24	24x24	26	**		
			1,671	3,500	22x46	24x48	24x48	25	44	-	

A. NOISE CRITERIA (NC) BASED ON ROOM ABSORPTION OF 10 dB, MEASURED PER ANSI/ASHRAE STANDARD 70. B. THROW VALUES GIVEN FOR TERMINAL VELOCITIES 150, 100, AND 50 FPM FOR ISOTHERMAL CONDITIONS. C. ADJUST THROW DIRECTION AND QUANTITY PRIOR TO AIR BALANCING.

W/0

INVERT ELEVATION

WITHOUT

SP/	ACE		WINTER		SUMMER
		TEMPERATURE	HUMIDITY	TEMPERATURE	HUMIDITY
OUTI	DOOR	25.2° F DB	9.6° F DP / 9.0 HR / 29.8 ° F MCDB	91.4° F DB / 67.3° F MCWB	63.2° F DP / 87.0 HR / 75.1° F MCDB
IND	OOR	45° F ± 2° F DB	N/A	N/A	N/A
<u>GENERAL</u>	NOTES:				
A. OUTD	OOR CONDI	TIONS BASED ON ASHF	RAE FUNDAMENTALS 2013 99.6% AND (	0.4% DATA.	

			UN	IT HEAT	ER SC	HEDUL	E						
				HY	DRONIC CO	OIL		ELECTRICAL		GEN.	APPROX.		
				CAPACITY	FLOW	FLOW	VOLT/	MOCP	MCA	POWER	WEIGHT	MANUFACTURER	
TAG	LOCATION	SERVICE	TYPE	(MBH)	(CFM)	(GPM)	PHASE	(A)	(A)	(Y/N)	(LBS)	& MODEL	NOTES
UH-2	ENTRY	STORAGE	FLUSH CEILING, PARTIALLY RECESSED	33	340	2.5	120/1	2	15	NO	50	TRANE FFE-040	1, 2, 3, 4
GENERAL NOTE	S:												

A. HYDRONIC HEATING CAPACITY BASED ON EWT/LWT = 120/110°F.

1. UNIT MOUNTED THERMOSTAT: SET TO 68 °F

2. PROVIDE CT FOR UNIT HEATER STATUS AND ALARM. CONNECT TO EXISTING BACNET DDC BUILDING SYSTEM.

3. UNIT SELECTION BASED ON INLET BOTTOM STAMPED LOUVER AND OUTLET BOTTOM STAMPED LOUVER.

4. HEATING CAPACITY BASED ON 4-ROW COIL, PROVIDE 1" THROAWAY FILTER.

			TERN	IINAL U	JNIT S	CHEDU	LE				
					PRIMA	ARY AIR		HYDRON	VIC COIL		
				INLET	MAX	HEATING	MIN			MANUFACTURER	
TAG	LOCATION	SERVICE	TYPE	(IN)	CFM	CFM	CFM	MBH	GPM	& MODEL	NOTES
VR-1-11	HALLWAY	LOBBY	VVR	10	900	450	0	17.1	0.9	EXISTING	1, 2
/VR-1-17	HALLWAY	RECEPTION/OFFICE	VVR	10	1020	510	450	16.6	0.8	EXISTING	1, 2
'CVICOVI	NATEO.										

<u>GENERAL NOTES:</u> A. PRIMARY AIR TEMPERATURE 55°F (SUMMER), 65°F (WINTER).

C. HYDRONIC HEATING COIL CAPACITY BASED ON 180°F ENTERING WATER TEMPERATURE AND 140°F LEAVING WATER TEMPERATURE.

1. RELOCATE THERMOSTAT SERVING TU AS NOTED ON DRAWINGS. 2. EXISTING TERMINAL UNIT TO REMAIN. REBALANCE AIR AND WATER FLOW RATES TO VALUES SHOWN.

VVR = VARIABLE AIR VOLUME TERMINAL UNIT WITH REHEAT COIL

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CLIENT

**WEST LINN** 

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EXPIRES 12-31-21

PROJECT NO: WL BID PACK 19045.009 124743 DRAWN BY: CHECKED BY:


APPROVED BY:

SHEET TITLE SYMBOLS, LEGENDS AND ABBREVIATIONS -

MECHANICAL

PROJECT MGR:

SHEET NUMBER M0001

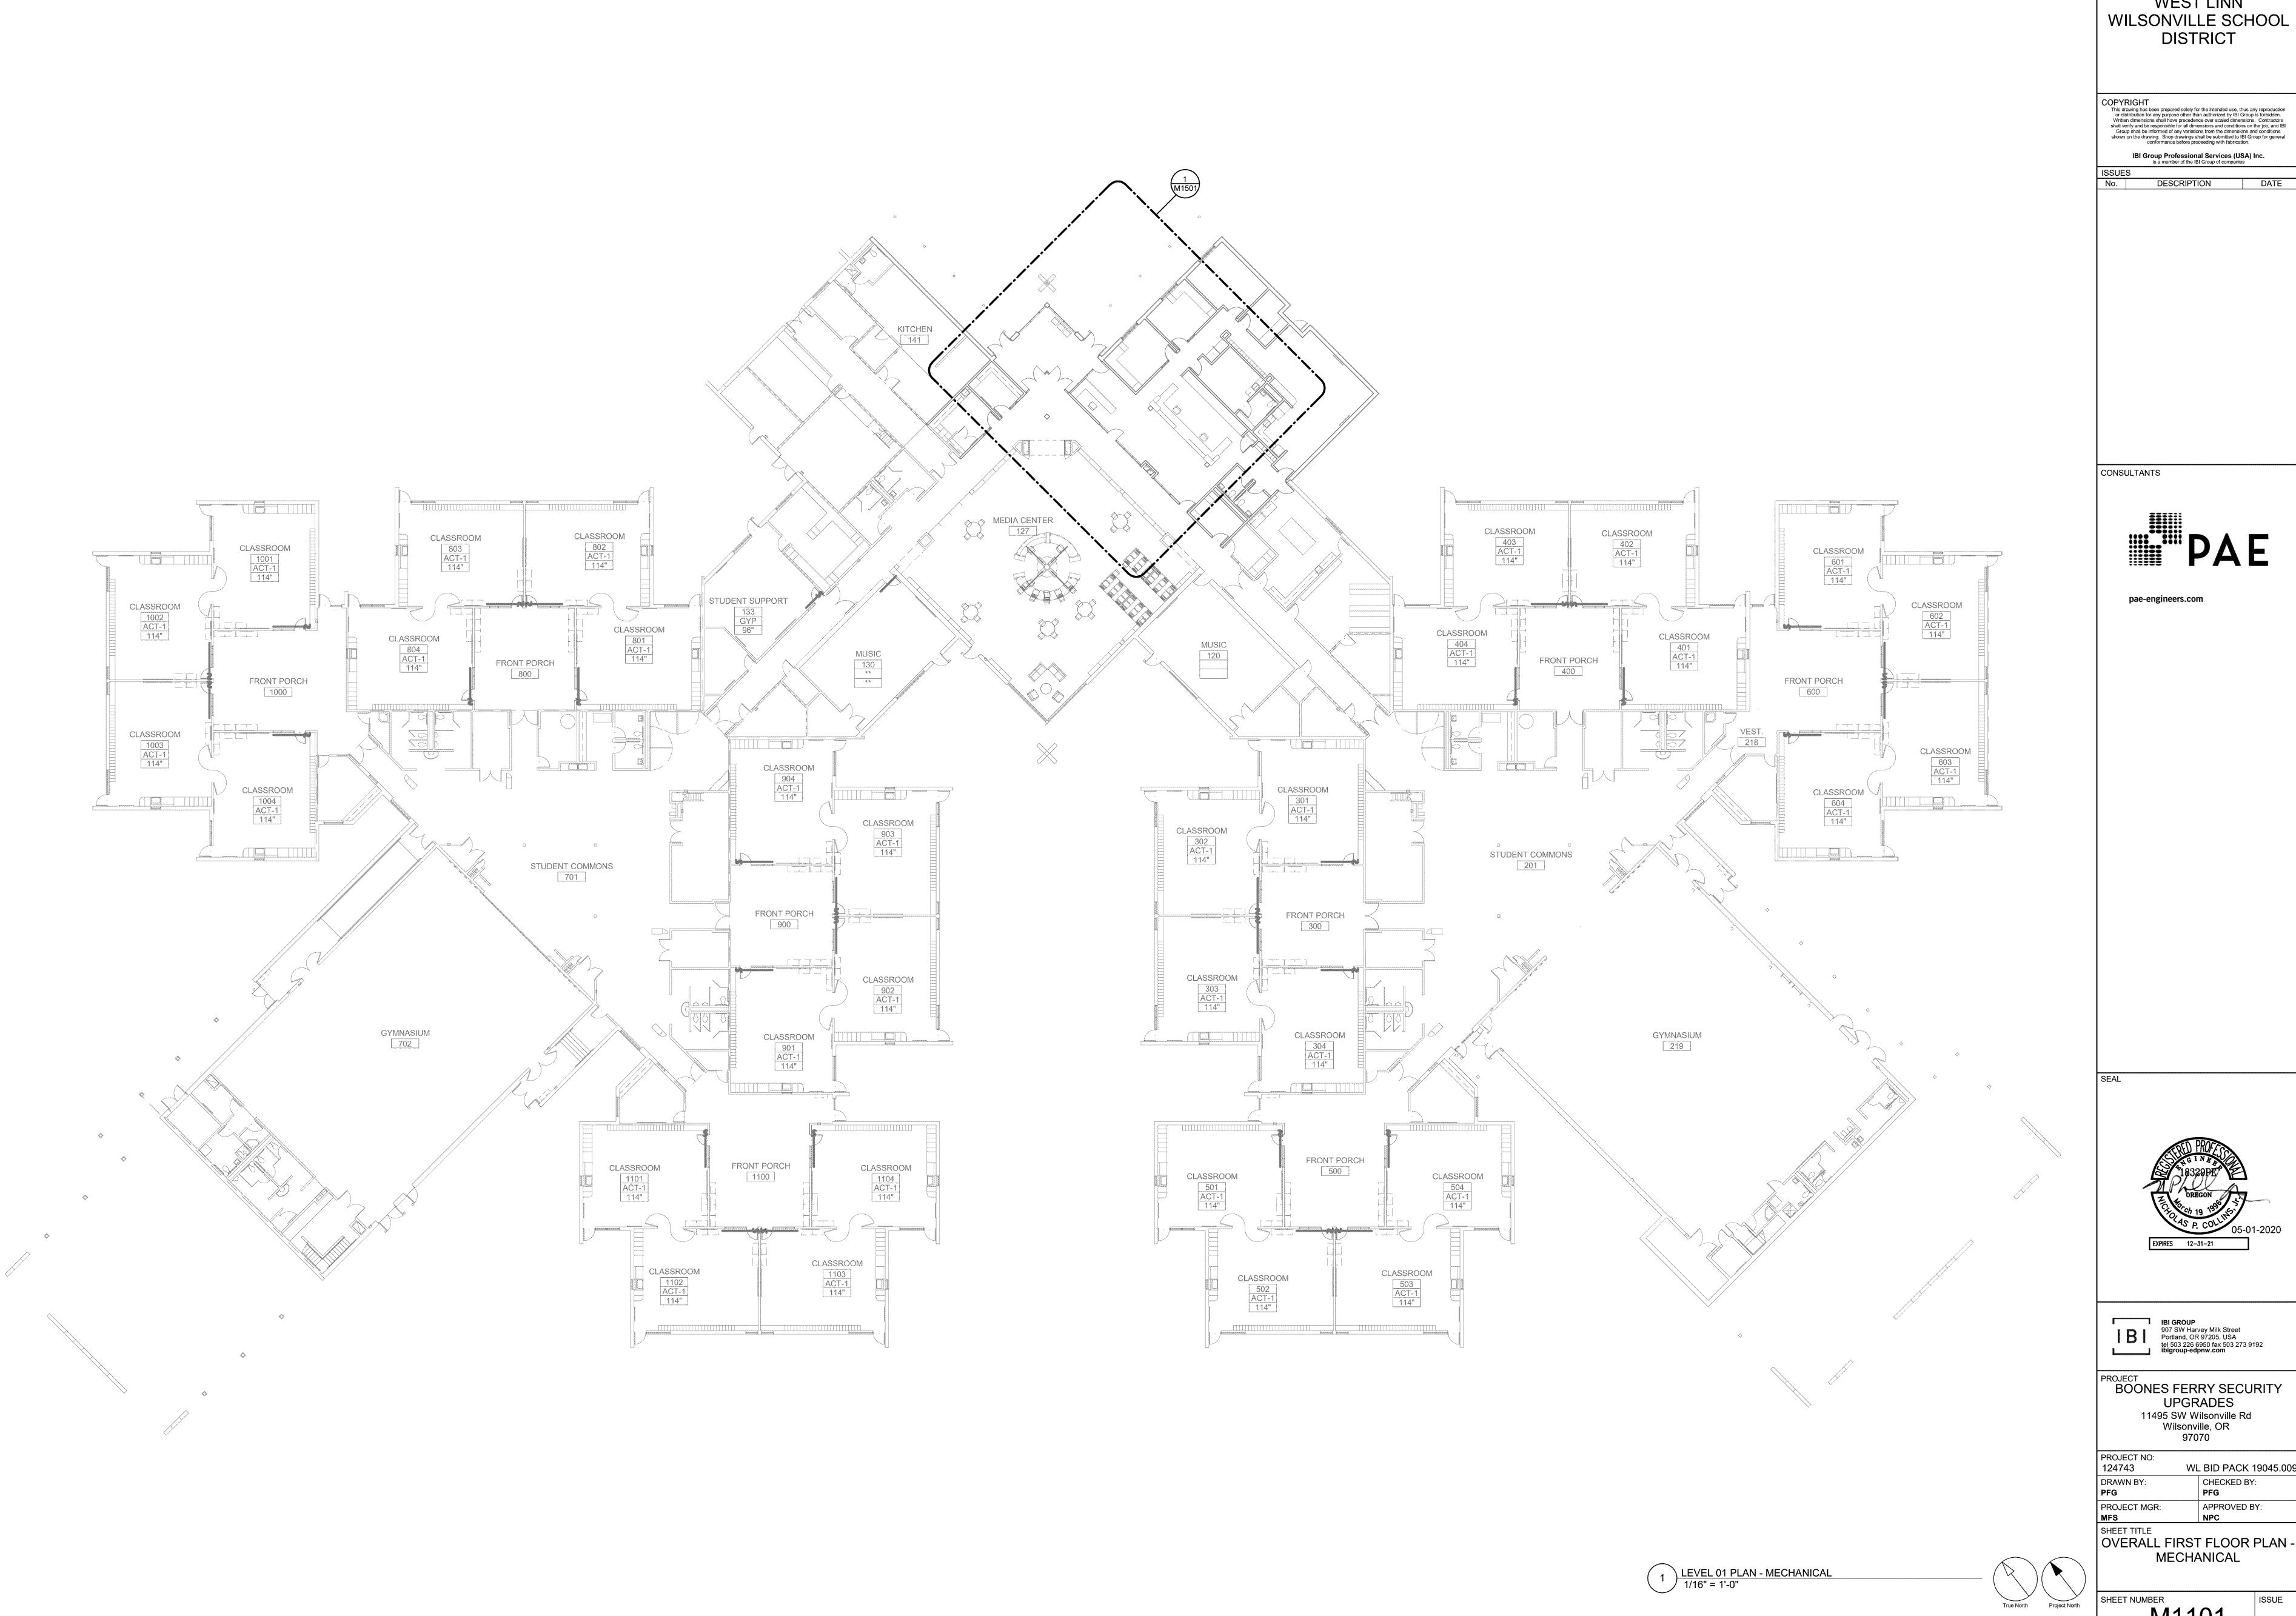

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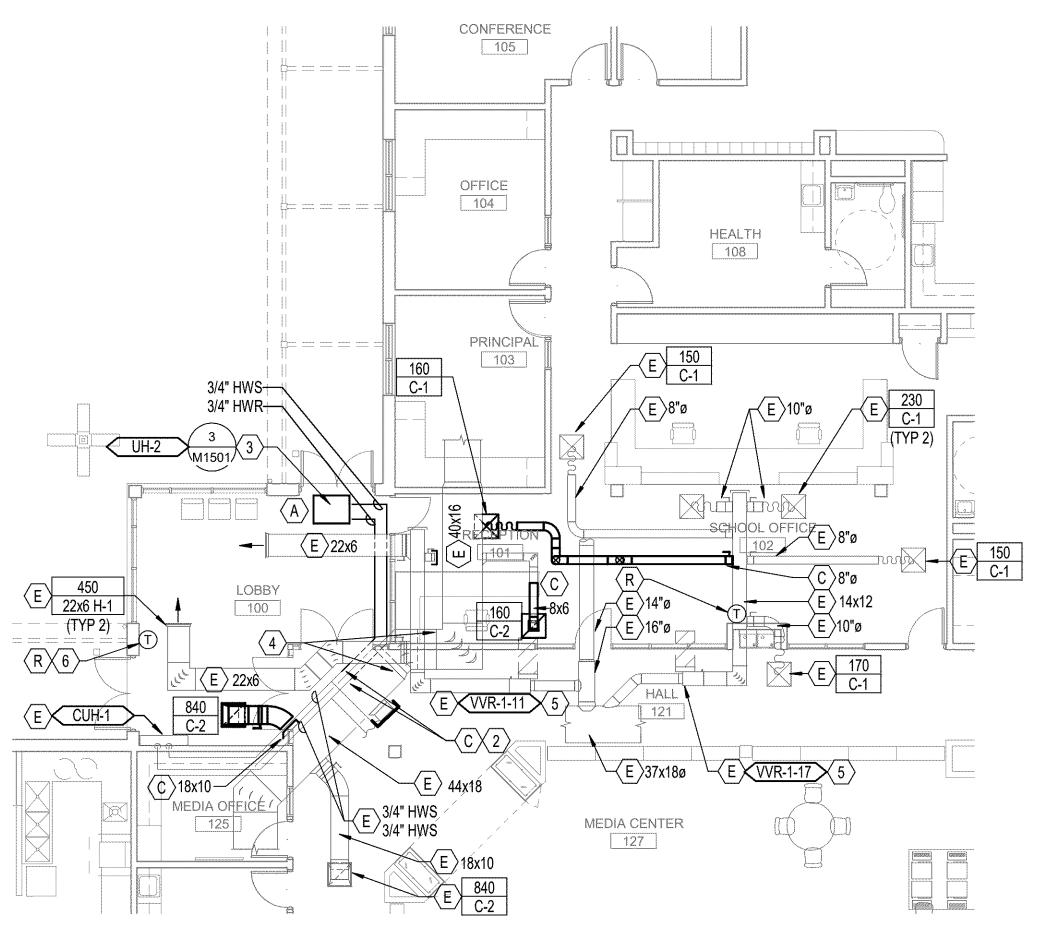
PROJECT
BOONES FERRY SECURITY UPGRADES 11495 SW Wilsonville Rd Wilsonville, OR 97070

WL BID PACK 19045.009 CHECKED BY: APPROVED BY:

OVERALL FIRST FLOOR PLAN -MECHANICAL

M1101

# $||\langle E \rangle 40x16 -$ SCHOOL OFFICE 8"Ø 102



#### **GENERAL NOTES:**

- A. ALL EXISTING CONDITIONS SHALL BE FIELD VERIFIED BY THE CONTRACTOR.
- B. PATCH AND REPAIR ALL OPENINGS MADE BY REMOVALS.
- C. DEMOLITION WORK SHALL INCLUDE BUT NOT BE LIMITED TO THE FOLLOWING: REMOVAL OF EQUIPMENT, SUPPORTS, ANCHORS, PIPING, DUCTWORK AND ALL APPURTENANCES WHERE INDICATED ON THE PLANS.
- REMOVE MECHANICAL EQUIPMENT, DUCTS, PIPING AND ASSOCIATED ITEMS AS SHOWN OR RELATED TO EQUIPMENT TO BE REMOVED. CAP DUCTWORK OR PIPING AT NEAREST LIVE BRANCH.
- CONTRACTOR SHALL PERFORM PRE-BALANCE AIRFLOW TESTING AND REPORT SHALL BE COMPLETED BEFORE ANY DEMOLITION WORK BEGINS. REPORT SHALL INCLUDE TESTING ON TERMINAL UNITS, SUPPLY DUCT AND SUPPLY DIFFUSERS, AND RETURN DUCTS AND RETURN GRILLES SERVING THE VESTIBULES THAT ARE LOCATED OUTSIDE OF THE AREA OF WORK.
- F. DUCT RUNOUTS TO DIFFUSERS AND GRILLES TO BE SAME AS INLET SIZE SHOWN ON SCHEDULE UNLESS OTHERWISE NOTED.
- G. PROVIDE VOLUME DAMPER AT EACH BRANCH OUTLET/INLET. PROVIDE REMOTE CABLE DAMPERS FOR VOLUME DAMPERS ABOVE HARD LIDS (YOUNG'S BOWDEN REMOTE CABLE CONTROLLERS OR EQUAL).
- H. RUN DUCTS AND PIPING CONCEALED, UNLESS OTHERWISE SPECIFIED, AND CLEAR OF CEILING INSERTS AND EQUIPMENT. ALL DUCTWORK SHALL BE INSTALLED AS CLOSE AS POSSIBLE TO WALL AND UNDERSIDE OF BEAMS AND JOISTS.
- ALL WORK SHALL BE COORDINATED WITH ALL TRADES INVOLVED. OFFSETS IN PIPING AND DUCTS (INCLUDING DIVIDED DUCTS) AND TRANSITIONS AROUND OBSTRUCTIONS SHALL BE PROVIDED AT NO ADDITIONAL COST TO THE OWNER.
- VERIFY ALL EQUIPMENT CONNECTIONS WITH MANUFACTURER'S CERTIFIED DRAWINGS. VERIFY AND PROVIDE DUCT TRANSITIONS TO FURNISHED EQUIPMENT. FIELD VERIFY AND COORDINATE ALL DIMENSIONS BEFORE ORDERING OR FABRICATIONS.
- K. REFER TO ARCHITECTURAL REFLECTED CEILING PLANS FOR EXACT LOCATIONS OF AIR DEVICES.
- PIPING AND DUCTWORK SHALL BE LARGEST SIZE SHOWN UNTIL SMALLER SIZE IS INDICATED -INCLUDING, BUT NOT LIMITED TO, MAINS AND BRANCH PIPING.

ISSUES

CLIENT

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#### NOTES:

- 1. DEMO EXISTING CABINET UNIT HEATER. DEMO EXISTING HW PIPING BACK TO NEAREST MAIN AND PREP FOR CONNECTION TO
- PROVIDE NEW BRANCH PIPING TO RECESSED UNIT HEATER. VERIFY ISOLATION VALVES ARE EXISTING, OTHERWISE PROVIDE NEW ISOLATION VALVES.
- COORDINATE ACCESS PANEL AND CONTROL PANEL LOCATIONS WITH ARCHITECT. VERIFY UNIT CLEARANCES ARE PROVIDED IN ACCORDANCE WITH MANUFACTURER'S CERTIFIED INSTALLATION DRAWINGS.
- DISCONNECT DUCTWORK AS NEEDED TO ALLOW FOR NEW GLULAM BEAM INSTALLATION. RE-INSTALL DUCTWORK. COORDINATE WITH ALL OTHER TRADES. COORDINATE SHUT-DOWNS WITH OWNER.
- REBALANCE TERMINAL UNIT AIR AND WATER FLOW RATES TO VALUES SHOWN ON SCHEDULE.
- 6. PROVIDE INSULATED BACK PLATE FOR MOUNTING RELOCATED THERMOSTAT ON EXTERIOR WALL.



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ENTRY PLANS - MECHANICAL


SHEET NUMBER M1501

2-WAY VALVE TYPICAL EXCEPT WHERE NOTED **GENERAL NOTES:** A. TYPICAL OF REHEAT COILS, UNIT HEATERS AND CABINET UNIT HEATERS. 3 HEATING COIL PIPING DETAIL NONE


1 FLOOR PLAN - NEW - MECHANICAL 1/8" = 1'-0"

2 FLOOR PLAN - DEMOLITON - MECHANICAL 1/8" = 1'-0"



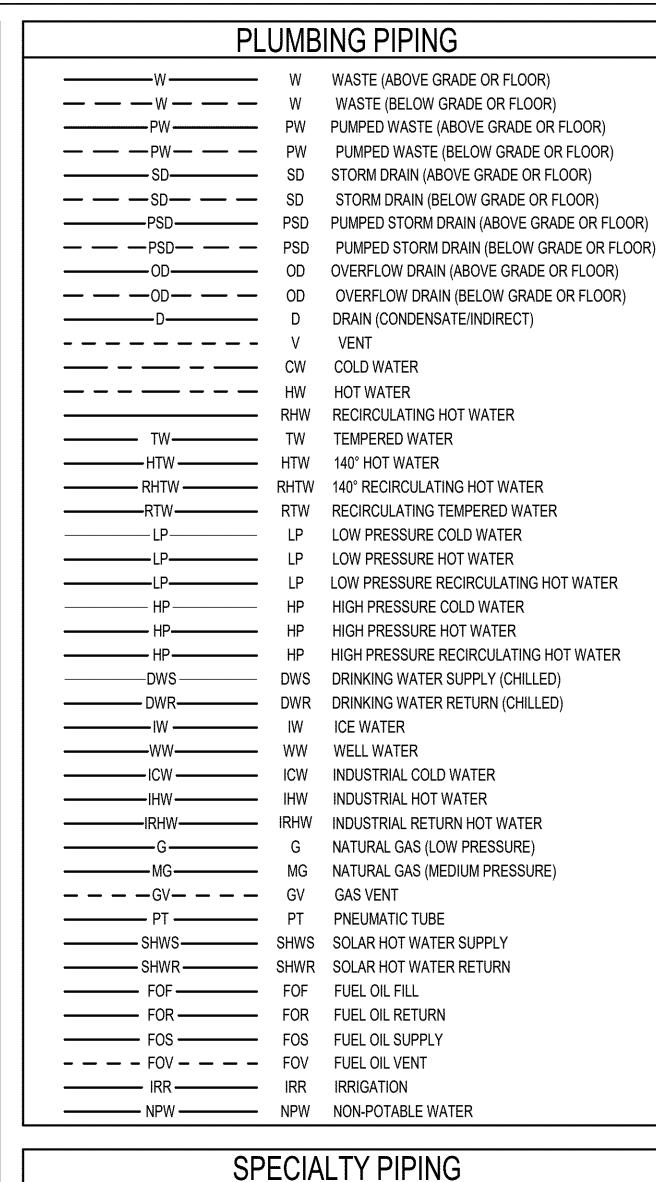

<u> </u>	<u> LVIAI</u>	LITETING
AV	AV	ACID VENT
AW	AW	ACID WASTE (ABOVE GRADE OR FLOOR)
AW	AW	ACID WASTE (BELOW GRADE OR FLOOR)
FW	FW	FLUORIDE WASTE (ABOVE GRADE OR FLOOR)
FW	FW	FLUORIDE WASTE (BELOW GRADE OR FLOOR)
DIS	DIS	DEIONIZED WATER SUPPLY
DIR	DIR	DEIONIZED WATER RETURN
DRC	DRC	DEIONIZED WATER RECLAIM
EWS	EWS	EMERGENCY EYEWASH & SHOWER
A	Α	COMPRESSED AIR
————HPA————	HPA	HIGH PURITY AIR
DS	DS	DISTILLED WATER
DCL	DCL	DECHLORINATED WATER
RO	RO	REVERSE OSMOSIS WATER
ROR	ROR	REVERSE OSMOSIS RECIRCULATED WATER
PCW	PCW	PROCESS COLD WATER
PGW	PGW	PROCESS GREY WATER
CAS	CAS	CLEAN AIR SUPPLY
CDA	CDA	CLEAN DRY AIR
CO2	CO2	CARBON DIOXIDE
O2	02	OXYGEN
N2	N2	NITROGEN
———— H2 ————	H2	HYDROGEN
LN2	LN2	LIQUID NITROGEN
Ar	Ar	ARGON
N2O	N2O	NITROUS OXIDE
CHL	CHL	CHLORINE
CBG	CBG	CARBOGENE
LP	LP	LIQUFIED PETROLEUM
SR	SR	SILVER RECOVERY
PD	PD	PUMPED DISCHARGE
VPD	VPD	VACUUM PUMP DISCHARGE
DA	DA	DENTAL AIR
MA	MA	MEDICAL AIR
MVE	MVE	MEDICAL EVACUATION EXHAUST
PV	PV	PROCESS VACUUM
cv	CV	HOUSECLEANING VACUUM
AV	AV	ALUMINUM DUST VACUUM
DV	DV	DENTAL VACUUM
LV	LV	LAB VACUUM
EV	EV	EVACUATION VACUUM
WMV	WMV	WET MOP VACUUM
DMV	DMV	DRY MOP VACUUM
ATV $$	ATV	ATMOSPHERIC VENT
SL	SL	SLURRY LINE

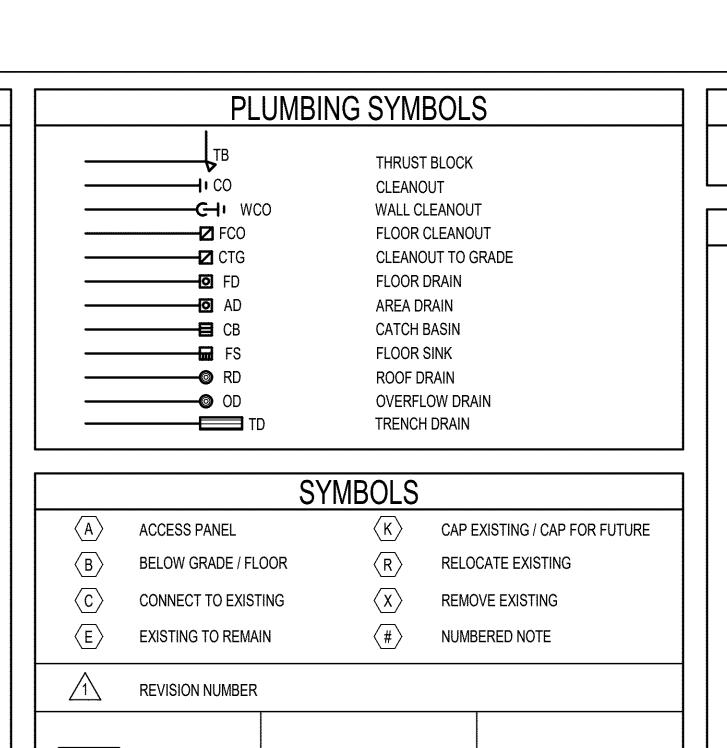

\_\_\_\_\_ DETAIL NUMBER

DWG. SHEET NO.

SYSTEM TYPE


— RISER NUMBER


- UNIT NUMBER

- FLOOR UNIT IS

LOCATED ON

EQUIPMENT TYPE

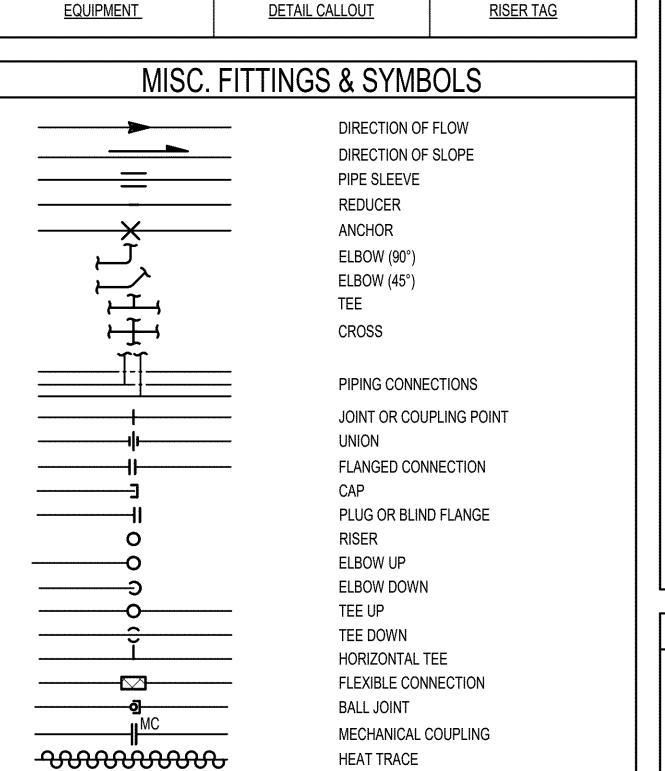

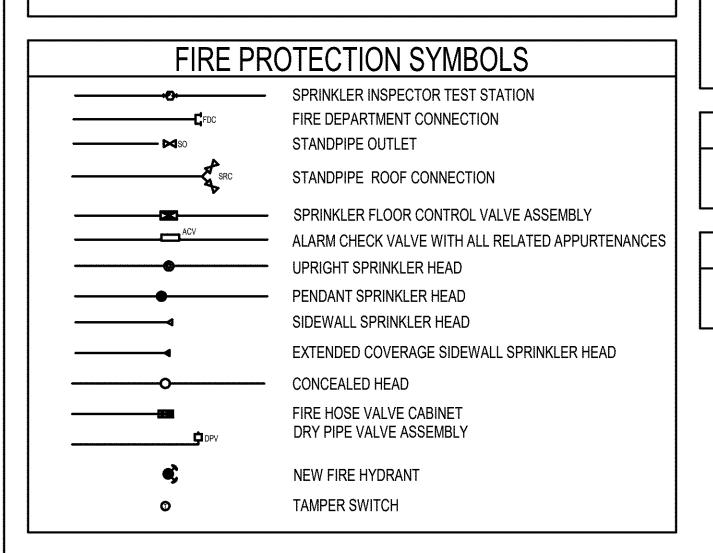

PIPE CONTINUATION

# GENERAL NOTE THIS IS A STANDARD LEGEND SHEET, THEREFORE, SOME SYMBOLS MAY APPEAR ON THIS SHEET THAT DO NOT APPEAR ON THE DRAWINGS. CLIENT WEST LINN WILSONVILLE SCHOOL DISTRICT

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SHUT-OFF VALVE W/ TAMPER SWITCH TRIPLE DUTY VALVE ——N—— CHECK VALVE 2-WAY CONTROL VALVE <del>\_\_\_\_</del> 3-WAY CONTROL VALVE BALANCING VALVE FLOW CONTROL VALVE SOLENOID VALVE PRESSURE REDUCING VALVE AIR VENT MANUAL AAV **4** AIR VENT AUTOMATIC ANGLE RELIEF VALVE STRAINER STRAINER WITH BLOWDOWN DRAIN VALVE HOSE BIBB WALL HYDRANT **GROUND HYDRANT** F&T/IB STEAM TRAP PRESSURE GAUGE \_\_\_\_ PRESSURE/TEMPERATURE TEST PLUG THERMOMETER FLOW SWITCH TEMPERATURE TRANSMITTER

MISC. VALVES & COCKS

SHUT-OFF VALVE

GLOBE VALVE

 $\longrightarrow$ 

-

S (SIZE) SHOCK ARRESTOR VACUUM BREAKER — WFM WATER FLOW METER REDUCED PRESSURE BACKFLOW ASSEMBLY DCVA DOUBLE CHECK VALVE ASSEMBLY DOUBLE CHECK DETECTOR ASSEMBLY BACKWATER VALVE UNDERGROUND GATE VALVE W/BOX UNDERGROUND GATE W/POST INDICATOR OUTSIDE SCREW & YOKE Y PATTERN BOILER BLOWDOWN VALVE NON-RETURN STOP VALVE QUICK OPENING BOILER BLOWDOWN VALVE GAS COCK VALVE RELIEF VALVE MIXING VALVE PUMP

FIRE F	PROTE	ECTION PIPING
FSP-	- FSP	FIRE STANDPIPE
————FP———	- FP	FIRE PROTECTION
SPR-	- SPR	FIRE SPRINKLER
DP	- DP	DRY PIPE SPRINKLER
————PA———	- PA	PRE-ACTION SYSTEM
WSP	- WSP	WET STANDPIPE
DSP	- DSP	DRY STANDPIPE
———DR———	- DR	SPRINKLER DRAIN PIPING


DEMOLITION LEGEND

\* - - - - - - - - - - - REMOVE EXISTING PIPE

**NEW PIPING** 

NEW AND EXISTING WORK

EXISTING PIPING

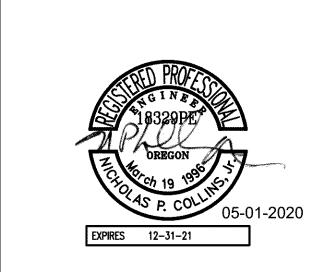

					PLUN	IBING F	IXTURE SCHEDULE	
TAG		ROUGH	-IN SIZE (I	NCHES)		ELEC.		
NUMBER	FIXTURE TYPE	W	V	CW	GPM	CONNECTION	DESCRIPTION	NOTES
EWC-1								
NOTES:								
1. VERIFY VACUUM BREAKER IS PROVIDED AND MANUFACTURER'S WALL MOUNTING PLATE.								

PLUMBING DESIGN CRITERIA (OREGON)
STIC WATER PIPING SYSTEM:
OF DESIGN: 2017 OREGON PLUMBING SPECIALTY CODE, APPENDIX A 'RECOMMENDED RULES FOR SIZING THE

BASIS OF DESIGN: 2017 OREGON PLUMBING SPECIALTY CODE, APPENDIX A 'RECOMMENDED RULES FOR SIZING THE WATER SUPPLY SYSTEM'. PIPING SIZED ON 4 PSI/100 FT. DROP, VELOCITIES NOT TO EXCEED 8 FT./SEC. (COLD WATER)
AND NOT TO EXCEED 5 FT./SEC. (HOT WATER).
WASTE AND VENT PIPING SYSTEM:

BASIS OF DESIGN: 2017 OREGON PLUMBING SPECIALTY CODE, CHAPTER 7, 'SANITARY DRAINAGE'.

ALL WASTE PIPING SIZED AT 1/4"/FT. SLOPE UNLESS OTHERWISE NOTED.

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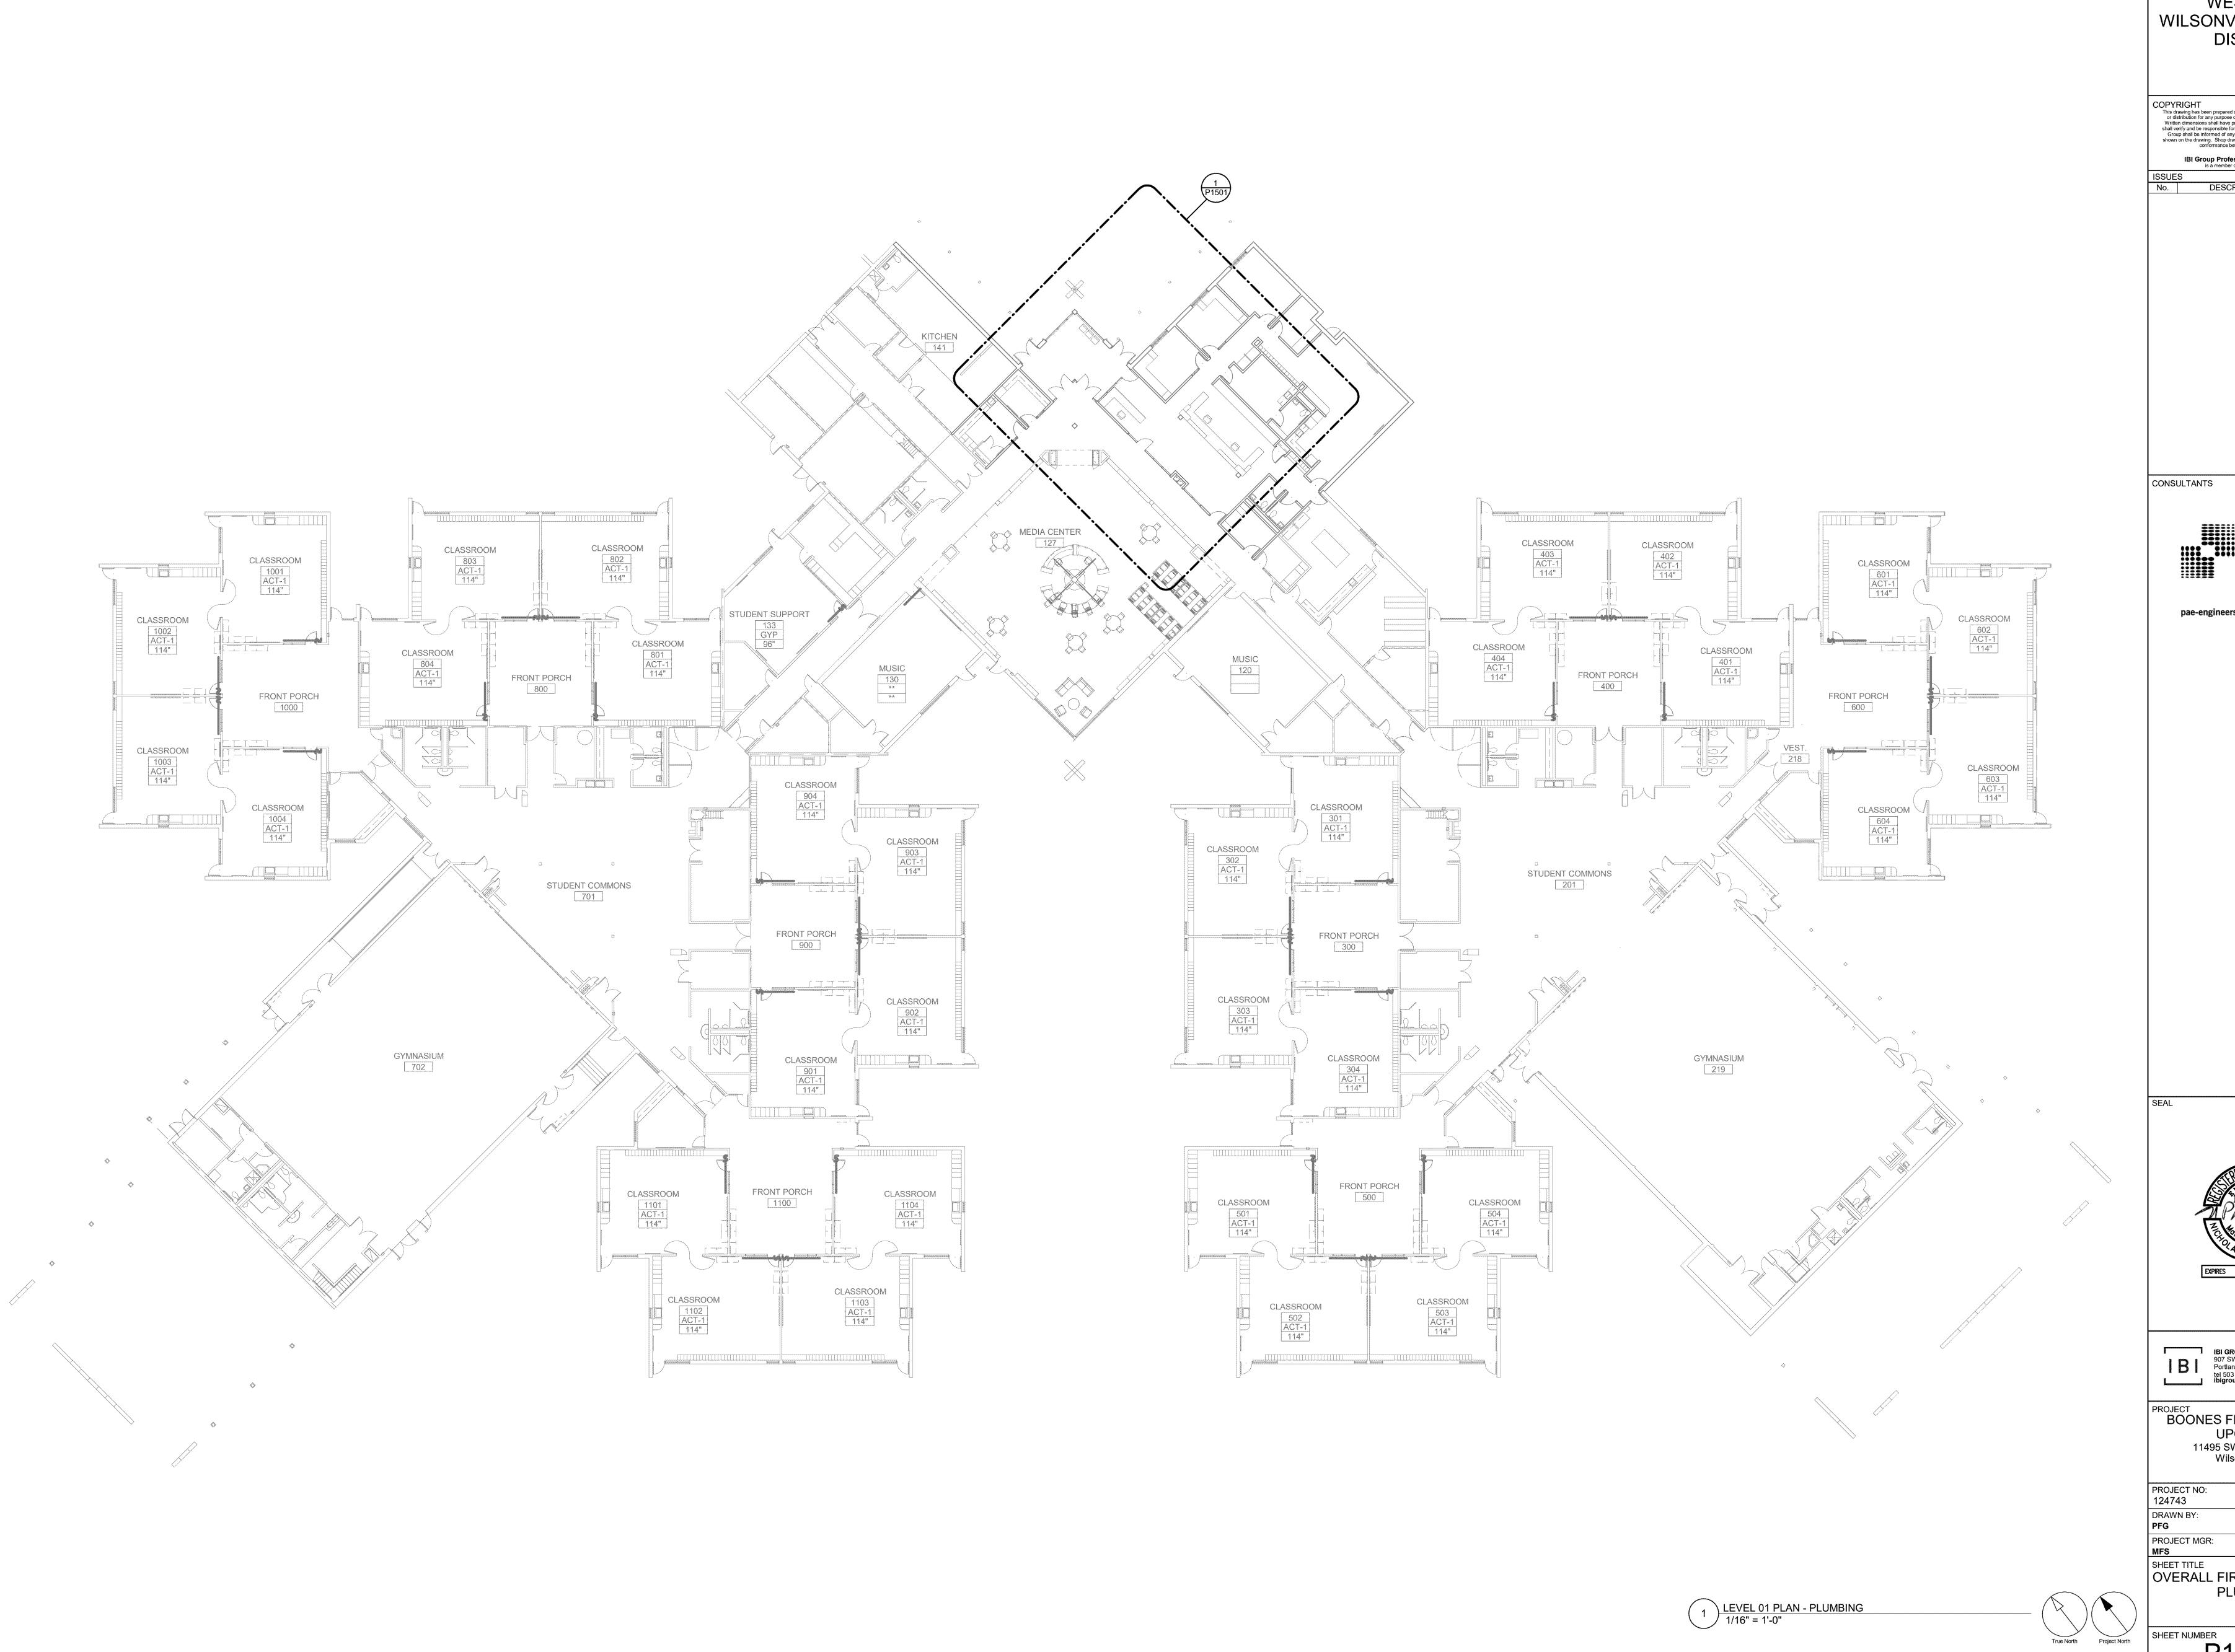
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	97070	
PROJECT NO:		
124743	WL BID PACK 19045.009	

BOONES FERRY SECURITY

DRAWN BY:
PFG
PROJECT MGR:
MFS
APPROVED BY:
NPC
SHEET TITLE

SYMBOLS, LEGENDS AND ABBREVIATIONS - PLUMBING

SHEET NUMBER P0001



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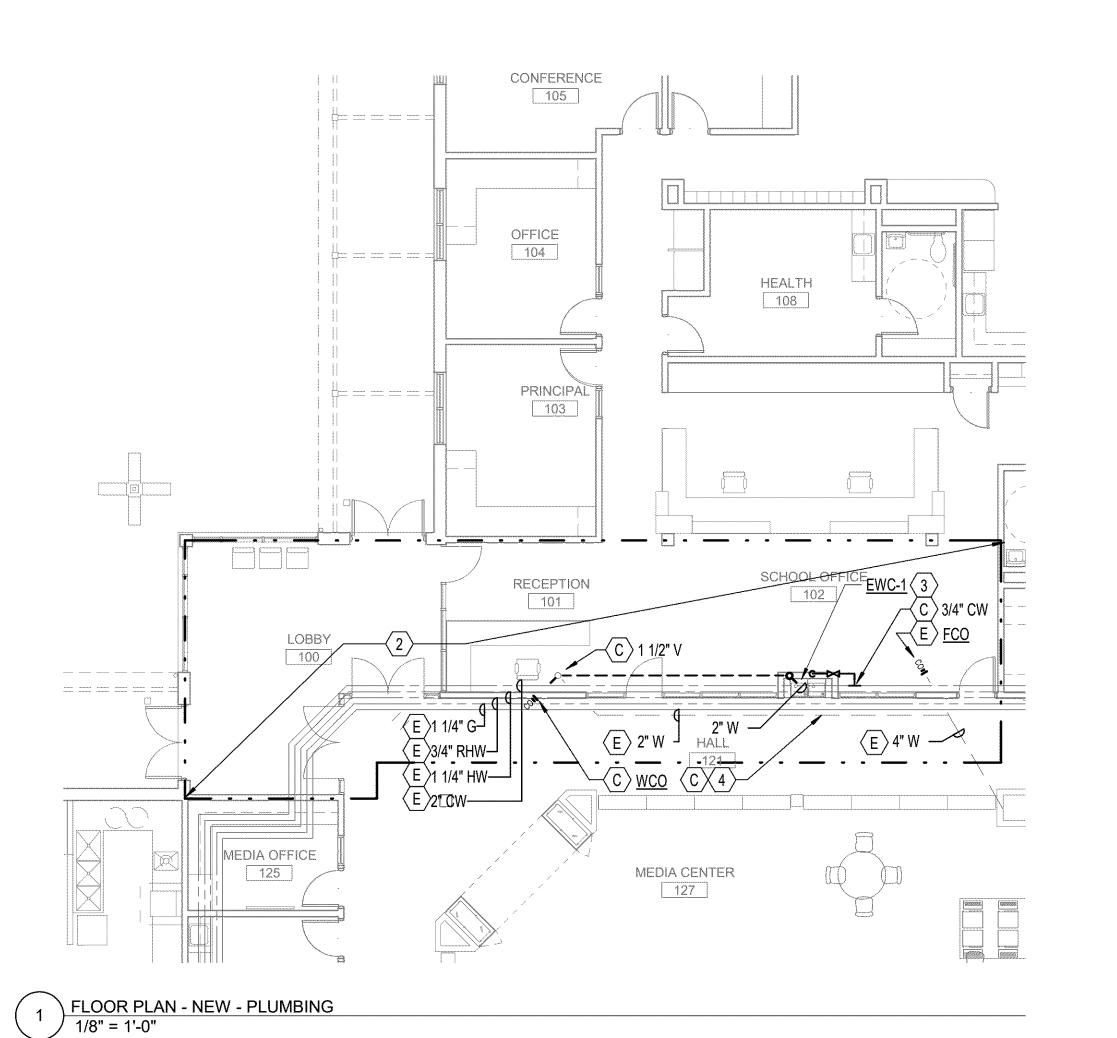
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OVERALL FIRST FLOOR PLAN -**PLUMBING** 

# SCHOOL OFFICE 102 E 2" CW E 3/4" RHW E 1 1/4" HW MÉDIA OFFICE

2 FLOOR PLAN - DEMOLITON - PLUMBING 1/8" = 1'-0"



#### **GENERAL NOTES:**

- A. CONTRACTOR TO DETERMINE EXACT LOCATION OF EXISTING UTILITIES IN FIELD WHETHER OR NOT SHOWN ON DRAWINGS. EXERCISE CAUTION AND IDENTIFY LOCATIONS OF UNMARKED UTILITY LINES AS NECESSARY TO PERFORM WORK OF THIS SECTION.
- B. DEMOLITION WORK SHALL INCLUDE BUT NOT LIMITED TO THE FOLLOWING: REMOVAL OF EQUIPMENT, SUPPORTS, ANCHORS, PIPING, ND ALL APPURTENANCES WHERE NOTED OR INDICATED ON THE PLANS.
- REMOVE EQUIPMENT, PIPING, AND ASSOCIATED ITEMS AS SHOWN OR RELATED TO EQUIPMENT TAGGED TO BE REMOVED. CAP PIPING AT NEAREST LIVE BRANCH. CAP WASTE PIPING BELOW FINISHED FLOOR.
- D. WHERE A PLUMBING FIXTURE OR DEVICE IS SHOWN TO BE DEMOLISHED, REMOVE CW, HW, VENT, AND WASTE SERVING THAT FIXTURE BACK TO MAINS AND CAP.
- IT SHALL BE THE RESPONSIBILITY OF THE CONTRACTOR TO COORDINATE THE WORK WITH THAT OF ALL OTHER TRADES, INCLUDING BUT NOT LIMITED TO: ELECTRICAL, HVAC, SPRINKLER, PLUMBING, STRUCTURAL, AND GENERAL ARCHITECTURE.
- F. ALL PLUMBING EQUIPMENT, PIPING, INSULATION, ETC. INSTALLED IN HVAC PLENUM SPACES SHALL MEET CODE REQUIREMENTS FOR SMOKE AND COMBUSTIBILITY.
- VERIFY EXACT SIZES, LOCATIONS, INVERTS, AND ELEVATIONS PRIOR TO RUNNING ANY PIPING. REFER TO ARCHITECTURAL DRAWINGS FOR EXACT LOCATIONS OF ALL FIXTURES AND EQUIPMENT.
- H. VERIFY EXISTING CONDITIONS PRIOR TO BEGINNING WORK. PRIOR TO PROCEEDING WITH WORK NOTIFY ARCHITECT ABOUT ANY DISCREPANCIES BETWEEN THE DESIGN DOCUMENTS AND FIELD CONDITIONS.
- ALL EXISTING FIRE PROTECTION SYSTEMS, PIPING, AND EQUIPMENT OUTSIDE OF PROJECT SCOPE TO REMAIN ACTIVE.
- J. FIRE PROTECTION SYSTEM SHALL REMAIN FULLY FUNCTIONAL DURING ENTIRE CONSTRUCTION PHASE.
- K. MODIFY THE EXISTING PIPING DISTRIBUTION AS NEEDED AND INSTALL NEW QUICK RESPONSE SPRINKLER HEADS THROUGHOUT THE PROJECT AREA TO PROVIDE FULL AREA COVERAGE AS REQUIRED BY NFPA 13.

CLIENT

**WEST LINN** WILSONVILLE SCHOOL DISTRICT

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ISSUES DESCRIPTION DATE

CONSULTANTS



pae-engineers.com

#### NOTES:

- 1. DEMO EXISTING ELECTRIC WATER COOLER, DEMO CW, HW, VENT, AND WASTE BACK TO NEAREST MAIN AND CAP. CAP WASTE PIPING BELOW FINISHED FLOOR.
- PROVIDE FIRE SPRINKLER SYSTEM IN ACCORDANCE WITH THE REQUIREMENTS OF NFPA 13 AND LOCAL FIRE CODE. REFER TO SPECIFICATIONS FOR DESIGN BUILD REQUIREMENTS. REFER TO PLANS FOR COORDINATION WITH OTHER CEILING MOUNTED EQUIPMENT. ARCHITECT TO HAVE FINAL SIGN OFF ON SPRINKLER PIPING AND PIPE ROUTING. FIRE PROTECTION CONTRACTOR IS REPONSIBLE FOR FULL SPRINKLER DESIGN, INCLUDING COORDINATED SHOP DRAWINGS AND HYDRAULIC CALCULATIONS.
- INSTALL NEW ELECTRIC WATER COOLER (BOTTLE FILLER) AS SHOWN ON ARCHITECTURAL DRAWINGS. ROUTE NEW CW PIPING AND CONNECT TO NEAREST EXISTING MAIN. VERIFY VACUUM BREAKER IS PROVIDED IN ACCORDANCE WITH MANUFACTURER'S CERTIFIED INSTALLATION DRAWINGS.
- 4. SAWCUT NEW WASTE PIPE ROUTE AS NEEDED AND CONNECT TO NEAREST EXISTING WASTE MAIN.



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PROJECT NO: 124743 WL BID PACK 19045.009 CHECKED BY: APPROVED BY: PROJECT MGR:

SHEET TITLE
ENTRY PLANS - PLUMBING

SHEET NUMBER P1501

## BOONES FERRY SECURITY VESTIBULE

WILSONVILLE, OR 100% CD SET - MAY 1, 2020

## STRUCTURAL SHEETS:

eet Number	Sheet Title
S0001	COVER SHEET
S1501	FLOOR PLAN AND DETAILS

STF	RUCTURAL ABB	REVIA	TIONS:				
<u> </u>	At	ENGR	Engineer	LVL	Laminated Veneer Lumber	SL	Snow Load
L	And	EQ	Equal			SIM	Similar
	Feet	EOR	Engineer of Record	MANUF	Manufacturer, Manufactured	SOG	Slab on Grade
	Inch	EW	Each Way	MAX	Maximum	SPEC	Specification, Specifications
	Number, Pound	EXT	Exterior	MECH	Mechanical	STD	Standard
	Existing			MEZZ	Mezzanine	STIFF	Stiffener
	New	FAB	Fabricate	MIN	Minimum	STL	Steel
		FT	Foot, Feet	MISC	Miscellaneous	STRUCT	Structural
	Anchor Bolt	FTG	Footing	MTL	Metal		
I	American Concrete Institute					T&B	Top and Bottom
D	Addendum, Addition	GA	Gauge	N	North	T&G	Tongue and Groove
Ī	Alternate	GALV	Galvanized	NO	Number	ТОВ	Top of Beam
СН	Architect, Architectural	GC	General Contractor	NTS	Not To Scale	TOF	Top of Footing
	American Society for Testing and	GEN	General			TOJ	Top of Joist
ΓM	Materials	GL	Glulam (Glue-Laminated Beam)	oc	On Center	TOS	Top of Slab, Top of Steel
G	Average	GR	Grade	OPP	Opposite	TOW	Top of Wall
S	American Welding Society	GYP	Gypsum	OWSJ	Open Web Steel Joist	TRANS	Transverse
		GYP BD	Gypsum Board	000	- F	TYP	Typical
/	Bevel	OH BB	Syptom Social	PAF	Powder Actuated Fasteners	1.11	7,7,000.
G	Building	HDD	Headed	PCF	Pounds per Cubic Foot	UNO	Unless Noted Otherwise
G	Blocking	HDR	Header	PERIM	Perimeter	ONO	officas Noted Officiwise
Г	Bottom	HORIZ	Horizontal	PERP	Perpendicular	VERT	Vertical
	Base Plate	HSS	Hollow Structural Shape	PL	Plate	VIF	Verify In Field
OG	Bridge, Bridging	HVAC	Heating, Ventilating, Air Conditioning	PLF	Pounds per Lineal Foot	VII	verny in ricid
		HT	Height	PREFAB	Prefabricated	W/	With
	Control Joint	пі	Height		Pounds per Square Foot		
	Centerline	IDC	International Building Code	PSF	Pounds per Square Inch	W/O	Without
3	Ceiling	IBC	International Building Code	PSI	THE CONTRACTOR AND THE PARTY OF	WD	Wood
- R	Clear	IN	Inch	PSL	Parallel Strand Lumber	WF	Wide Flange (Structural Steel)
Ĺ	Column	INFO	Information	PT	Post-Tensioned, Preservative-Treated	WT	Weight
NC	Concrete	INSUL	Insulation		1 reservative-freated	WWF	Welded Wire Fabric
NT	Continuous	INT	Interior	QTY	Quantity		
		JST	Joist				
Ą	Deformed Bar Anchor			REF	Refer, Reference		
_	Double	KIP	Kilopound (1000 pounds)	REINF	Reinforce, Reinforcement		
	Doug Fir (Douglas Fir)			REQ'D	Required		
	Diameter	L	Angle, Left, Length	REV	Revision		
PH	Diaphragm	LAM	Laminate, Laminated				
	Dimension	LAT	Lateral	SCHED	Schedule		
	Dead Load	LLH	Long Leg Horizontal	SE	Structural Engineer		
G	Drawing	LLV	Long Leg Vertical	SECT	Section		
L	Dowel	LL	Live Load	SHTH	Sheathing		
		LONG	Longitudinal	SIMP	Simpson Strong-Tie		
	Each	LONG	Laminated Strand Lumber	SF	Square Foot		

Laminated Strand Lumber

#### TYPICAL SYMBOLS:

- NOTE: SOME SYMBOLS SHOWN MAY NOT BE IN USE -\ - INDICATES REVISION DELTA
- INDICATES REVISION CLOUD

- INDICATES DETAIL REFERENCE

ations	
eel	
se	
al Steel)	
,	

#### GENERAL STRUCTURAL NOTES & SPECIAL INSPECTION

 REMODEL OF EXISTING SCHOOL ENTRY FOR SECURITY VESTIBULE RECONFIGURE AND ADD HOLDOWNS TO WOOD SHEAR WALLS IN WALL LINE. INSTALL NEW GLUAM ROOF BEAM WITH LONGER SPAN

- THE STRUCTURAL DRAWINGS ARE A PORTION OF THE CONTRACT DOCUMENTS AND ARE INTENDED TO BE USED IN CONJUNCTION WITH THE ARCHITECTURAL, CIVIL, MECHANICAL, AND ELECTRICAL DRAWINGS. THE CONTRACTOR IS RESPONSIBLE FOR COORDINATING THE REQUIREMENTS FROM THE ENTIRE SET OF CONTRACT DOCUMENTS (INCLUDING THE PROJECT
- SPECIFICATIONS) INTO THEIR WORK. THESE GENERAL NOTES SUPPLEMENT THE PROJECT SPECIFICATIONS. REFER TO THE PROJECT SPECIFICATIONS FOR ADDITIONAL REQUIREMENTS.
- NOTES AND DETAILS ON THE STRUCTURAL DRAWINGS SHALL TAKE PRECEDENCE OVER THE GENERAL STRUCTURAL NOTES AND TYPICAL DETAILS. CONTRACTOR SHALL VERIFY ALL DIMENSIONS AND ELEVATIONS PROVIDED ON STRUCTURAL DRAWINGS WITH ALL DISCIPLINES INCLUDING, BUT NOT LIMITED TO ARCHITECTURAL,
- GEOTECHNICAL ENGINEER, AND CIVIL ENGINEER PRIOR TO CONSTRUCTION. DETAILS ON THESE PLANS ARE INTENDED TO DEPICT THE GENERAL CONSTRUCTION METHODS FOR THIS STRUCTURE, CONNECTIONS, DETAILS AND CONDITIONS NOT SPECIFICALLY SHOWN. THAT ARE SIMILAR TO THOSE THAT ARE SPECIFIED SHALL BE ASSUMED ONE AND THE SAME. IF QUESTIONS REGARDING THE APPLICATION OF DETAILS ARE ENCOUNTERED, NOTIFY THE ARCHITECT/ENGINEER FOR CLARIFICATION IN A TIMELY MANNER PRIOR TO BID OPENING.

CONFORM TO THE 2019 OREGON STRUCTURAL SPECIALTY CODE (OSSC), BASED UPON THE 2018 INTERNATIONAL BUILDING CODE (IBC). 2. ALL REFERENCE TO OTHER CODES AND STANDARDS (ACI, ASTM, ETC.) SHALL BE FOR THE EDITIONS NOTED IN CHAPTER 35 OF THE IBC.

THE STRUCTURE HAS BEEN DESIGNED TO FUNCTION AS A UNIT UPON COMPLETION. THE CONTRACTOR IS RESPONSIBLE FOR FURNISHING ALL TEMPORARY BRACING AND/OR SUPPORT REQUIRED AS A RESULT OF THE CONTRACTOR'S CONSTRUCTION METHODS AND/OR

CONTRACTOR'S CONSTRUCTION METHODS AND/OR SEQUENCES SHALL RECOGNIZE AND CONSIDER THE EFFECTS OF THERMAL MOVEMENTS OF STRUCTURAL ELEMENTS DURING THE CONSTRUCTION PERIOD.

#### **EXISTING CONDITIONS:**

ALL EXISTING CONDITIONS, DIMENSIONS, AND ELEVATIONS SHALL BE FIELD VERIFIED. THE CONTRACTOR SHALL NOTIFY THE ARCHITECT OF ANY SIGNIFICANT DISCREPANCIES FROM CONDITIONS SHOWN ON THE DRAWINGS.

DESIGN WAS BASED ON THE STRENGTH AND DEFLECTION CRITERIA OF THE IBC. IN ADDITION TO THE DEAD LOADS, THE FOLLOWING LOADS AND ALLOWANCES WERE USED FOR DESIGN, WITH LIVE LOADS (LL) REDUCED IN ACCORDANCE WITH THE IBC:

	DESIGN CRITERIA		
	SNOW CRITERIA		
DESIGN ROOF SNOW LOAD	25 PSF MINIMUM IN ACCORDA	NCE WITH THE OSSC	
SNOW DRIFT	PER OSSC AS SHOWN ON PLANS (IN ADDITION TO DESIGN ROOF SNOW LOAD, NOT FLAT ROOF SNOW LOAD)		
GROUND SNOW LOAD	P g = 10 PSF IN ACCORDANCE WITH 2007 SNOW LOAD ANALYSIS FOR OREGON		
FLAT ROOF SNOW LOAD	P <sub>f</sub>	P <sub>f</sub> = 8 PSF	
SNOW EXPOSURE FACTOR	C e	= 1.0	
SNOW LOAD IMPORTANCE FACTOR		= 1.1	
THERMAL FACTOR	Ct	= 1.0	
	WIND CRITERIA		
MAIN WIND FORCE RESISTING SYSTEM	103 MPH BASIC WIND SPEED (3-SECOND GUST)		
COMPONENTS AND CLADDING	103 MPH BASIC WIND SPEED (3-SECOND GUST)		
EXPOSURE CATEGORY	С		
GUST/INTERNAL PRESSURE	GC pi = +/- 0.18		
	SEISMIC CRITERIA		
RISK CATEGORY	III		
SITE CLASS	D		
IMPORTANCE FACTOR	I <sub>e</sub> = 1.25		
SEISMIC DESIGN CATEGORY	D		
MCE SPECTRAL ACCELERATIONS	S = 0.817	S <sub>1</sub> = 0.384	
SITE COEFFICIENTS	F <sub>a</sub> = 1.173		
DESIGN SPECTRAL ACCELERATIONS	S = 0.639		
ANALYSIS PROCEDURE	EQUIVALENT LATERAL FORCE, REF ASCE 7-10 SECTION 12.8		
SEISMIC LOAD RESISTING SYSTEM	LIGHT FRAMED WOOD SHEAR WALLS		
RESPONSE MODIFICATION FACTOR	R = 6.5		
SEISMIC RESPONSE COEFFICIENT	Cs= 0.123	3	

SPECIAL INSPECTION WILL BE PROVIDED BY THE OWNER BASED ON THE REQUIREMENTS OF THE IBC AS SUMMARIZED IN THE SPECIAL INSPECTION AND TESTING PROGRAM ON THIS SHEET. THE CONTRACTOR SHALL PROVIDE SUFFICIENT NOTICE AND ACCESS FOR THE SPECIAL INSPECTOR TO PERFORM THESE INSPECTIONS.

STRUCTURAL OBSERVATIONS		
CONSTRUCTION PHASE	OBSERVATION BY SER	COMMENTS
AT COMPLETION OF STRUCTURAL WORK, PRIOR TO COVERING OF STRUCTURAL ELEMENTS	×	REF. FOOTNOTE A, B

STRUCTURAL OBSERVATIONS ARE INTENDED TO VERIFY GENERAL CONFORMANCE WITH

- THE STRUCTURAL DRAWINGS. SPECIAL INSPECTIONS AND TESTING ARE STILL
- C. STRUCTURAL OBSERVATION TO OCCUR AFTER THE REINFORCING STEEL HAS BEEN

### EPOXY REPAIR ADHESIVE SHALL CONFORM TO ASTM C881 AND SHALL BE A TWO-COMPONENT

- LIQUID EPOXY WITH NON-SAG CONSISTENCY AND LONG POT LIFE. THE EPOXY ADHESIVE SHALL BE SUITABLE FOR USE ON DRY OR DAMP SURFACES.
- ADHESIVE SHALL HAVE A MINIMUM SLANT SHEAR STRENGTH OF 5,000 PSI AND A MINIMUM TENSILE STRENGTH OF 4,000 PSI.
- HOLE SIZES AND INSTALLATION SHALL BE IN STRICT ACCORDANCE WITH THE MANUFACTURER'S RECOMMENDATIONS AND THE REQUIREMENTS SET FORTH IN THE APPROVED ICC EVALUATION
- REINFORCEMENT SHALL NOT BE CUT OR DAMAGED IN EITHER NEW OR EXISTING CONCRETE
- DURING INSTALLATION.

## 5. APPROVED POST-INSTALLED ANCHORS ARE AS FOLLOWS:

HOT-DIPPED GALVANIZED.

#### APPROVED POST-INSTALLED CONCRETE ANCHORS WITH EPOXY ADHESIVE SIMPSON SET-3G ICC ESR-4057 ICC ESR-3298 **DEWALT PURE110+** HILTI HIT-RE 500V3 ICC ESR-3814

- ANCHOR LOCATIONS AND REQUIREMENTS SHALL CONFORM TO THOSE NOTED SPECIFICALLY ON THE STRUCTURAL DRAWINGS. ALL OTHER LOCATIONS REQUIRE PRIOR
- ALL ANCHORS SHALL BE INSTALLED IN STRICT CONFORMANCE TO THE APPLICABLE ICC REPORT AND MANUFACTURER'S PRINTED INSTALLATION INSTRUCTIONS.
- REINFORCEMENT SHALL NOT BE CUT IN NEW, OR EXISTING CONCRETE DURING INSTALLATION OF POST-INSTALLED ANCHORS ANCHORS THAT ARE LEFT EXPOSED TO WEATHER SHALL BE STAINLESS STEEL, OR
- 6. ADHESIVE ANCHORS SHALL BE INSTALLED ONLY IN DRY, HAMMER-DRILLED HOLES.
- 7. INSTALLATION OF ADHESIVE ANCHORS SHALL BE PERFORMED ONLY BY ACI/CRSI CERTIFIED ADHESIVE ANCHOR INSTALLATIONS IN HORIZONTAL, UPWARDLY INCLINED, AND OVERHEAD
- ORIENTATIONS SHALL UTILIZE ADHESIVE MANUFACTURER'S PISTON PLUG AND TUBING DELIVERY SYSTEM. PLACE ADHESIVE RETAINING CAP IN THE HOLE AFTER ADHESIVE INJECTION. 9. ADHESIVE ANCHOR INSTALLATIONS EXCEEDING 10" EMBEDMENT IN DOWNWARD INCLINED, AND DOWNWARD ORIENTATIONS SHALL UTILIZE ADHESIVE MANUFACTURER'S PISTON PLUG AND TUBING DELIVERY SYSTEM.

## I. STRUCTURAL STEEL SHALL CONFORM TO THE FOLLOWING MINIMUM ASTM SPECIFICATIONS AND

#### CHANNELS, ANGLES, PLATES--EXCEPT AS NOTED ASTM A-36 (Fy=36 KSI) 2. DESIGN, FABRICATION, AND ERECTION SHALL BE IN ACCORDANCE WITH THE "AISC SPECIFICATION

- FOR THE DESIGN, FABRICATION, AND ERECTION OF STRUCTURAL STEEL BUILDINGS" WITH "COMMENTARY" AND THE "CODE OF STANDARD PRACTICE," WITH EXCEPTIONS AS NOTED IN THE PROJECT SPECIFICATIONS. 3. WELDING SHALL CONFORM TO THE AWS CODES FOR ARC AND GAS WELDING IN BUILDING CONSTRUCTION. WELDING SHALL BE PERFORMED IN ACCORDANCE WITH A WELDED PROCEDURE
- SPECIFICATION (WPS) AS REQUIRED IN AWS D1.1 AND APPROVED BY THE STRUCTURAL ENGINEER OF RECORD. THE WPS VARIABLES SHALL BE WITHIN THE PARAMETERS ESTABLISHED BY THE FILLER-METAL MANUFACTURER. 4. FOR COMPLETE JOINT PENETRATION WELDS ASSOCIATED WITH MEMBER SPLICES AND CONNECTIONS NOT PART OF THE SLRS, WELDS SHALL BE MADE WITH FILLER METAL THAT HAS A
- MINIMUM CVN TOUGHNESS OF 20 FT-LBS AT 40 DEGREES F. 5. WELDS SHALL BE MADE USING E70XX ELECTRODES AND SHALL BE 3/16" MINIMUM, UNLESS NOTED OTHERWISE ON THE DRAWINGS.
- 6. IT IS THE RESPONSIBILITY OF THE CONTRACTOR TO COORDINATE BETWEEN THE ARCHITECTURAL AND STRUCTURAL DRAWINGS TO PRODUCE THE SHOP DRAWINGS.

#### SAWN FRAMING LUMBER:

. SAWN LUMBER SHALL CONFORM TO THE WEST COAST LUMBER INSPECTION BUREAU (WCLIB) OR THE WESTERN WOODS PRODUCTS ASSOCIATION (WWPA) GRADING RULES. 2. ALL LUMBER SHALL BE THE SPECIES AND GRADES AS FOLLOWS:

		SAWN LUMBER	
	USE	SPECIES/GRADE	Fb (PSI)BASE VALUE
	LUMBER 2" TO 4" THICK	DOUGLAS FIR-LARCH NO.2	900
3.	ALL DIMENSIONAL LUMBER AND TIMES THAN 19		
4.	ALL LUMBER IN CONTACT WITH CON	NCRETE OR CMU SHALL BE PRESI	ERVATIVE TREATED (PT) IN

ACCORDANCE WITH THE AMERICAN WOOD PRESERVERS BUREAU (AWPB) UNLESS AN APPROVED

CUTTING AND NOTCHING OF JOISTS AND STUDS SHALL CONFORM TO IBC SECTIONS 2308.4.2.4,

2308.5.9, 2308.5.10 AND THE LIMITATIONS AS NOTED ON THE STRUCTURAL DRAWINGS. ALL FRAMING NAILS SHALL BE OF THE SIZE AND NUMBER INDICATED ON THE DRAWINGS AND CONFORM TO THE "STANDARD SPECIFICATION OF DRIVEN FASTENERS: NAILS, SPIKES, AND

MOISTURE BARRIER IS PROVIDED. ALL PT LUMBER SHALL BEAR THE AWPB QUALITY MARK.

#### STAPLES" (ASTM F1667) AND "POWER-DRIVEN STAPLES AND NAILS FOR USE IN ALL TYPES OF BUILDING CONSTRUCTION" (NER 272). NAILING NOT SHOWN SHALL BE AS INDICATED ON IBC TABLE 2304.9.1, OR NER-272. NAILS SHALL BE IDENTIFIED BY LABELS ATTACHED TO THEIR CONTAINERS, THAT SHOW THE MANUFACTURER'S NAME NAIL SHANK DIAMETER AND LENGTH

NAIL SIZES SHALL BE AS FOLLO		
	FRAMING NAILS	
NAIL TYPE	SHANK DIAMETER (IN)	MINIMUM PENETRATION INTO FRAMING MEMBER (IN)
8d	0.131	1 375

- UNLESS OTHERWISE NOTED ON PLANS, PLYWOOD SHEATHING SHALL BE ATTACHED TO THE FRAMING SUPPORTS AS FOLLOWS:
- BOLTS AND LAG SCREWS SHALL CONFORM TO ANSI/ASME STANDARD B18.2.1-1981. ALL BOLTS AND LAG SCREWS SHALL BE INSTALLED WITH STANDARD CUT WASHERS. ALL A307 BOLTS PRE-DRILL HOLES FOR LAG BOLTS. SOAP THREADS OF LAGS IMMEDIATELY PRIOR TO
- JOIST HANGERS, HOLDOWNS, AND OTHER FRAMING ACCESSORIES SHALL BE MANUFACTURED BY SIMPSON STRONG TIE (OR AN APPROVED EQUAL) AND BE OF THE SIZE AND TYPE SHOWN ON THE DRAWINGS. HARDWARE FASTENERS SHALL BE INSTALLED IN STRICT CONFORMANCE TO THE MANUFACTURER'S REQUIREMENTS. ANY PRODUCT SUBSTITUTIONS TO SIMPSON SHALL MEET OR EXCEED SIMPSON'S PUBLISHED DESIGN CAPACITIES AND MUST HAVE A CURRENT ICC EVALUATION REPORT FOR THE APPLICABLE CODES. FASTENERS (NAILS, BOLTS, SCREWS, LAG SCREWS, ETC) IN CONTACT WITH PT LUMBER AND
- SHEATHING SHALL BE HOT DIPPED ZINC-COATED GALVANIZED STEEL. OTHER FASTENERS AND HARDWARE IN CONTACT WITH PT LUMBER AND SHEATHING SHALL BE OF MECHANICALLY DEPOSITED ZINC-COATED STEEL WITH COATING WEIGHTS IN ACCORDANCE WITH ASTM B695, CLASS 55 MINIMUM. CONNECTORS IN CONTACT WITH EXTERIOR APPLICATIONS OF PT LUMBER AND SHEATHING SHALL HAVE BE ZINC-COATED GALVANIZED STEEL IN ACCORDANCE WITH ASTMA653, TYPE G185. ADDITIONALLY, FASTENER TYPE AND COATINGS SHALL COMPLY WITH THE WRITTEN REQUIREMENTS OF THE MANUFACTURER. NO SUBSTITUTIONS PERMITTED.

SPECIFICATIONS.

- GLUED LAMINATED MEMBERS SHALL BE FABRICATED IN CONFORMANCE WITH THE "AMERICAN NATIONAL STANDARD FOR STRUCTURAL GLUED LAMINATED TIMBER" (ANSI/AITC A190.1), OR OTHER CODE-APPROVED DESIGN, MANUFACTURING AND QUALITY ASSURANCE PROCEDURES. ADHESIVE SHALL BE WET-USE EXTERIOR WATERPROOF GLUE. EACH MEMBER SHALL BEAR AN AITC OR APA-EWS IDENTIFICATION MARK OR BE ACCOMPANIED
- BY A CERTIFICATE OF CONFORMANCE. ONE COAT OF END SEALER SHALL BE APPLIED IMMEDIATELY AFTER TRIMMING IN EITHER THE SHOP OR FIELD. NOTCHING AND/OR BORING OF GLUED LAMINATED MEMBERS (EITHER IN THE SHOP, OR FIELD) IS STRICTLY PROHIBITED UNLESS AS SPECIFICALLY DETAILED IN THE STRUCTURAL DRAWINGS OR
- APPROVED BY THE STRUCTURAL ENGINEER OF RECORD. GLUED LAMINATED TIMBER BEAMS SHALL BE WESTERN SPECIES WITH THE FOLLOWING STRENGTH PROPERTIES, UNLESS OTHERWISE NOTED ON PLANS:

	GLUED LA	MINATED MEMBERS		
COMBINATION SYMBOL (SPECIES)	USE	MODULUS OF ELASTICITY (PSI)	FLEXURAL STRESS (PSI)	HORIZONTAL SHEAR STRESS (PSI)
24F-V4 (DF/DF)	SIMPLE SPAN	1,800,000	2,400	265
24F-V8 (DF/DF)	CANTILEVERED OR CONTINUOUS	1,800,000	2,400	265

SYSTEM or MATERIAL

PENETRATION GROOVE WELDS

NGLE PASS FILLET WELDS

LESS THAN OR EQUAL TO 5/16"

1705.2.2.1

VERIFYING USE OF PROPER

VERIFYING WELDER AND

WELDING INSPECTOR

QUALIFICATIONS

1. ALL HOLDOWN BOLTS AT SHEAR WALLS TO FOUNDATION SHALL NOT BE IN CONTACT W/ PRESERVATIVE TREATED (PT) WOOD. PT WOOD PLATES SHALL HAVE OVERSIZED HOLES 1/4" MIN AND 3/8" MAX LARGER THAN BOLT SIZE. AS AN ALTERNATIVE, THE ANCHOR MAY BE SLEEVED WITH AN INSULATOR BUSHING OR GALVANIZED IN ACCORDANCE W/ ASTM A653. HOLDOWN BOLTS SHALL BE INSTALLED IN ACCORDANCE WITH MANUFACTURER'S

- SPECIFICATIONS.
- 4. REF HOLDOWN SCHEDULE, DETAILS 2/S1501 FOR INSTALLATION REQUIREMENTS 6. HOLDOWN THREADED RODS SHALL BE ASTM A36 STEEL.

1704.2.5

ENGINEERS REQUIRED STRUCTURAL SPECIAL INSPECTIONS Westminster, CO 80234 Office: (720) 799-1001 **FREQUENCY** CODE or IBC CODE STANDARD REFERENCE CONTINUOUS REFERENCE

FOR STRUCTURAL LOAD-BEARING

FABRICATED ON THE PREMISES OF

THE SPECIAL INSPECTOR SHALL

PER AWS D1.1 6.9

ALL WELDS VISUALLY INSPECTED

PER AWS D1.1 6.9

COPY OF WELDING PROCEDURE

SPECIFICATIONS


COPY OF QUALIFICATION CARDS

VERIFY THAT THE FABRICATOR MAINTAINS DETAILED FABRICATION AND QUALITY CONTROL 1704.2.5.1 PROCEDURES AND SHALL REVIEW FOR COMPLETENESS AND ADEQUACY RELATIVE TO THE CODE REQUIREMENT. SPECIAL INSPECTIONS REQUIRED BY SECTION 1705 ARE NOT REQUIRED WHERE THE WORK IS DONE ON THE PREMISES OF A FABRICATOR REGISTERED AND APPROVED TO PERFORM SUCH WORK WITHOUT SPECIAL INSPECTION. APPROVAL SHALL BE BASED UPON REVIEW OF THE FABRICATOR'S WRITTEN PROCEDURAL AND QUALITY CONTROL MANUALS AND PERIODIC 1704.2.5.2 AUDITING OF FABRICATION PRACTICES BY A NATIONALLY RECOGNIZED ACCREDITING AUTHORITY. AT COMPLETION OF FABRICATION, THE APPROVED FABRICATOR SHALL SUBMIT A CERTIFICATE OF COMPLIANCE TO THE BUILDING OFFICIAL STATING THAT THE WORK WAS PERFORMED IN ACCORDANCE WITH THE APPROVED CONSTRUCTION DOCUMENTS. CONCRETE ANCHOR PRODUCT NAME, TYPE, AND DIMENSIONS, HOLE DIMENSIONS, COMPLIANCE WITH INSPECTION OF ANCHORS DRILL BIT REQUIREMENTS, TABLE 1705.3 3.8.6, 8.1.3, INSTALLED IN HARDENED CLEANLINESS OF THE HOLE AND ANCHOR, ADHESIVE EXPIRATION CONCRETE DATE, ANCHOR/ADHESIVE INSTALLATION, ANCHOR EMBEDMENT, AND TIGHTENING INSTALLED IN HORIZONTALLY OR JPWARDLY INCLINED ACI 318-11 VERIFYING ADHESIVE ANCHOR COPY OF ACI/CRSI ADHESIVE INSTALLER CERTIFICATIONS ANCHOR CERTIFICATION CARDS ACI 318-14 SECTION 17.8.2.2 REFER TO INSPECTION OF FABRICATOR REQUIREMENTS FABRICATION OF STRUCTURAL 1704.2.5.2 AISC 360 N2 APPROVAL BASED ON NATIONALLY RECOGNIZED ACCREDITING AUTHORITY STANDARDS SPECIFIED IN CONSTRUCTI 1705.2.1 MATERIAL VERIFICATION OF TABLE 1705.2 DOCUMENTS CERTIFIED MILL TEST REPORTS AISC 360 AISC 360 A3.1 AISC 360 **AISC 360** MATERIAL VERIFICATION OF MANUFACTURER'S CERTIFICATE TABLE 1705.2 A3.5 WELD FILLER METALS OF COMPLIANCE APPLICABLE AWS A5 COMPLETE AND PARTIAL JOINT AWS D1.1 ALL WELDS VISUALLY INSPECTED TABLE 1705.2

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**WEST LINN** 

WILSONVILLE SCHOOL

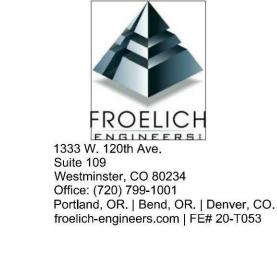


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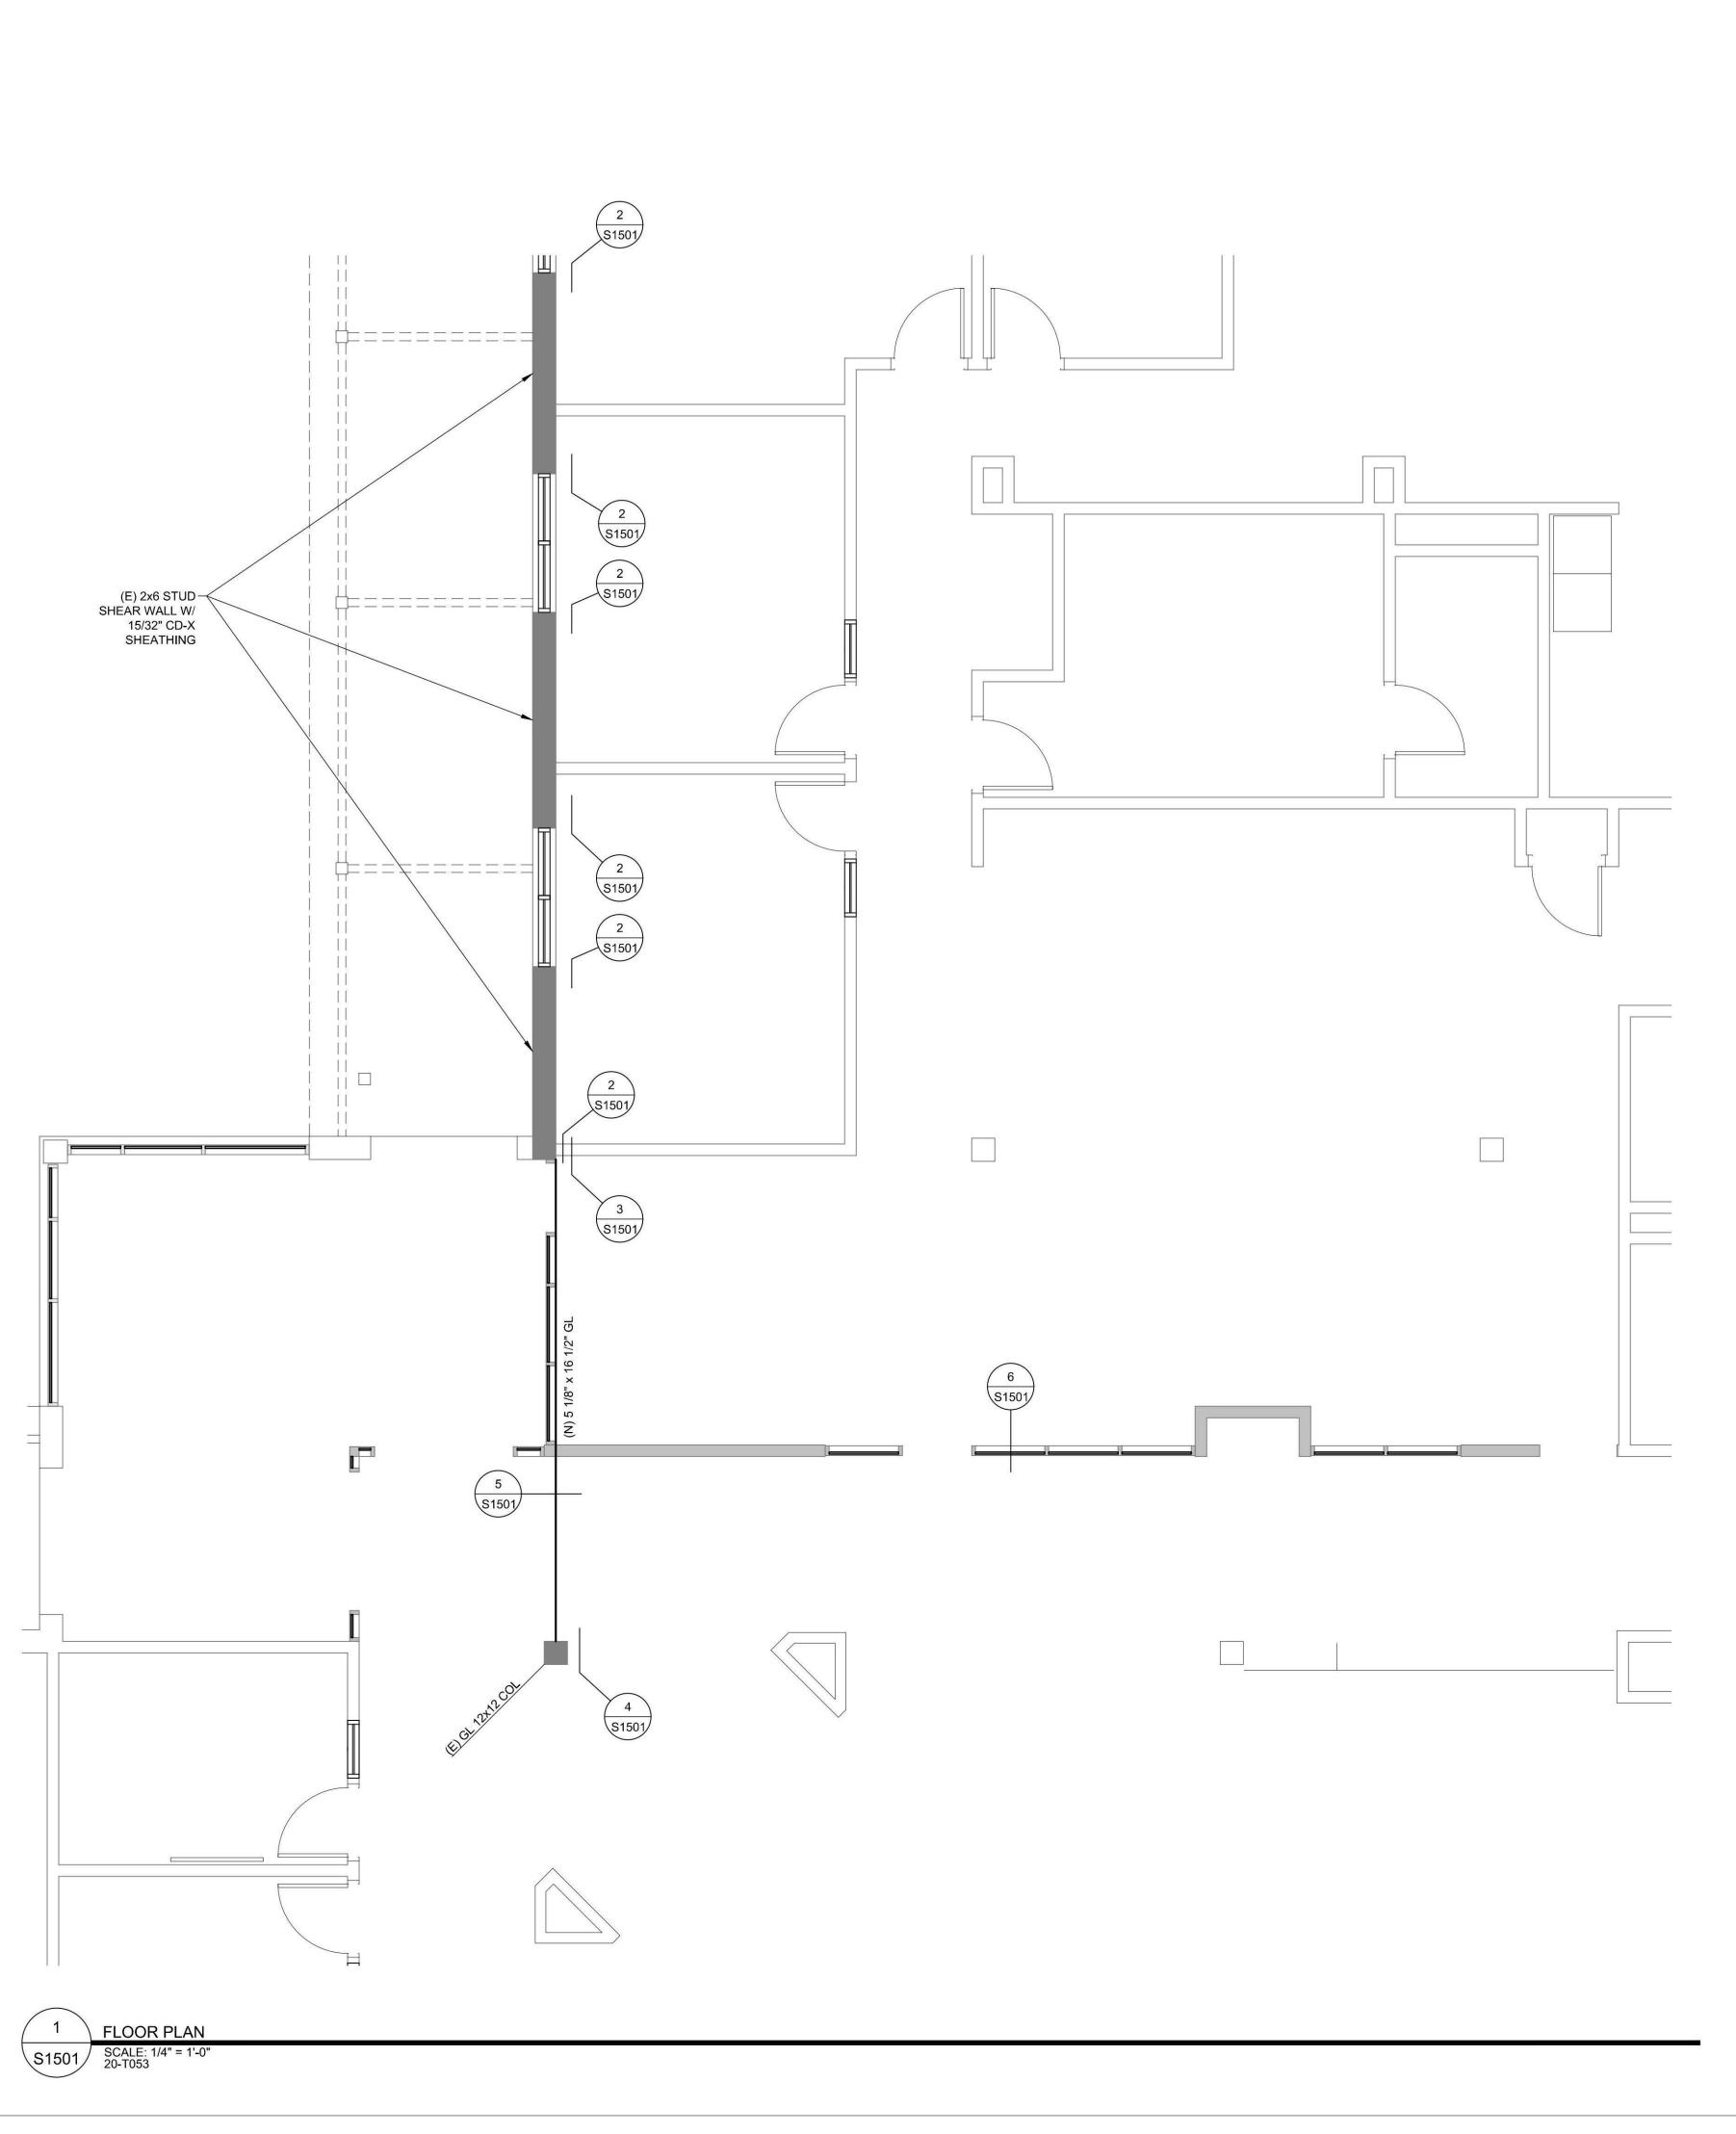
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**COVER SHEET** 

SHEET NUMBER





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Wilsonville, OR
97070

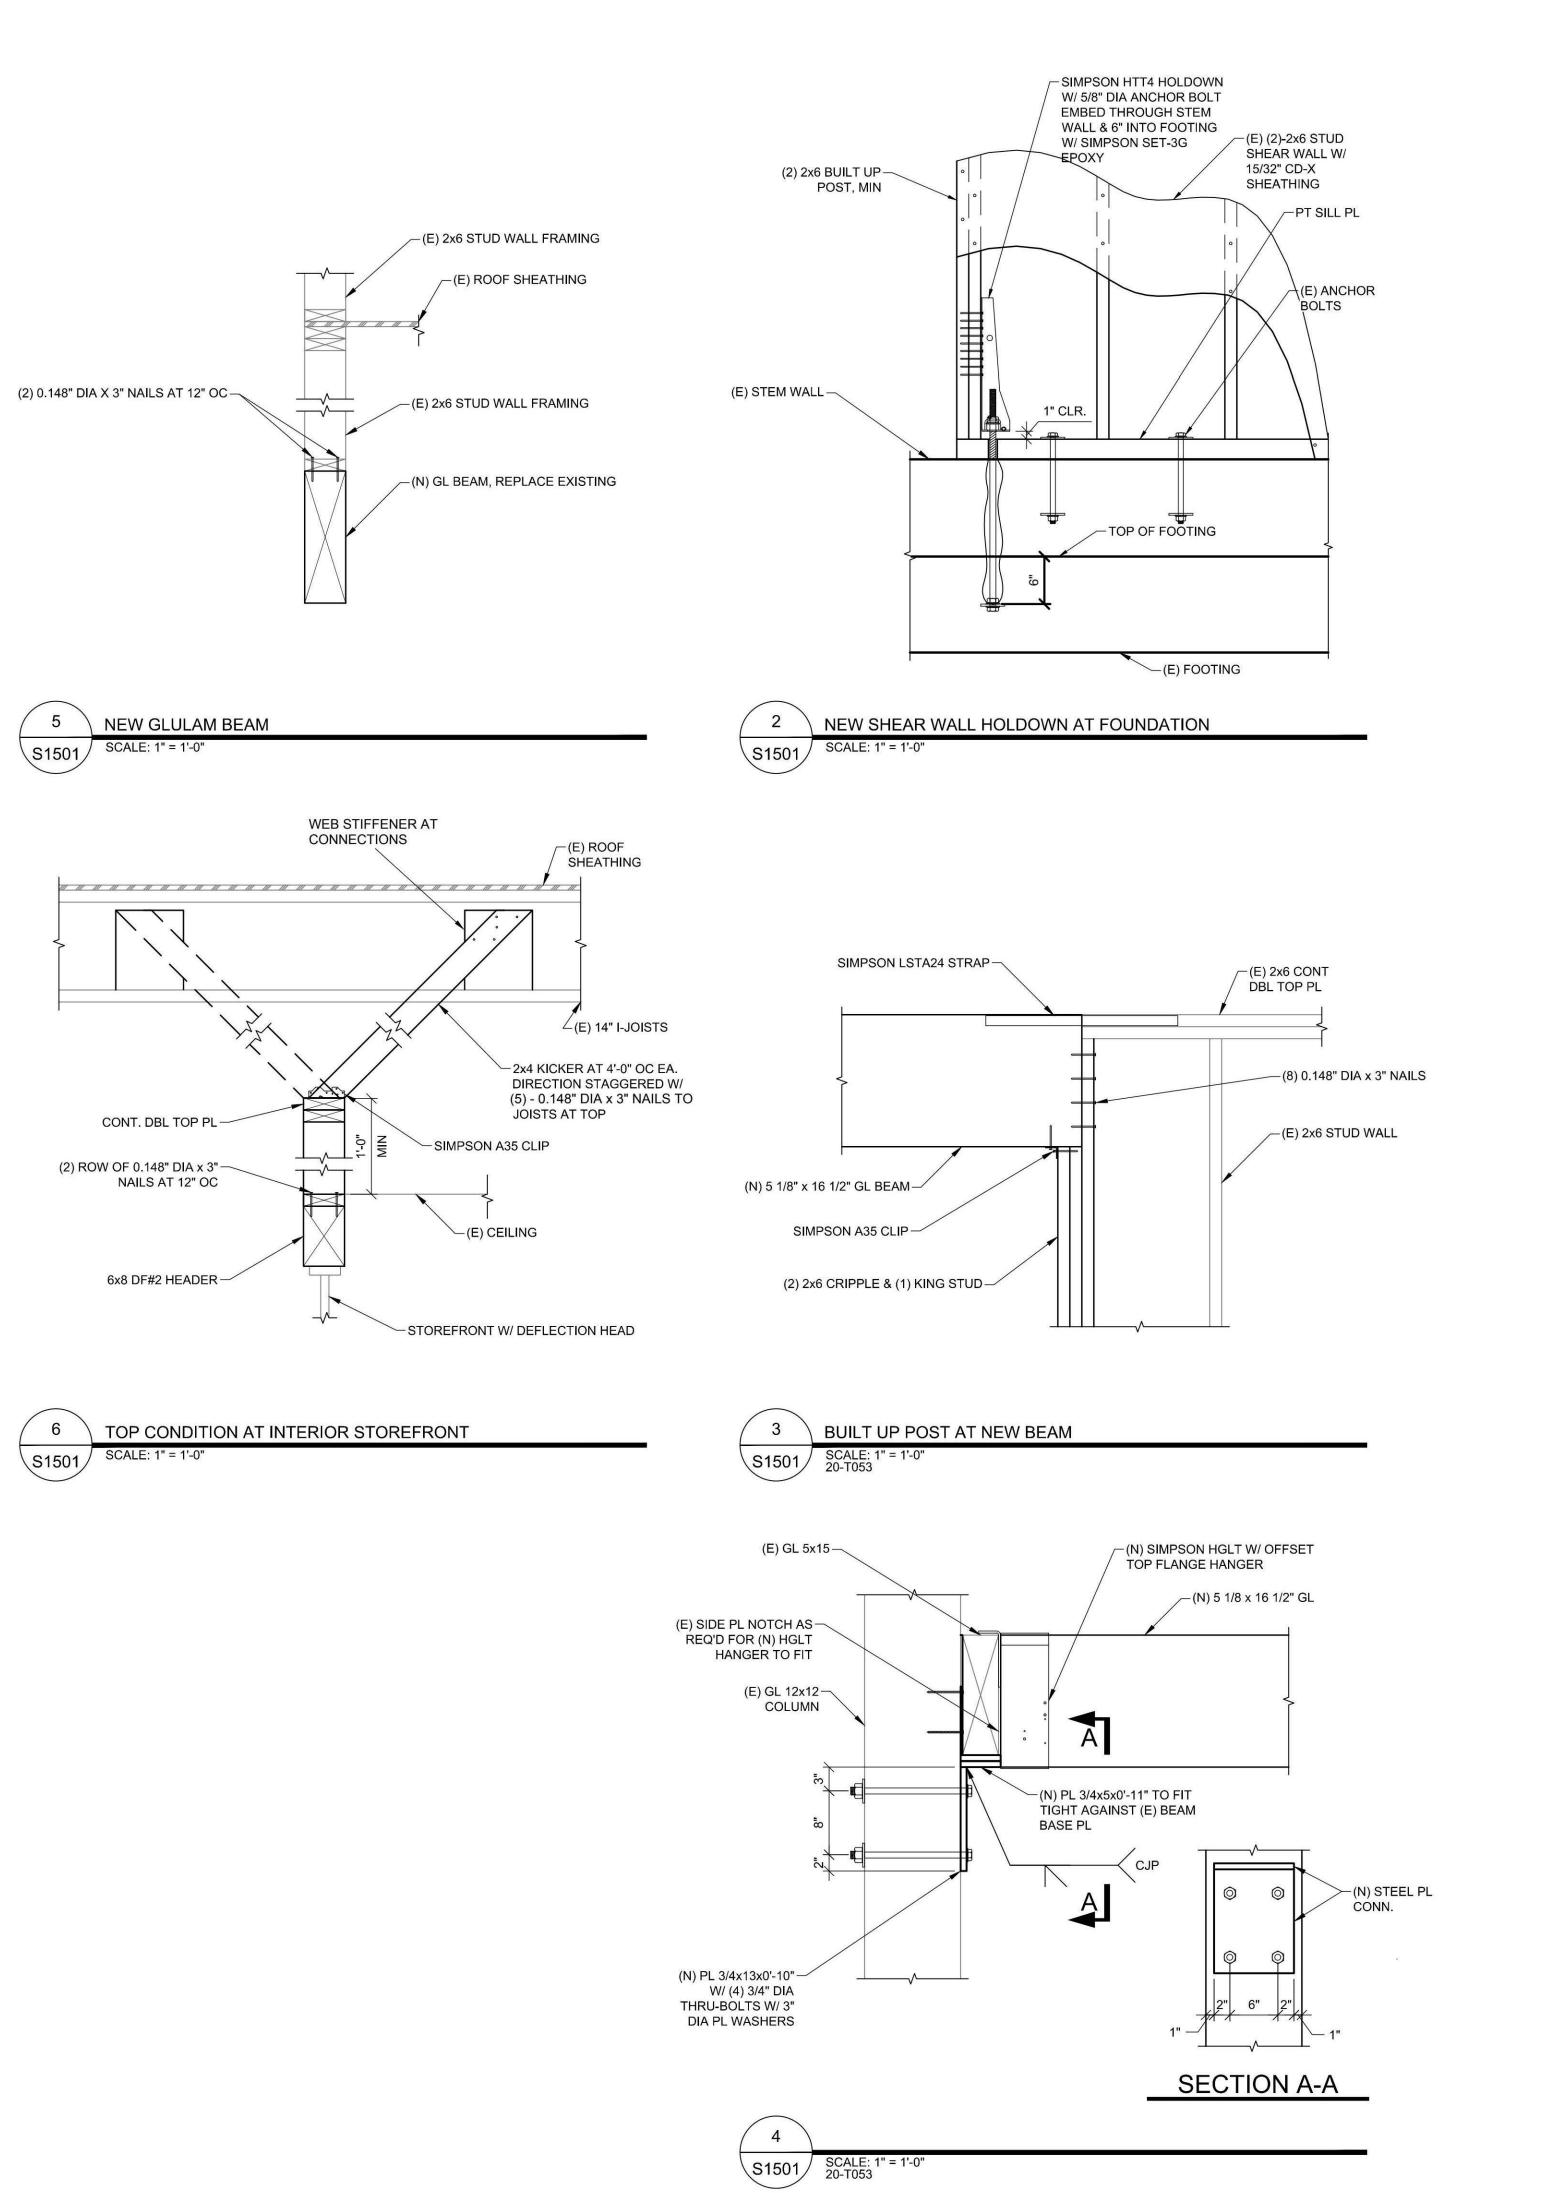PROJECT NO:
124743 WL BID PACK 19045.009

DRAWN BY:
Author


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SHEET TITLE

PLANS

ISSUE

SHEET NUMBER S1501

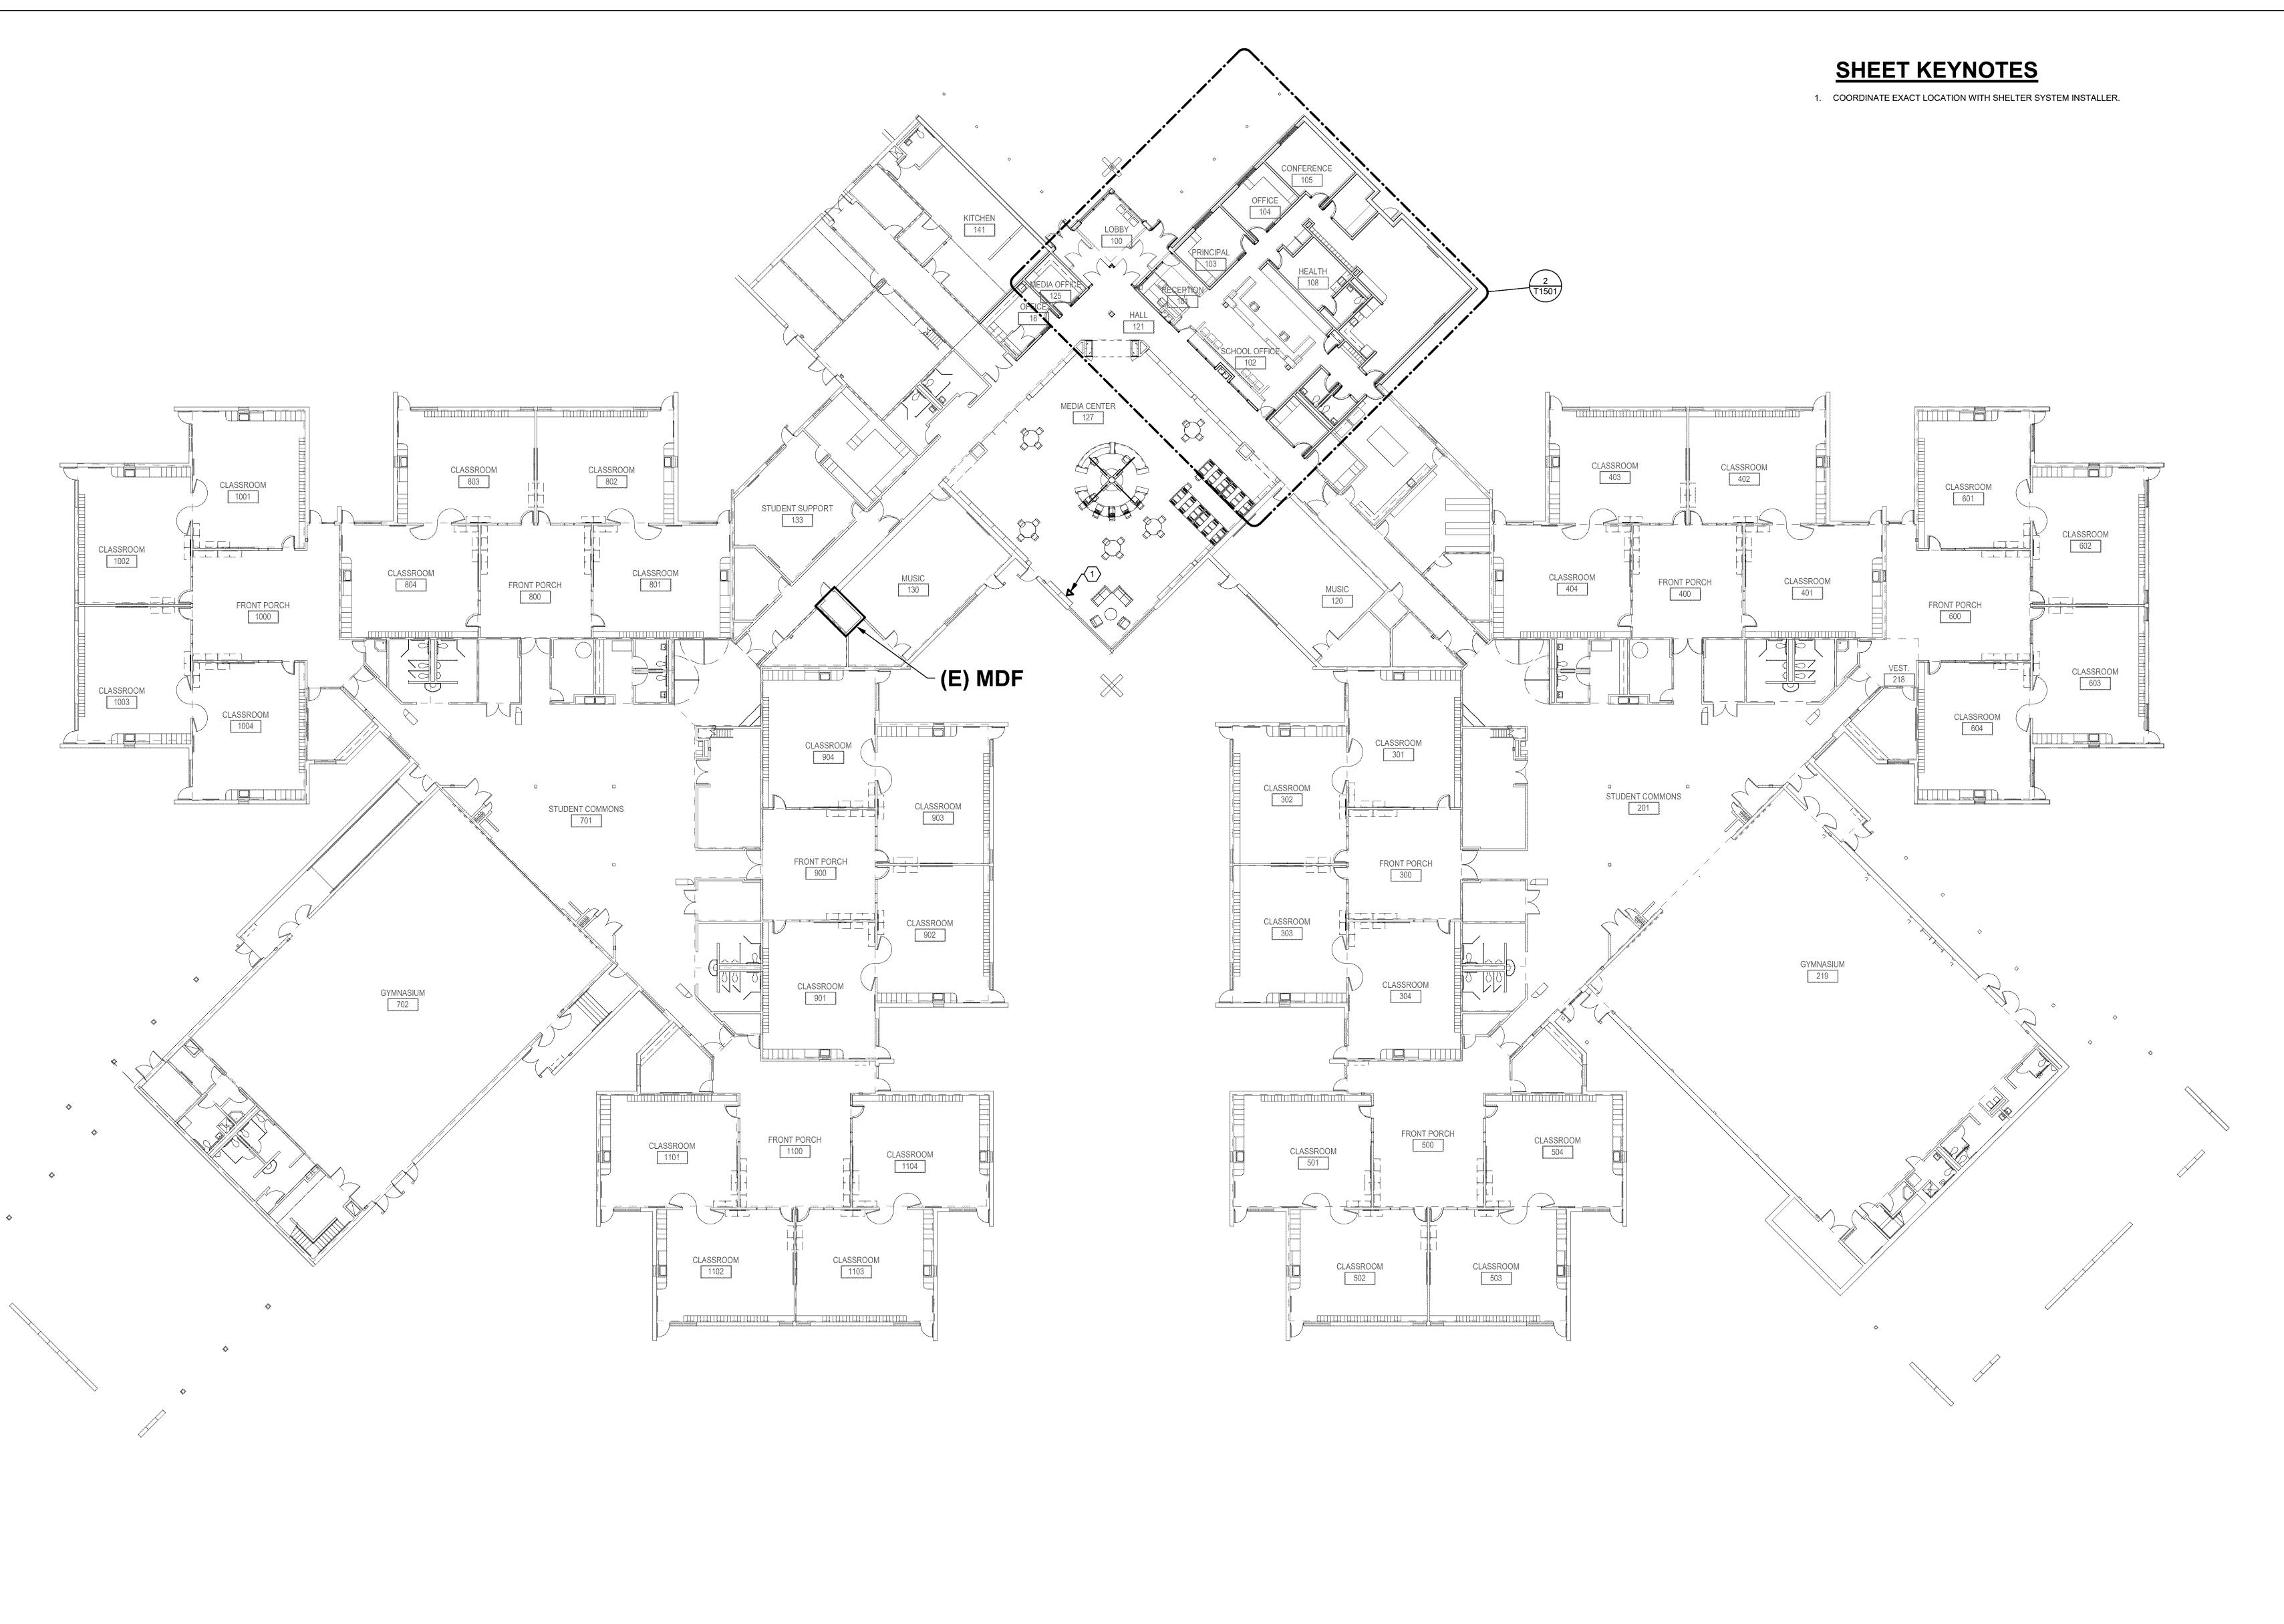

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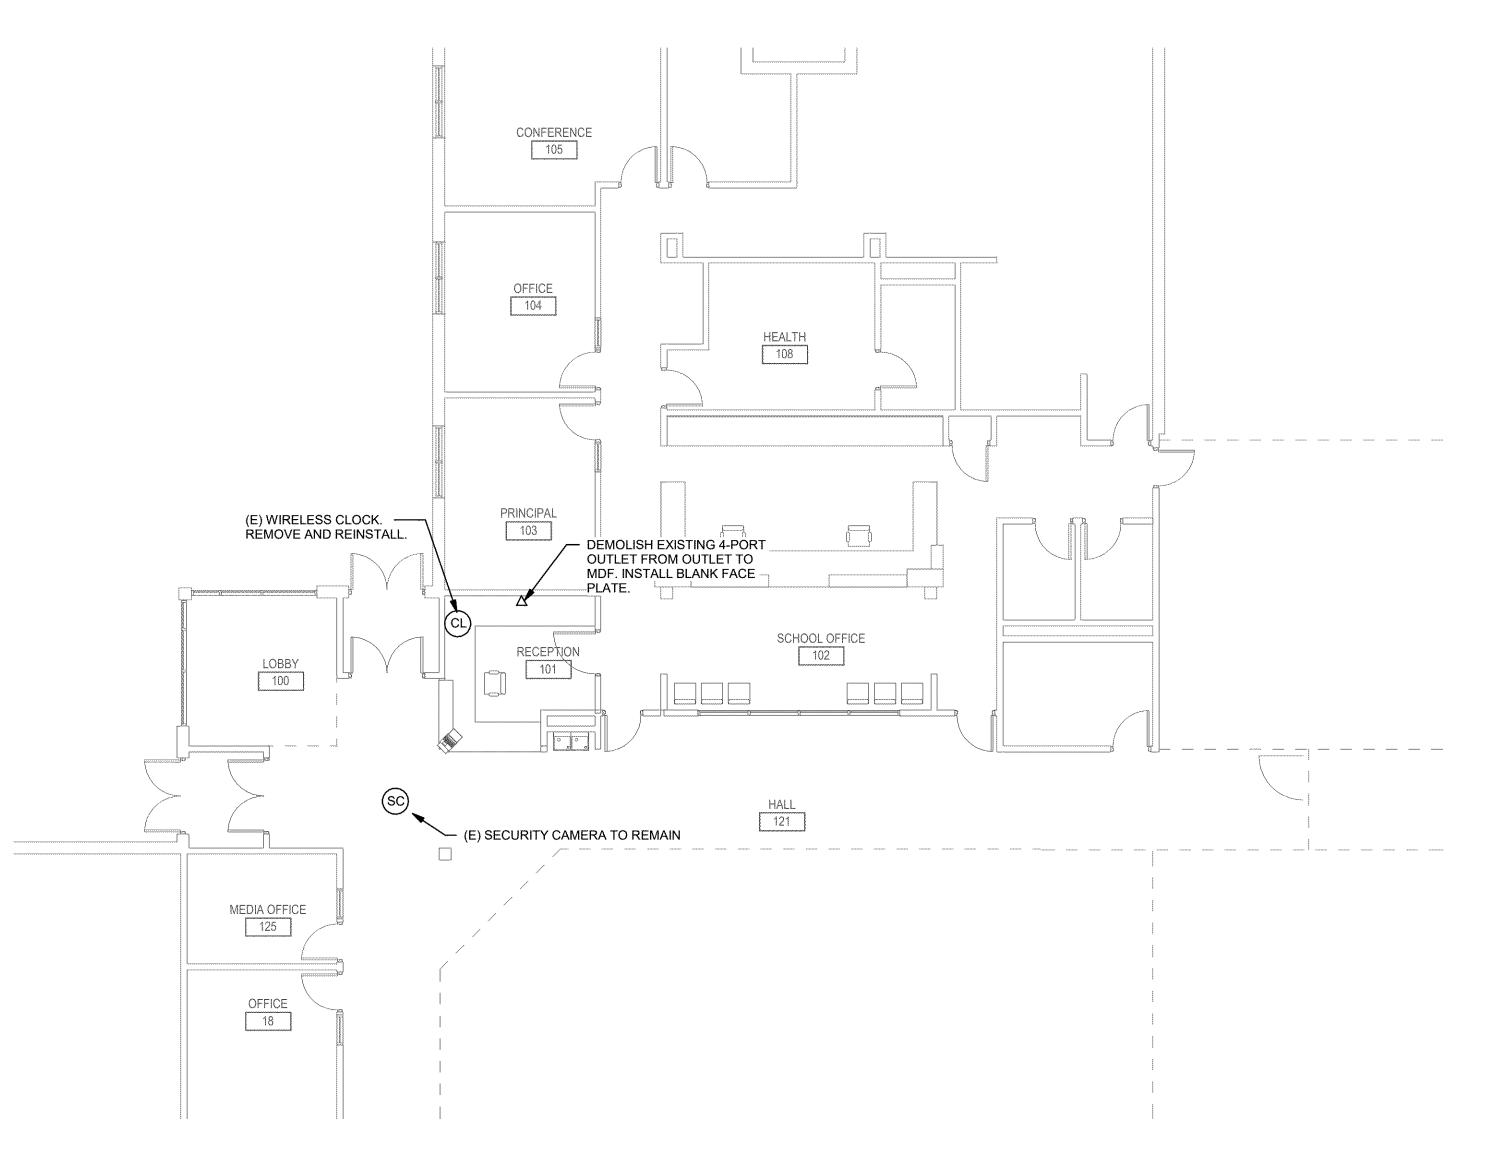
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 Approver

SHEET TITLE
OVERALL FIRST FLOOR PLAN TECHNOLOGY

SHEET NUMBER
T1101

LEVEL 01 PLAN - TECHNOLOGY

1/16" = 1'-0"



## FLOOR PLAN - DEMOLITION - TECHNOLOGY

0' 4' 8' 16' 1/8" = 1'-0" CONFERENCE 105 OFFICE 104 LOBBY

2 FLOOR PLAN - NEW - TECHNOLOGY 0' 4' 8' 16' 1/8" = 1'-0"

**○ SHEET KEYNOTES** 

REINSTALL WIRELESS CLOCK.

2. INSTALL WITHIN CABINETRY.

2"C. FROM ACCESSIBLE CEILING SPACE IN HALLWAY TO AVOID SPACE IN CABINETRY.

DOOR CONTROL BUTTON LOCATION. COORDINATE WITH ARCHITECTURAL DRAWINGS AND STANLEY INSTALLATION CONTRACTOR.

FLOOR MOUNTED MAGNETIC HOLD OPEN. COORDINATE WITH DOOR HARDWWARE SCHEDULE FOR BACKBOX TYPE.

CLIENT **WEST LINN** WILSONVILLE SCHOOL DISTRICT

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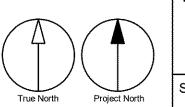
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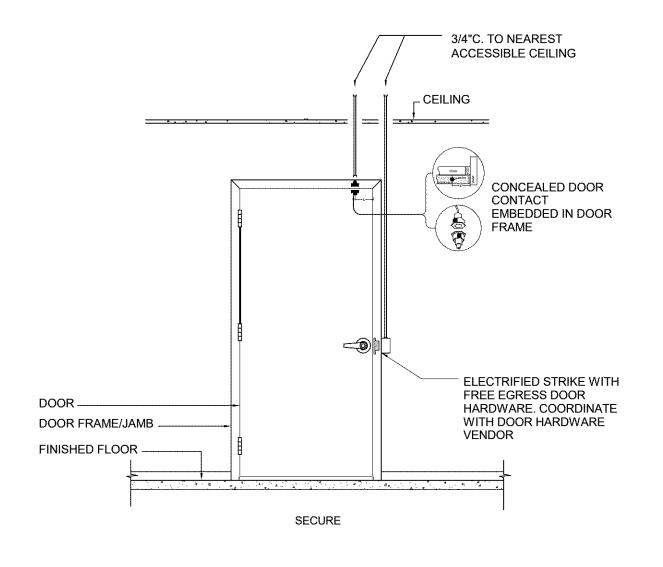
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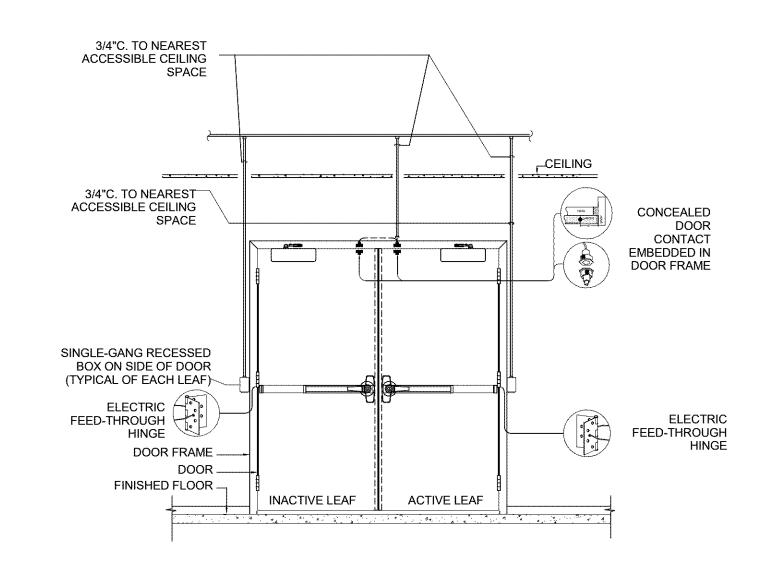
SHEET TITLE
ENTRY PLANS - TECHNOLOGY



SHEET NUMBER T1501



2 SINGLE DOOR PATHWAY DETAIL
NO SCALE



## 1 DOUBLE DOOR PATHWAY DETAIL NO SCALE

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SHEET TITLE
DETAILS - TECHNOLOGY

SHEET NUMBER T1601

00.00.000 DM

## TECHNOLOGY SYMBOL LIST

#### **ABBREVIATIONS SECURITY** 3/4"C. FROM DOOR CONTROL BUTTON (BY OTHERS) TO ACCESSIBLE CEILING SPACE. PATHWAY ONLY. DEMOLISH SINGLE GANG BACKBOX WITH 3/4"C. FROM ABOVE FINISHED FLOOR AUDIO SENSOR (BY SONITROL) TO NEAREST ACCESSIBLE CEÌLING SPACE. PATHWAY ONLY. BACKBOX TO BE MOUNTED HORIZONTALLY. CABLE TELEVISION 3/4"C. FROM POWER TRANSFER HINGE (BY CONTRACTOR FURNISHED CONTRACTOR INSTALLED OTHERS) TO NEAREST ACCESSIBLE CEILING SPACE. PATHWAY ONLY. REFER TO DETAIL CONTRACTOR FURNISHED OWNER INSTALLED 1/T1601. INTERMEDIATE DISTRIBUTION FRAME 3/4"C. FROM ELECTRIC STRIKE (BY OTHERS) TO NEAREST ACCESSIBLE CEILING SPACE. MAIN DISTRIBUTION FRAME PATHWAY ONLY. REFER TO DETAIL 2/T1601. NOT TO SCALE 3/4"C. FROM DOOR CONTACT (BY OTHERS) TO OWNER FURNISHED, CONTRACTOR INSTALLED NEAREST ACCESSIBLE CEILING SPACE. PATHWAY ONLY. REFER TO DETAILS 1/T1601 OWNER FURNISHED, OWNER INSTALLED AND 2/T1601. SINGLE GANG BACKBOX WITH 3/4"C. FROM TELECOMMUNICATIONS GROUNDING BUS BAR MAG HOLD (BY OTHERS) TO NEAREST ACCESSIBLE CEILING SPACE. UNLESS OTHERWISE NOTED **EQUIPMENT ROOMS** UNINTERRUPTABLE POWER SUPPLY 2-POST EQUIPMENT RACK WIRELESS ACCESS POINT WEATHERPROOF 4-POST EQUIPMENT RACK DOUBLE-SIDED VERTICAL WIRE MANAGEMENT **ENCLOSED CABINET GENERAL** —X—X— DEMOLISH ----- CONTINUATION DETAIL NUMBER AND SHEET LOCATION KEYED NOTE SECTION NUMBER AND SHEET LOCATION

RACEWA	RACEWAYS		
XIIIIX	COMMUNICATIONS CABLE RUNWAY		
	CONDUIT ABOVE GRADE		
	CONDUIT BELOW GRADE OR SLAB		
	CONDUIT DOWN		
	CONDUIT SLEEVE		
	CONDUIT UP		
	CONDUIT/WIRING CONTINUATION		
I   <del> </del>	GROUNDING POINT		
НН	HANDHOLE		
VT	COMMUNICATIONS VAULT		
	COMMUNICATIONS BACKBOARD		
	WIRE BASKET CABLE TRAY		
COMMU	<u>NICATIONS</u>		
$\nabla$	STANDARD COMMUNICATIONS OUTLET WITH (3) CAT6A CABLE(S) TO NEAREST MDF/IDF AND 1"C. TO ACCESSIBLE CEILING SPACE.		

### **GENERAL SHEET NOTES**

- A. COMMUNICATIONS RACEWAYS, TRAYS, AND OUTLETS ARE SHOWN DIAGRAMMATICALLY, LOCATIONS ARE APPROXIMATE UNLESS SPECIFICALLY DIMENSIONED. FIELD COORDINATE ALL WORK WITH OTHER TRADES.
- B. CONSTRUCTION DETAILS SHOW TYPICAL INSTALLATION, UON, AND APPLY TO ALL COMMUNICATIONS WORK INCLUDED IN THE SUMMARY OF WORK FOR THIS PACKAGE EVEN THOUGH NOT SPECIFICALLY REFERENCED ON THE PLAN
- . INSTALL PULL STRINGS IN ALL CONDUITS AT THE TIME OF CONDUIT AND CABLE INSTALLATION.

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**SHEET INDEX** 

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T1601 DETAILS - TECHNOLOGY

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APPROVED BY: PROJECT MGR: SHEET TITLE SYMBOL LIST AND GENERAL NOTES - TECHNOLOGY

SHEET NUMBER

TG0000