# GENERAL PLAN NOTES:

- 1. DIMENSIONS SHOWN ARE TO FACE OF STUD, FACE OF MASONRY OR
- 2. DOORS NOT LOCATED BY DIMENSION ARE TO BE CENTERED IN WALLS AS SHOWN OR LOCATED 4 1/2" FROM FACE OF STUD TO FACE OF JAMB.
- 3. NOTED WALL TYPE DEPICTS TYPICAL WALL CONSTRUCTION. SEE ELEVATIONS, SECTIONS, AND DETAILS FOR ADDITIONAL INFORMATION.
- 4. DIMENSIONS AT GLAZING ASSEMBLIES ARE TO CENTER OF ASSEMBLY
- 5. USE DIMENSIONS SHOWN; IN NO CASE SHALL WORKING DIMENSIONS BE SCALED FROM DRAWINGS, CROSS CHECK DETAILS AND DIMENSIONS SHOWN ON THE ARCHITECTURAL DRAWINGS WITH RELATED REQUIREMENTS ON THE STRUCTURAL, MECHANICAL, ELECTRICAL, PLUMBING, AND OTHER DRAWINGS AS APPLICABLE. NOTIFY ARCHITECT OF ANY DISCREPANCIES BEFORE PROCEEDING WITH THE WORK.
- 6. CONDITIONS AND DETAILS MARKED "TYPICAL" SHALL APPLY IN ALL CASES UNLESS SPECIFICALLY INDICATED OTHERWISE. TYPICAL DETAILS NOT REFERENCED ON DRAWINGS APPLY UNLESS NOTED OTHERWISE BY SPECIFIC NOTES AND DETAILS. WHERE NO SPECIFIC DETAIL IS SHOWN, THE CONSTRUCTION SHALL BE IDENTICAL OR SIMILAR TO THAT INDICATED FOR THE TYPICAL CONSTRUCTION OF THE PROJECT
- . WHERE NO SPECIFIC STANDARDS ARE APPLIED TO A MATERIAL OR METHOD OF CONSTRUCTION TO BE USED ON THE WORK, ALL SUCH MATERIAL AND METHODS ARE TO MAINTAIN STANDARDS OF THE
- 8. LOADING OF CONSTRUCTION MATERIALS SHALL NOT EXCEED THE DESIGN LIVE LOAD PER SQUARE FOOT.
- ARCHITECTURAL, MECHANICAL, ELECTRICAL, AND PLUMBING WITH APPROPRIATE TRADES, DRAWINGS, AND SUBCONTRACTORS PRIOR TO CONSTRUCTION.
- 10. PROVIDE ALL NECESSARY ANCHORAGE BLOCKING, BACKING, FRAMING FOR HANDRAILS, DOOR STOPS, CASEWORK, SHELVING, MIRRORS, WALL MOUNTED EQUIPMENT, AND ALL OTHER ITEMS AS REQUIRED FOR COMPLETE INSTALLATION.

# **GENERAL DEMO NOTES:**


- A. DEMOLITION DRAWINGS ARE DIAGRAMMATIC AND ARE TO ASSIST THE CONTRACTOR IN ESTABLISHING THE GENERAL SCOPE OF WORK. PROVIDE NEW CONSTRUCTION DRAWINGS AND AS SPECIFIED.
- B. NOTATIONS FOR SAW CUTTING CONCRETE SLABS ARE APPROXIMATE -VERIFY WITH STRUCTURAL MECHANICAL AND PLUMBING DRAWINGS AND WITH FIELD CONDITIONS. PATCH AND POUR BACK ANY SAW CUT CONCRETE FOR TRENCHES OR ANY HOLES FROM DEMOLISHED WALLS, CONDUIT OR PLUMBING WITH NEW CONCRETE TO MATCH EXISTING. SEE STRUCTURAL FOR POUR BACK DETAIL INFORMATION.
- C. SEE MECHANICAL, PLUMBING, ELECTRICAL AND TECHNOLOGY DRAWINGS FOR ADDITIONAL DEMOLITION INFORMATION.
- D. WHERE DEMOLITION OR REMOVAL OF AN ITEM OCCURS, PATCH REMAINING WALLS, FLOORS AND CEILING TO MATCH EXISTING ADJACENT MATERIAL, COLOR AND FINISH, UNLESS OTHERWISE NOTED.
- REMOVE MATERIALS TO BE REINSTALLED OR RETAINED IN A MANNER TO PREVENT DAMAGE, STORE AND PROTECT.
- F. PRIOR TO SAWCUTTING ANY EXISTING CONCRETE FLOOR SLAB, PROVIDE FIELD ENGINEERING AND UTILITIES LOCATION SERVICES TO LOCATE ANY EXISTING ELECTRICAL, TELEPHONE, WATER, SANITARY SEWER OR STORM DRAIN LINES WITHIN THE AREA OF WORK.
- G. THE TERM "DEMO" INDICATES THAT THE ITEM BECOMES THE PROPERTY OF THE GENERAL CONTRACTOR FOR DISPOSAL.
- H. FOR ITEMS IN WORK AREAS NOT DESIGNATED EITHER "TO REMAIN" OR "BE
- CONTRACTOR TO REMOVE ANY EXISTING DUCTS, PIPES, DEVICES THAT HAVE BEEN ABANDONED OR ARE NOT PART OF THE NEW BUILDING SYSTEM. PATCH AND REPAIR SURFACES TO MATCH ADJACENT SURFACES, TYPICAL.
- K. PANELS, SWITCHES, DEVICES IN WALLS TO BE DEMOLISHED ARE TO BE REMOVED PRIOR TO WALL REMOVAL. COORDINATE WITH ELECTRICAL DRAWINGS FOR ADDITIONAL INFORMATION.
- WHERE CEILING IS NOTED TO BE DEMOLISHED, REMOVE LIGHT FIXTURES. SEE ELECTRICAL DRAWINGS FOR ADDITIONAL INFORMATION.


- HAVE BEEN REMOVED, REPAIR SERVICES TO ORIGINAL CONDITION.
- KITCHEN AREAS AND BEHIND DRINKING FOUNTAINS.


- DOOR, LOCATE TRANSITION UNDER CENTERLINE OF DOOR.

RECEIVED SCHEDULED FLOORING.

- AND PAINTED P-1, UNLESS NOTED OTHERWISE.

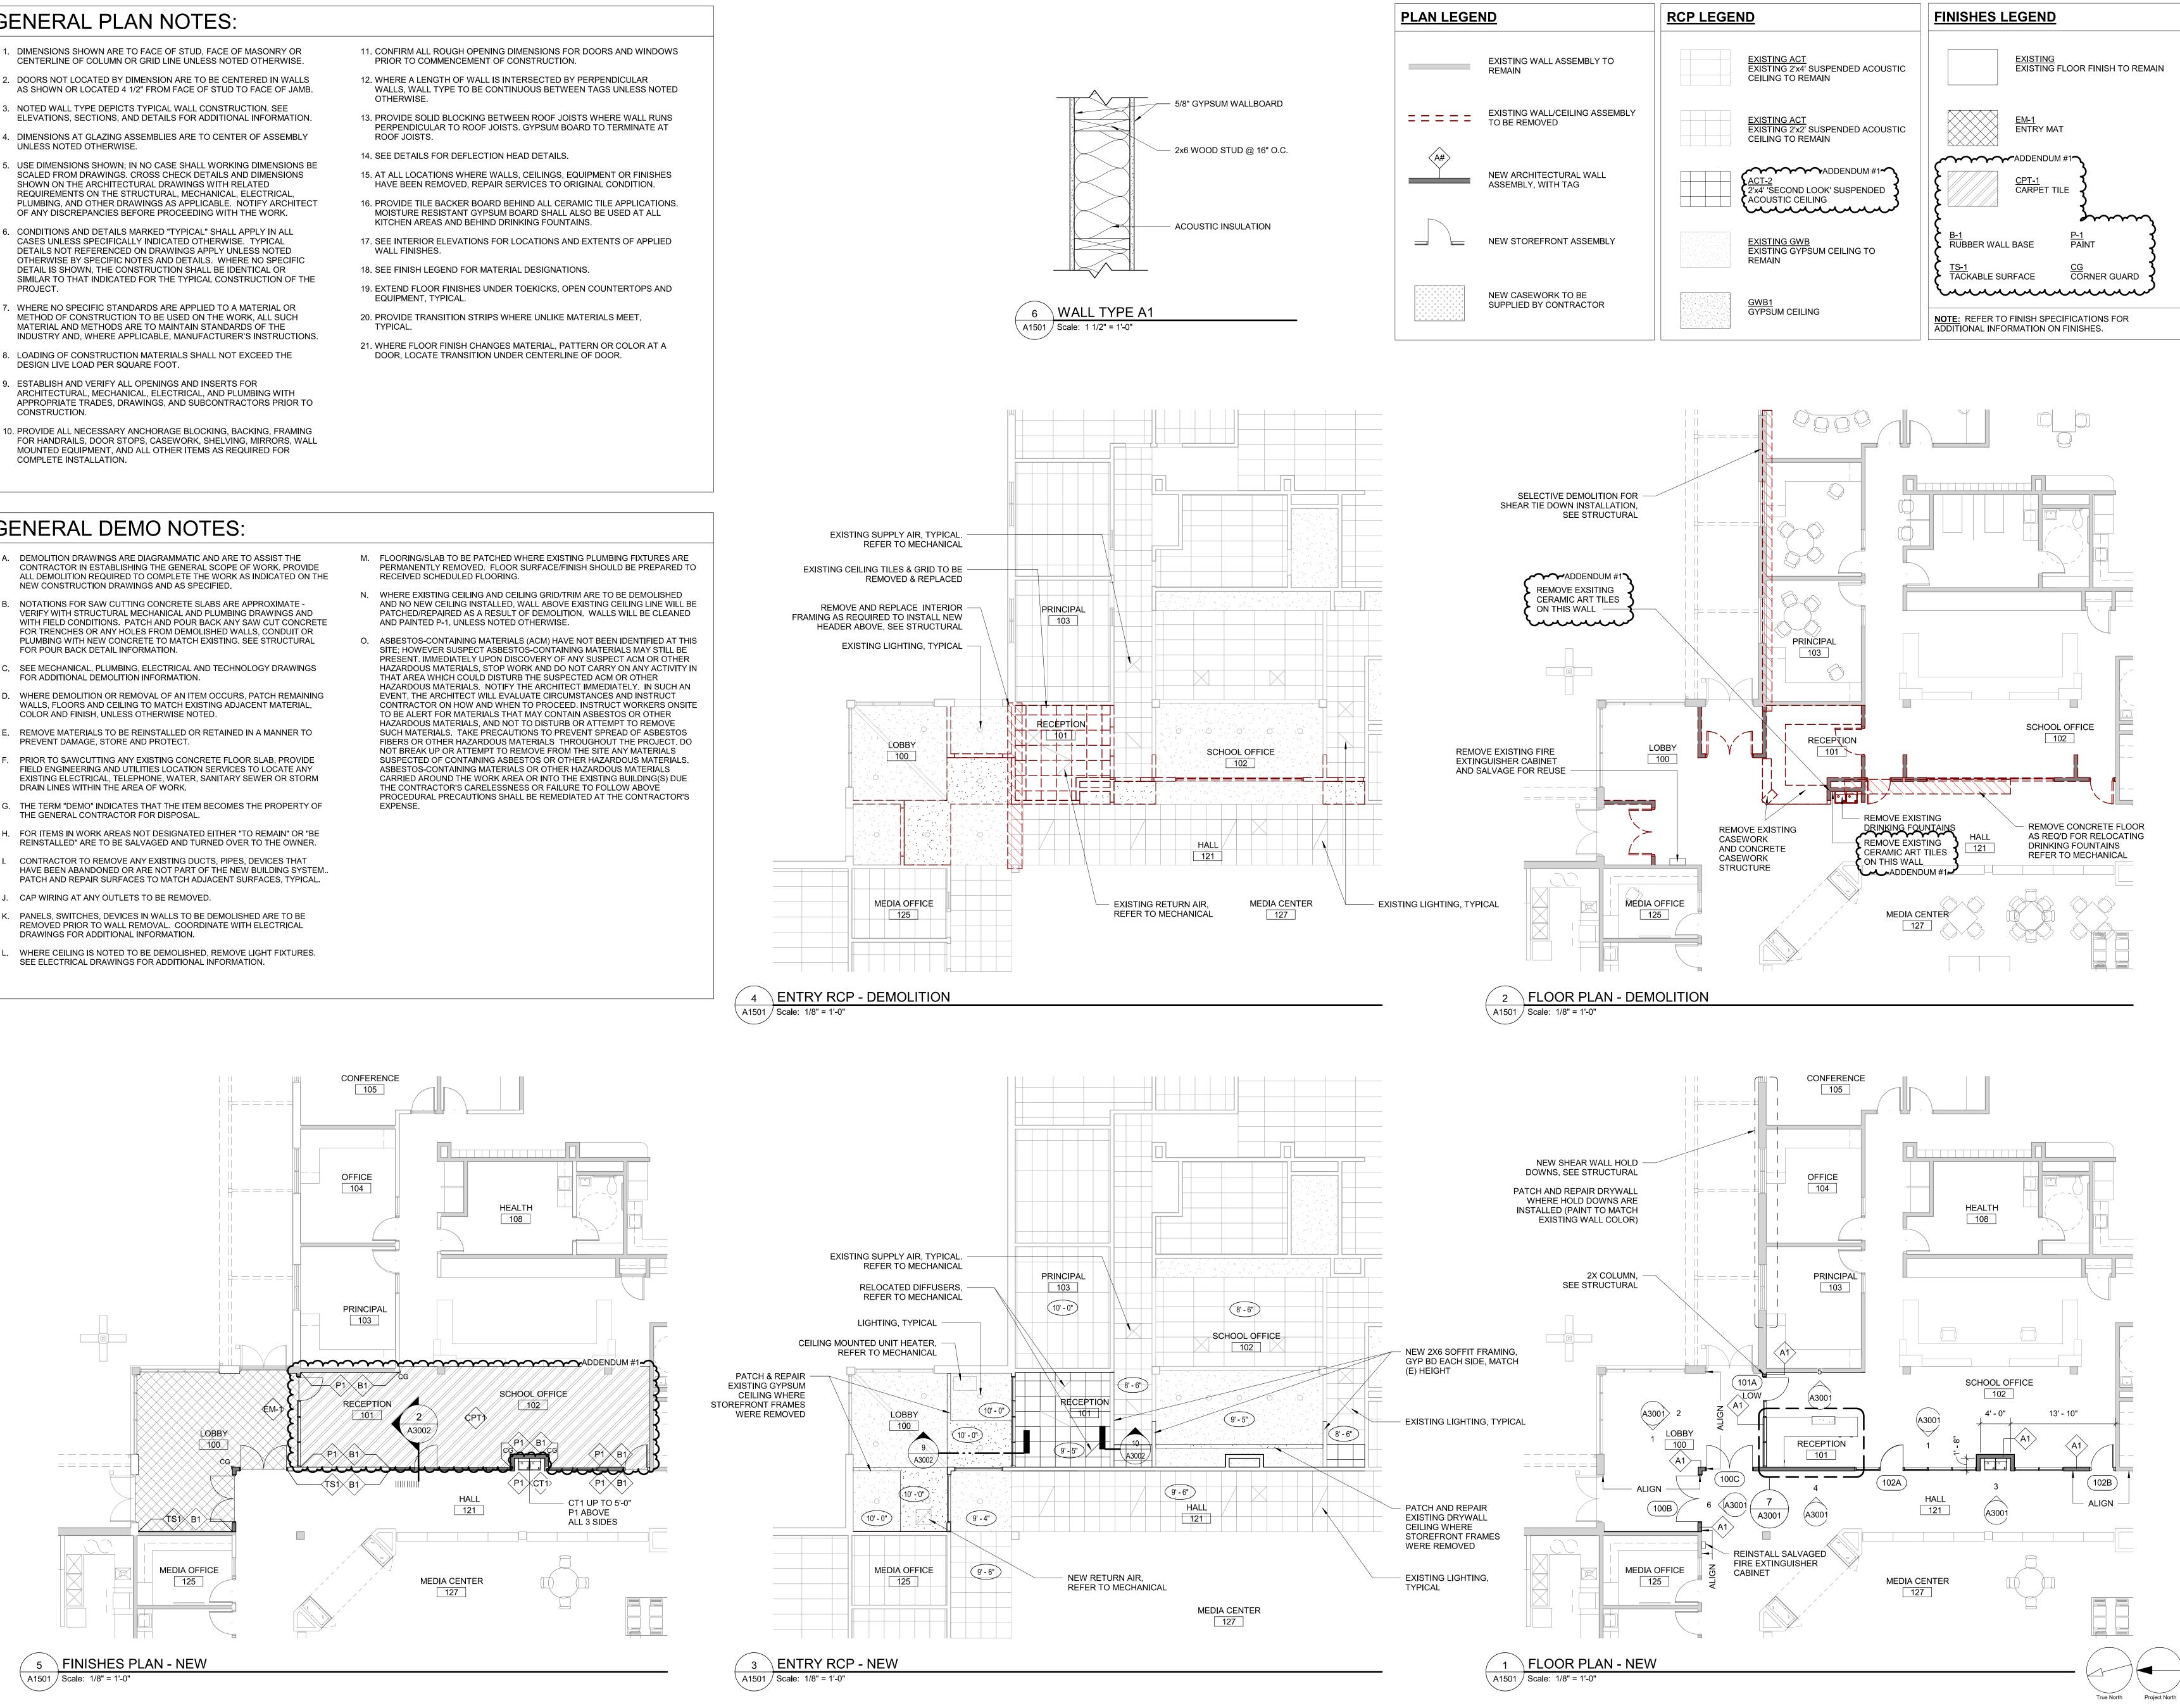

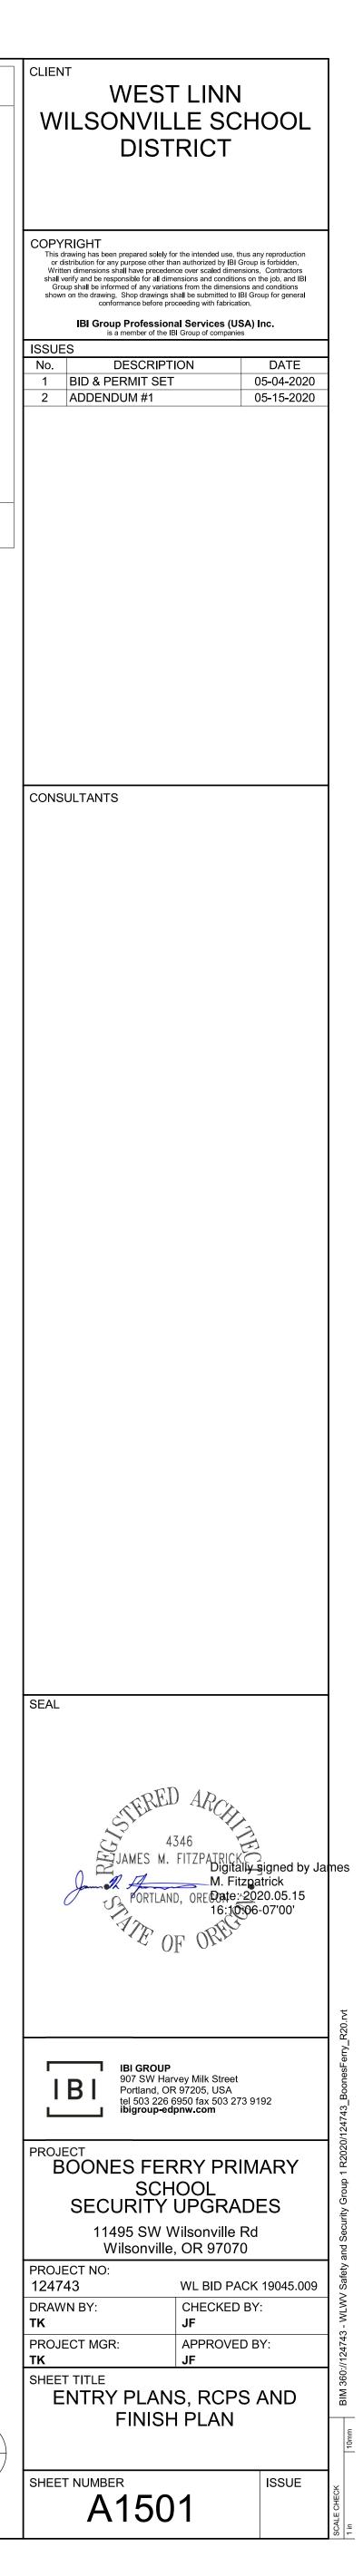


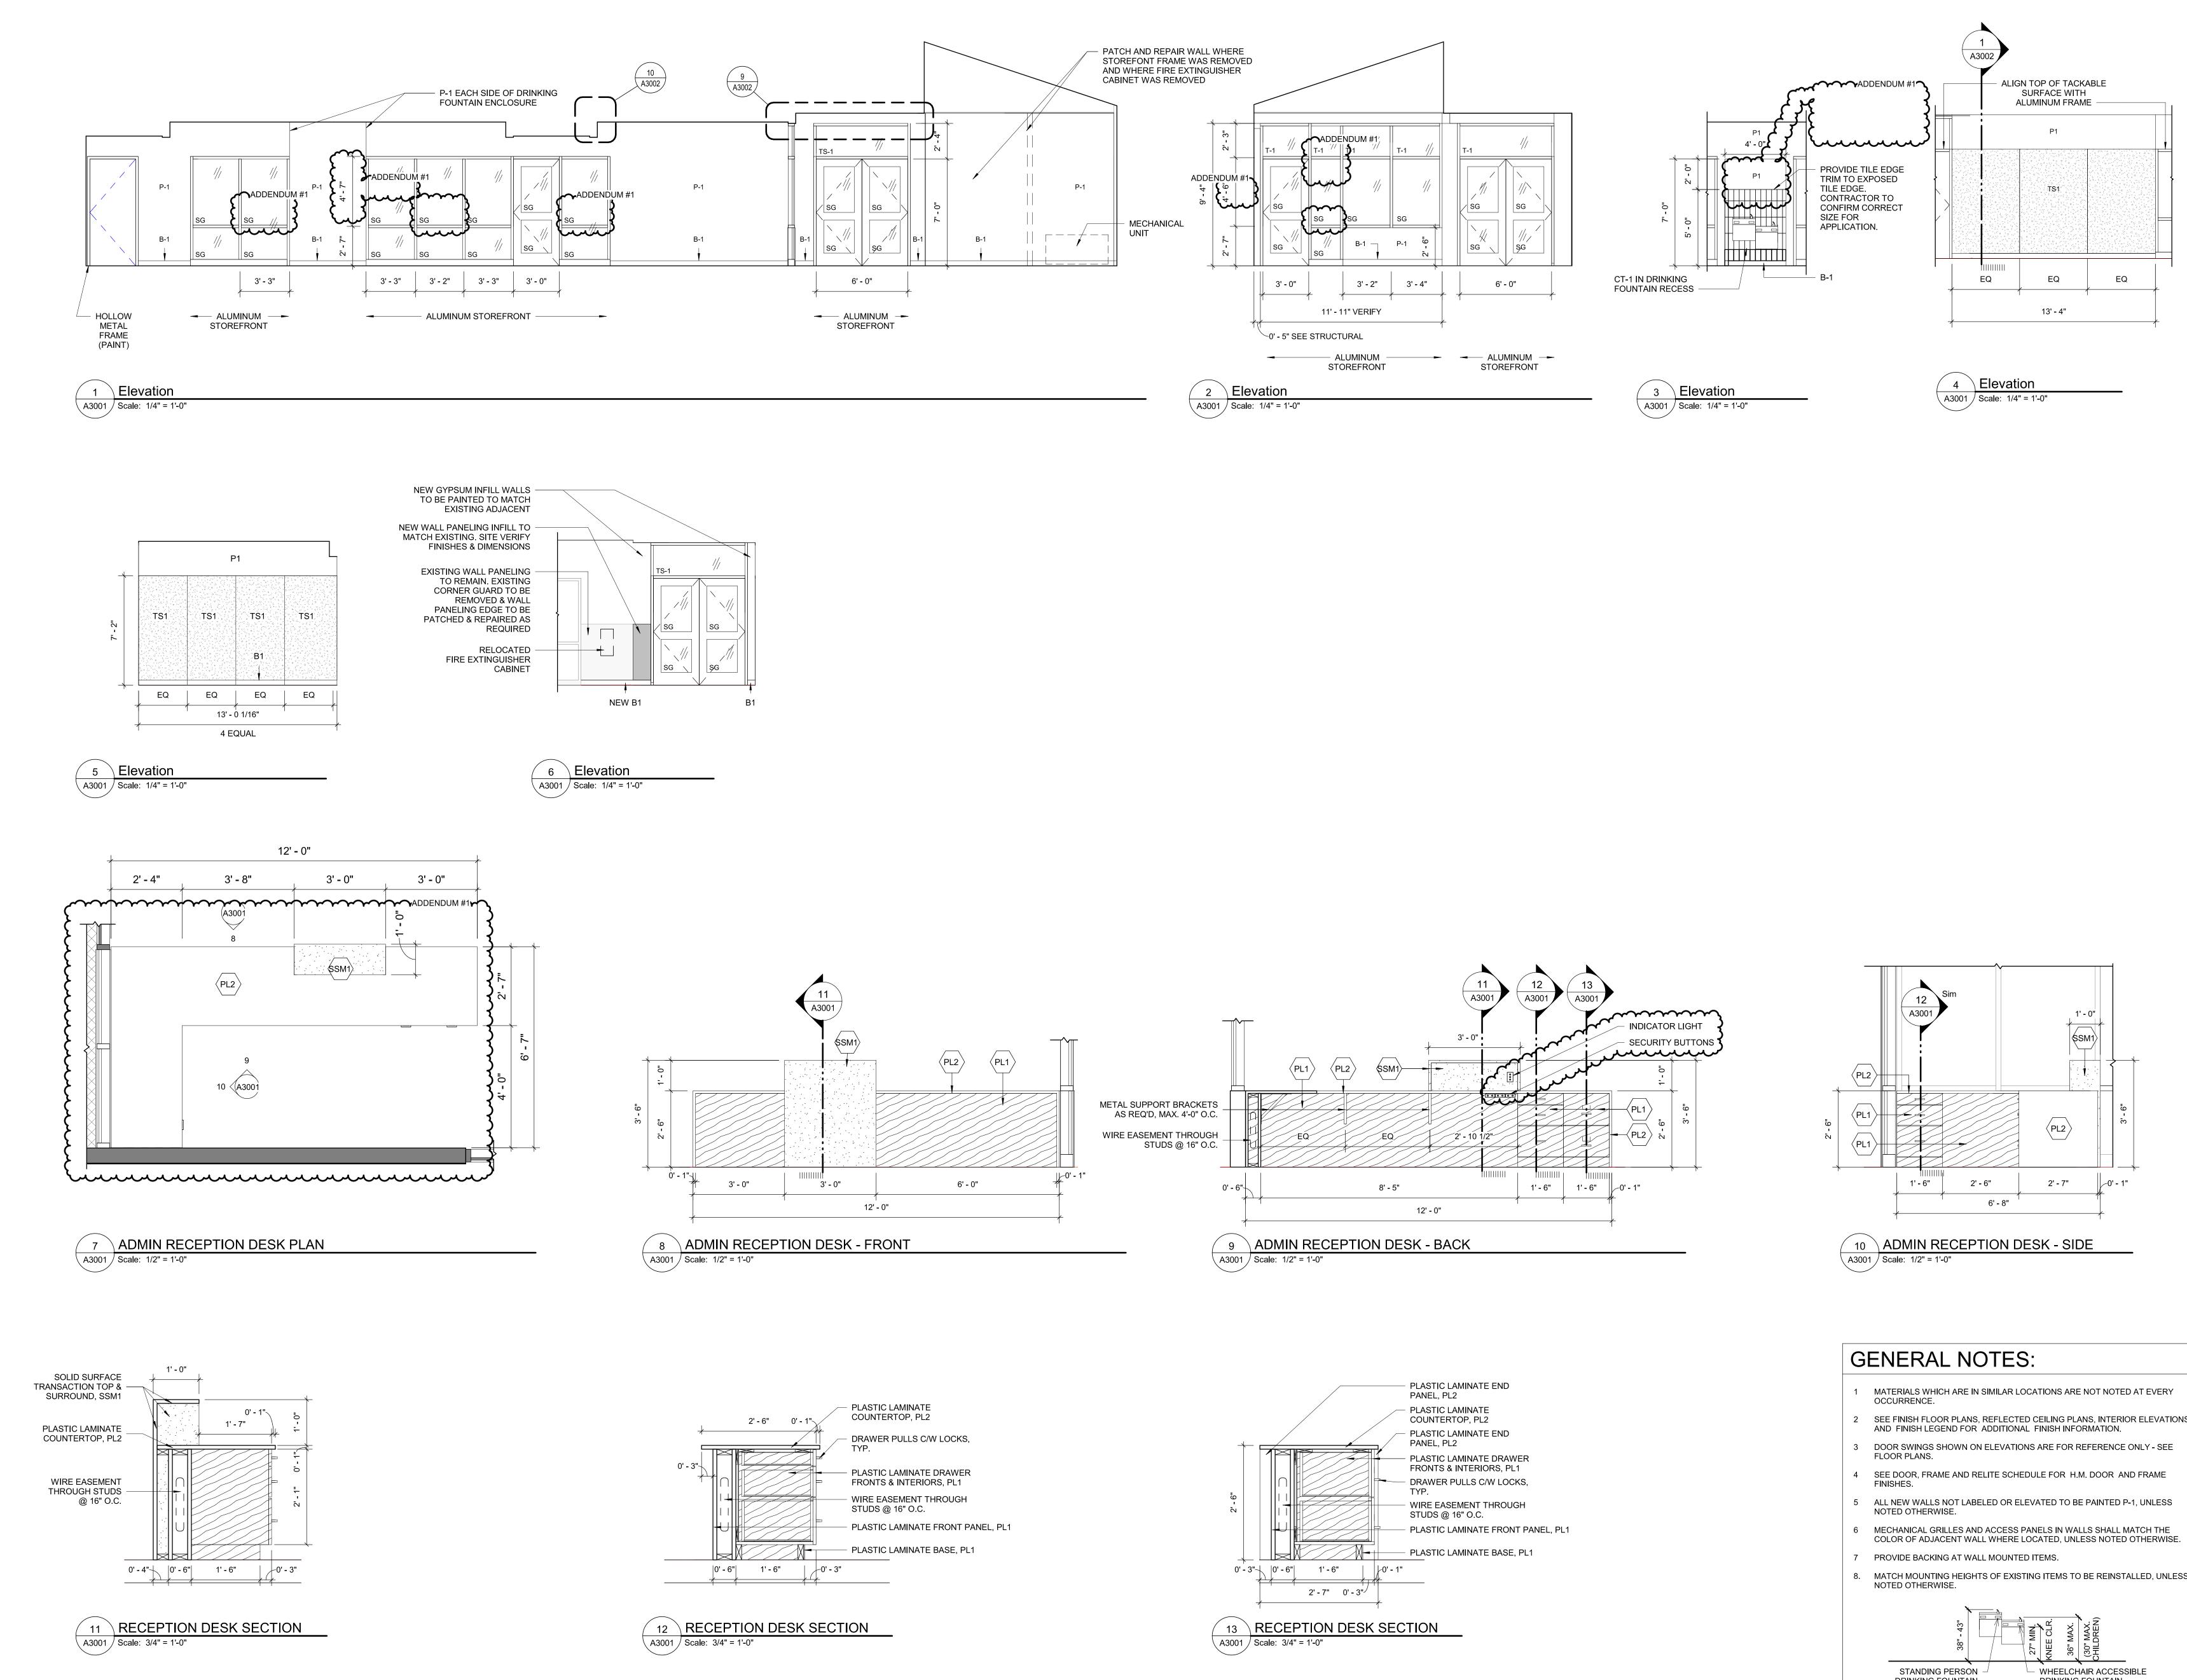

- SEE FINISH FLOOR PLANS, REFLECTED CEILING PLANS, INTERIOR ELEVATIONS

- 8. MATCH MOUNTING HEIGHTS OF EXISTING ITEMS TO BE REINSTALLED, UNLESS NOTED OTHERWISE.

DRINKING FOUNTAIN DRINKING FOUNTAIN

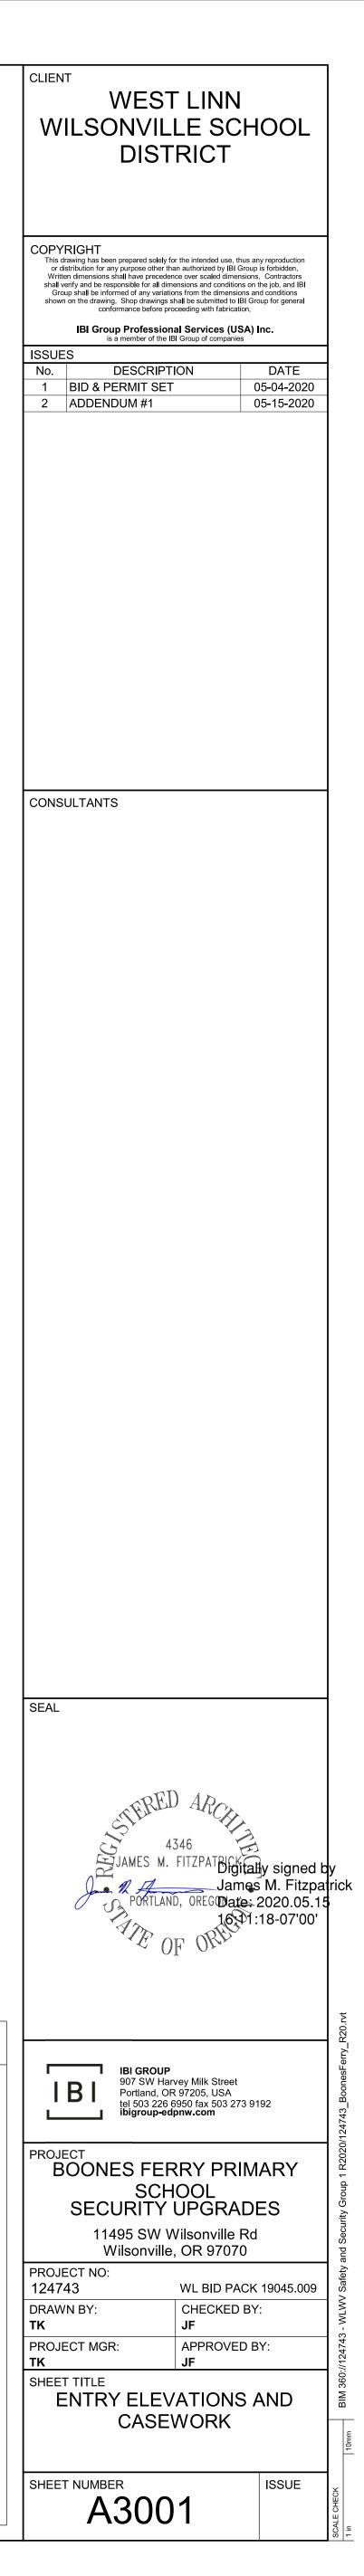

EXISTING DOOR SCHEDULE

	Door	Frame	Fire Rating		
No.	Туре	Туре	(minutes)	Hardware	

120A (E) (E) (E) 01 1 130A (E) 01 (E) (E) 132A (E) 02 1.,2. (E) (E) 133A (E) (E) (E) 01 1. 138A (E) 01 1. (E) (E) 301A (E) (E) (E) 01 1. 302A (E) 01 1. (E) (E) 303A (E) (E) (E) 01 1 304A (E) 01 1. (E) (E) 401A (E) (E) (E) 01 1. 402A (E) 01 1. (E) (E) 403A (E) (E) (E) 01 1. 404A (E) (E) (E) 01 501A (E) 01 1. (E) (E) 502A (E) 01 1. (E) (E) 503A (E) (E) (E) 01 1. 504A (E) (E) (E) 01 1. 601A (E) 01 1. (E) (E) 602A (E) (E) (E) 01 1. 603A (E) 01 1. (E) (E) 604A (E) (E) (E) 01 1. 801A (E) (E) (E) 01 1. 802A (E) (E) (E) 01 1. 803A (E) (E) (E) 01 1 804A (E) 01 1. (E) (E) 901A (E) (E) (E) 01 1. 902A (E) (E) (E) 01 1. 903A (E) 01 1. (E) (E) 904A (E) 01 1. (E) (E) 1001A (E) (E) (E) 01 1. 1002A (E) (E) (E) 01 1. 1003A (E) (E) (E) 01 1. 1004A (E) 01 | 1. (E) (E) 1101A (E) (E) (E) 01 1. 1102A (E) (E) (E) 01 1 1103A (E) (E) (E) 01 1 1104A (E) 01 1. (E) (E)

NOTES:

1. EXISTING DOOR AND FRAME TO REMAIN "AS IS" EXCEPT FOR NEW HARDWARE. SIZE SHOWN FOR FOR CLARITY ONLY. 2. NOT USED

SEQ	JENCING OF ADA B	UTTONS AND DOORS
#	LOCATION	DOORS
1	EXTERIOR	A100A, A101A and A100C
2	LOBBY	A100A, A101A and A100C
3	RECEPTION	A100A, A101A and A100C
4	LOBBY/HALLWAY	A100A, A101A and A100C


SECURITY BUTTON A	RELEASE OF 100C
SECURITY BUTTON B	RELEASE OF 101A, 102A
SECURITY BUTTON c	RELEASE OF 116A, 132A

1 SECURITY KEY A9201 Scale: 1/8" = 1'-0"

Comments	


/ #1 <b></b>	
	_
	_
	_
	-
	-
	-
	_
	_
	_
	-
	-
	-
	_
	_
	_
	-
	-
	-
	-

									NE	W DOOR SCHEE	DULE				
				C	Door						Frame		Fire Rating		
No.	Location	Width	Pair	Height	Thickness	Туре	Material F	ïnish l	Relite	Туре	Material	Finish	(minutes)	Hardware	Comments
LEVEL 100B		6' - 0"	YES	7' - 0"		С	AL		Y	STOREFRONT	AL		NA	03	
									Y V						
100C	LOBBY	6' - 0"	YES	7' - 0"		C	AL		Y	STOREFRONT			NA	04	ADA OPENER, ONE LEAF
101A	RECEPTION	3' - 0"	NO	7' - 0"		С	AL		Y	STOREFRONT	AL		NA	05	ADA OPENER
102A	RECEPTION	3' - 0"	NO	7' - 0"		С	AL		Y	STOREFRONT	AL		NA	06	2.
102B	RECEPTION	3' - 0"	NO	7' - 0"	0' - 2"	(E)	(E)	(E)	Ν	(E)	НМ	P-2	NA	06	REINSTALL (E) DOOR WITH NEW HARDWARE

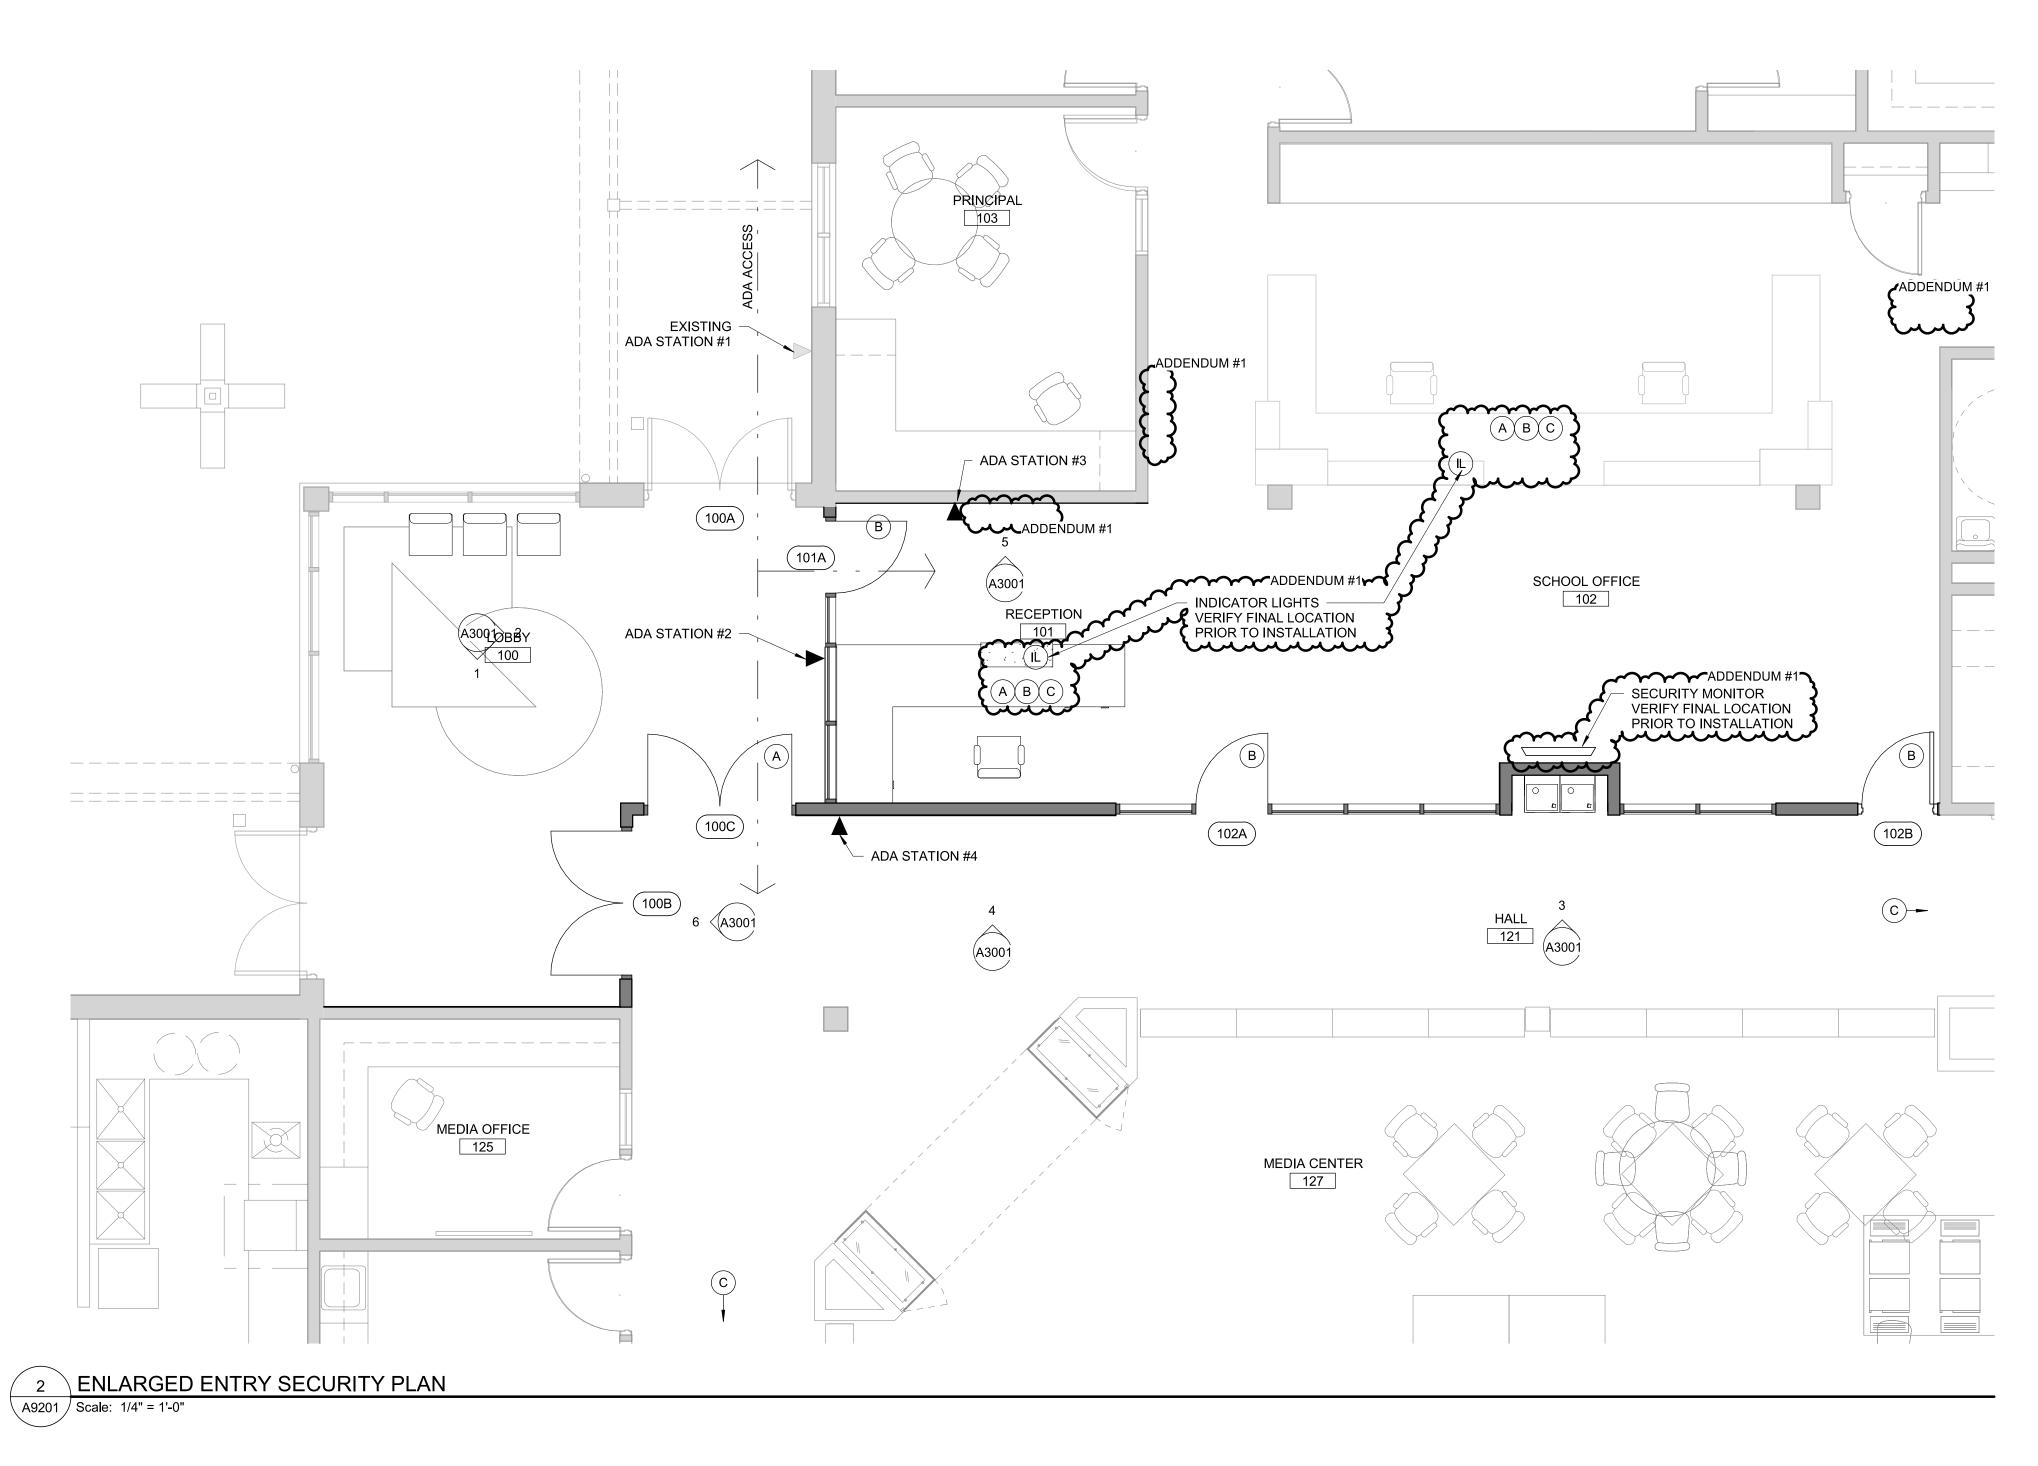

# NOTES:

- 1. ALL SECURITY GLAZING TO EXTEND 7' A.F.G.
- 2. ALL STOREFRONT FRAME COLOR AND FINISH TO MATCH EXISTING
- 3. VERIFY IN FIELD ALL ROUGH OPENINGS.

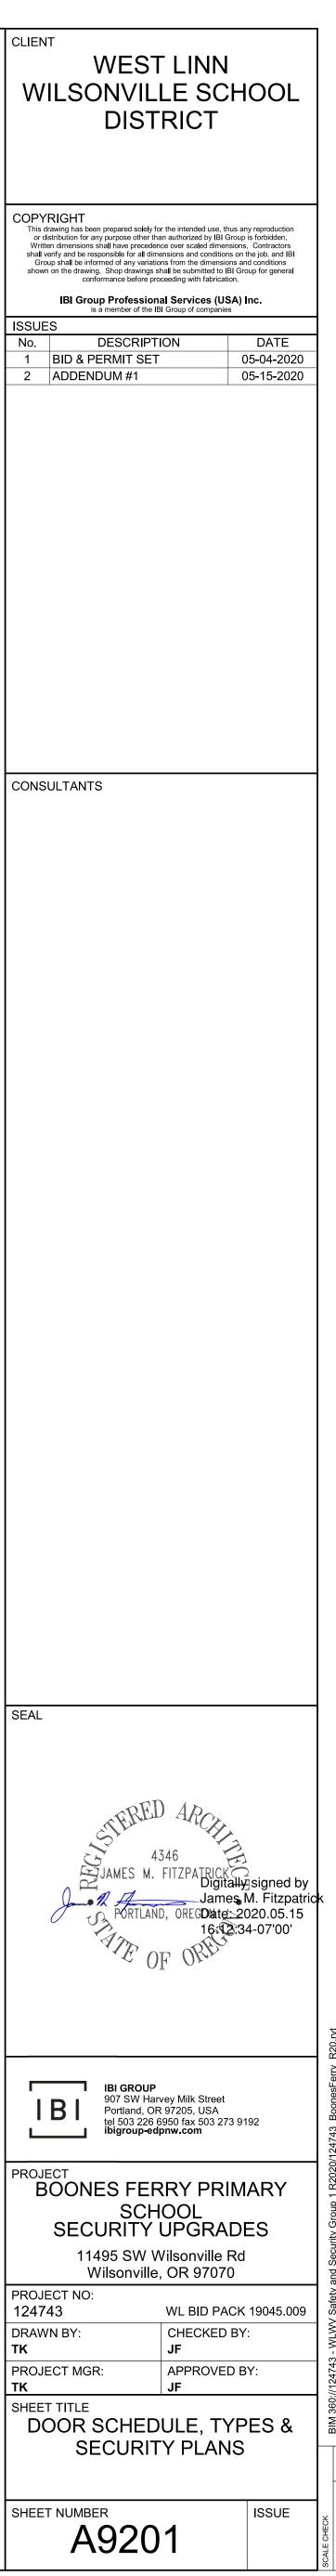

EXISTING DOOR SCHEDULE							
	Door	Frame	Fire Rating				
No.	Туре	Туре	(minutes)	Hardware	REMARKS		
					1104.444		
			<u> </u>				
A133A	(E)	(E)	- 8	01 1	1.		
B101A	(E)	(E)	- }	02	1.		
B102A	(E)	(E)	}	02	1.		
B103A	(E)	(E)	}	02	1.		
B104A	(E)	(E)	}	02	1.		
B105A	(E)	(E)	{	02	1.		
B106A	(E)	(E)	Ç	02 1	1.		
B107A	(E)	(E)	<b>č</b>	02	1.		
B108A	(E)	(E)	}	02 🕇	1.		
B109A	(E)	(E)	}	02 1	1.		
B110A	(E)	(E)	<b>}</b>	02	1.		
B113A	(E)	(E)	}	02	1.		
B114A	(E)	(E)	{	02	1.		
B118A	(E)	(E)	(	02 + NEW	1. REPLACE WITH NEW		
	·		<u> </u>	1			
C101A	(E)	(E)	- <b>č</b>	02	1.		
C102A	(E)	(E)		02	1.		
C103A	(E)	(E)	}	02	1.		
C104A	(E)	(E)	}	02	1.		
C105A	(E)	(E)	<u>}</u>	02	1.		
LEVEL (	)2		{				
B201A	(E)	(E)	<b>Ş</b>	02	1.		
B202A	(E)	(E)	ζ	02	1.		
B203A	(E)	(E)	6	02 1	1.		
B204A	(E)	(E)	}	02 🕇	1.		
B205A	(E)	(E)	}	02	1.		
B206A	(E)	(E)	}	02	1.		
B207A	(E)	(E)	}	02	1.		
B208A	(E)	(E)	{	02	) 1.		
B209A	(E)	(E)	<b>Ş</b>	02	1.		
B210A	(E)	(E)	Č	02	1.		
B213A	(E)	(E)	8	02	1.		
B214A	(E)	(E)	}	02	1.		
	. /		<u> </u>	مسسر	)		

NOTES:

HARDWARE. SIZE SHOWN FOR FOR CLARITY ONLY.

1. EXISTING DOOR AND FRAME TO REMAIN "AS IS" EXCEPT FOR NEW


									NEW DOOI	R SCHEDULE				
					Door					Frame		Fire Rating		
No.	Location	Width	Pair	Height	Thickness	Туре	Material	Finish Relite	Туре	Material	Finish	(minutes)	Hardware	Comments
LEVEL 01												(	ADDENDUM #	¥1
A105A	RECEPTION	3' - 0"	N	7' - 0"	0' - 1 3/4"	Α	WD	YES	1	HM	P-3	NONE	03	ADA OPENER
A105B	RECEPTION	3' - 0"	N	7' - 0"	0' - 1 3/4"	Α	WD	YES	1	HM	P-3	NONE 👌	04	{
ATUJD														
	HALLWAY	6' - 0"	YES	7' - 0"	0' - 1 3/4"	A	WD	YES	1	HM	P-3	NONE 8	05	🕻 ADA OPENER, ONE LEAF

ADDENDUM #1 mm


ADA STATION #3 mm


SEQ	UENCING OF ADA BU	JTTONS AND DOORS
#	LOCATION	DOORS
1	EXTERIOR	ADDENDUM #1
2	NOT USED	
3	VESTIBULE	A101A, A101B and A105A
4	LOBBY/HALLWAY	A101A, A101B and A105A
5	HALL	A101A, A101B and A105A
		uuuu

EXISTING -ADA STATION #1

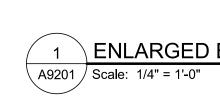


SECURITY BUTTONS - LOCATED AT RECEPTION SECURITY BUTTON A RELEASE OF A101B SECURITY BUTTON B RELEASE OF A105A, A105B

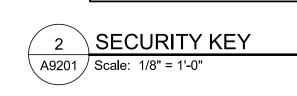


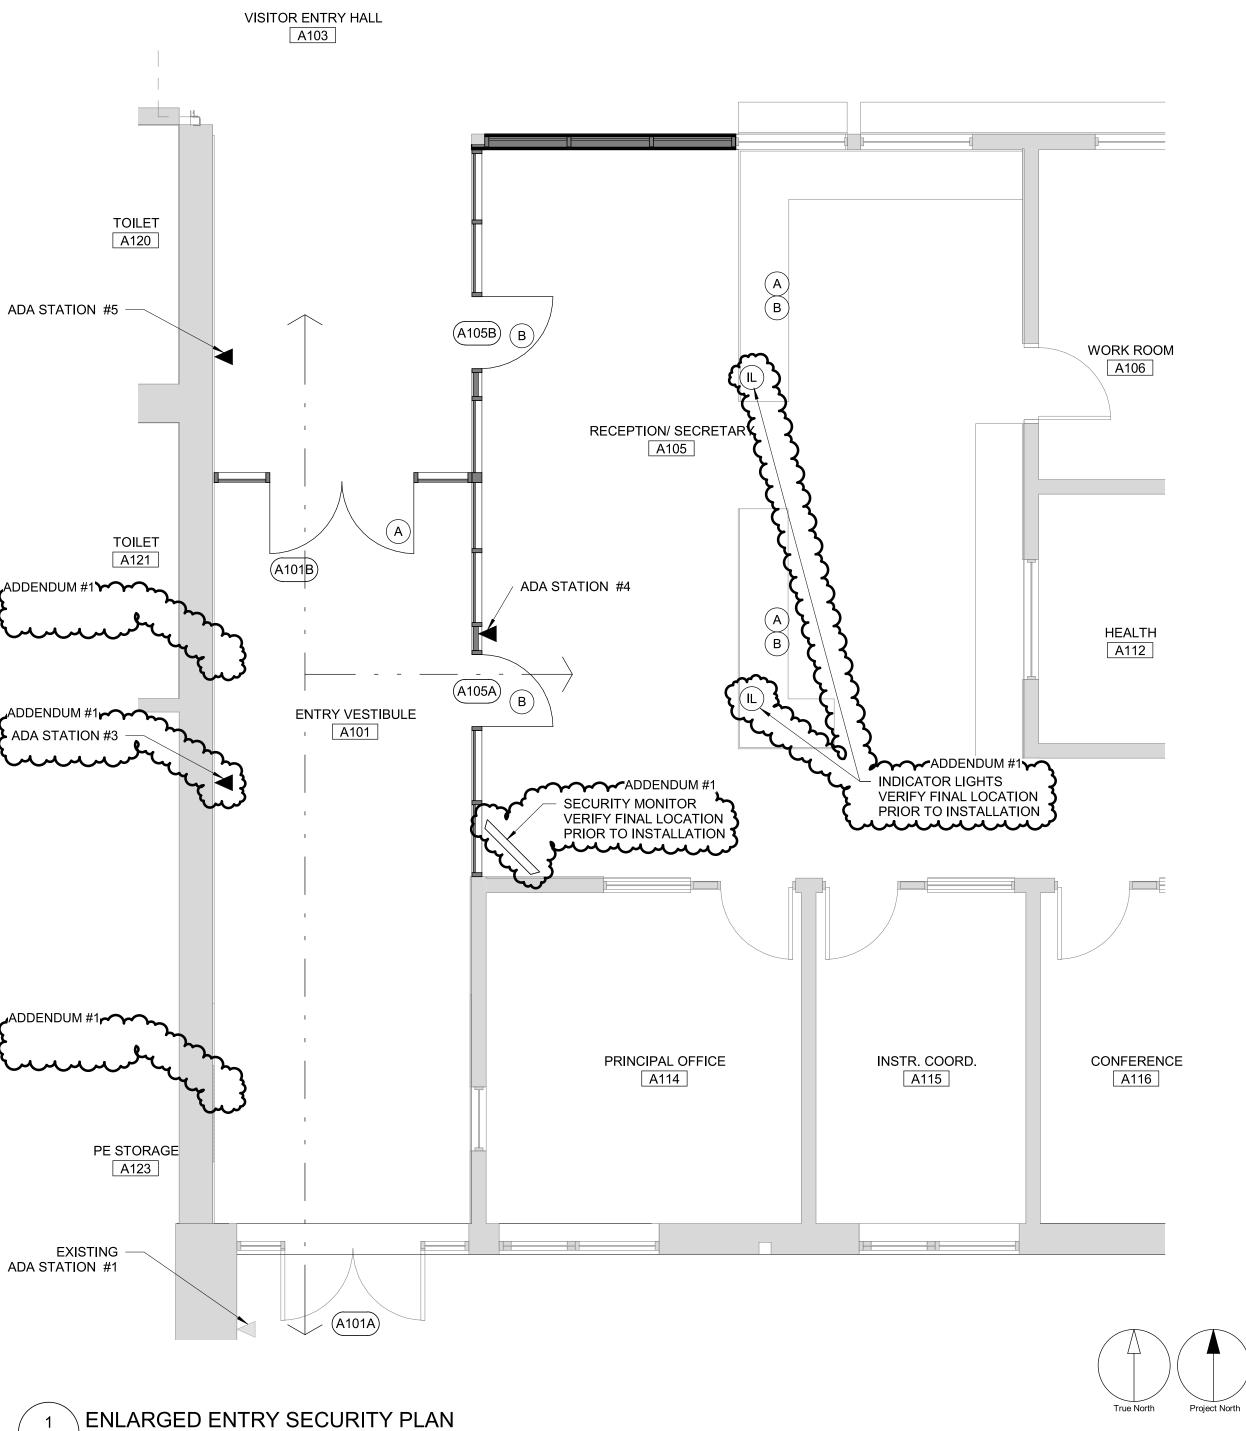



# NOTES:

- 1. ALL SECURITY GLAZING TO EXTEND 7' A.F.G.
- 2. ALL STOREFRONT FRAME COLOR AND FINISH TO MATCH EXISTING
- 3. VERIFY IN FIELD ALL ROUGH OPENINGS.

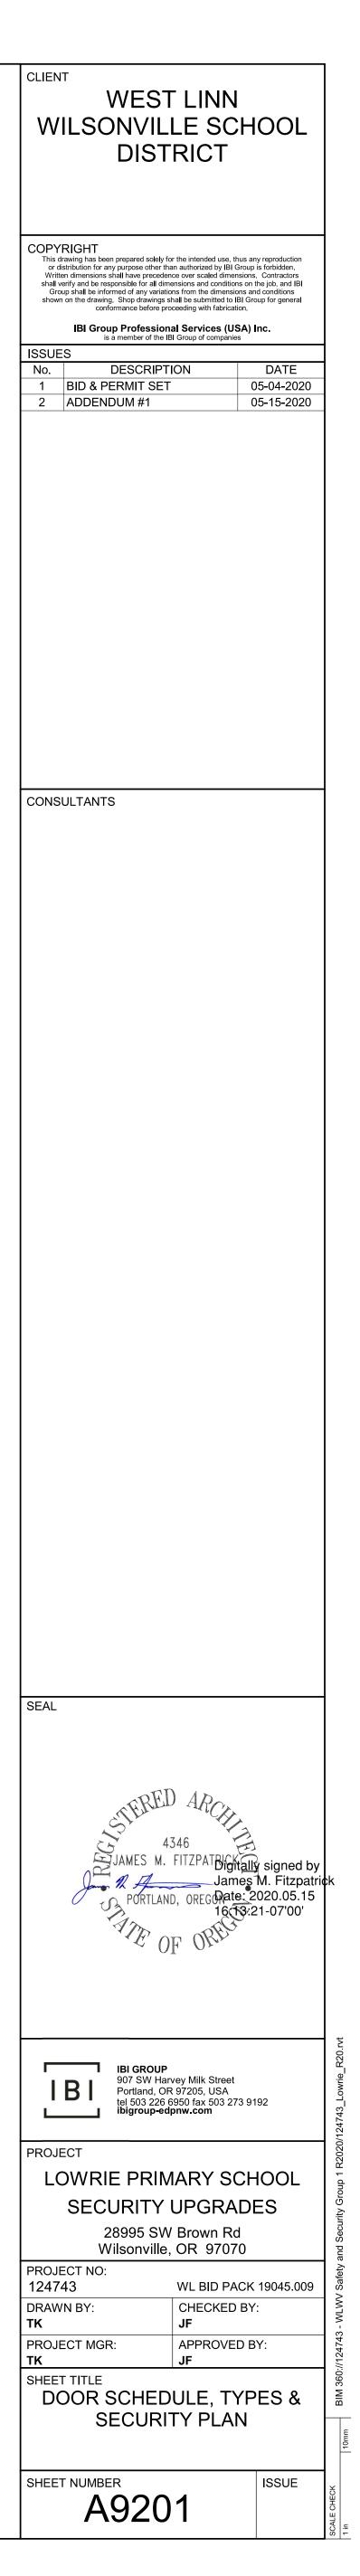

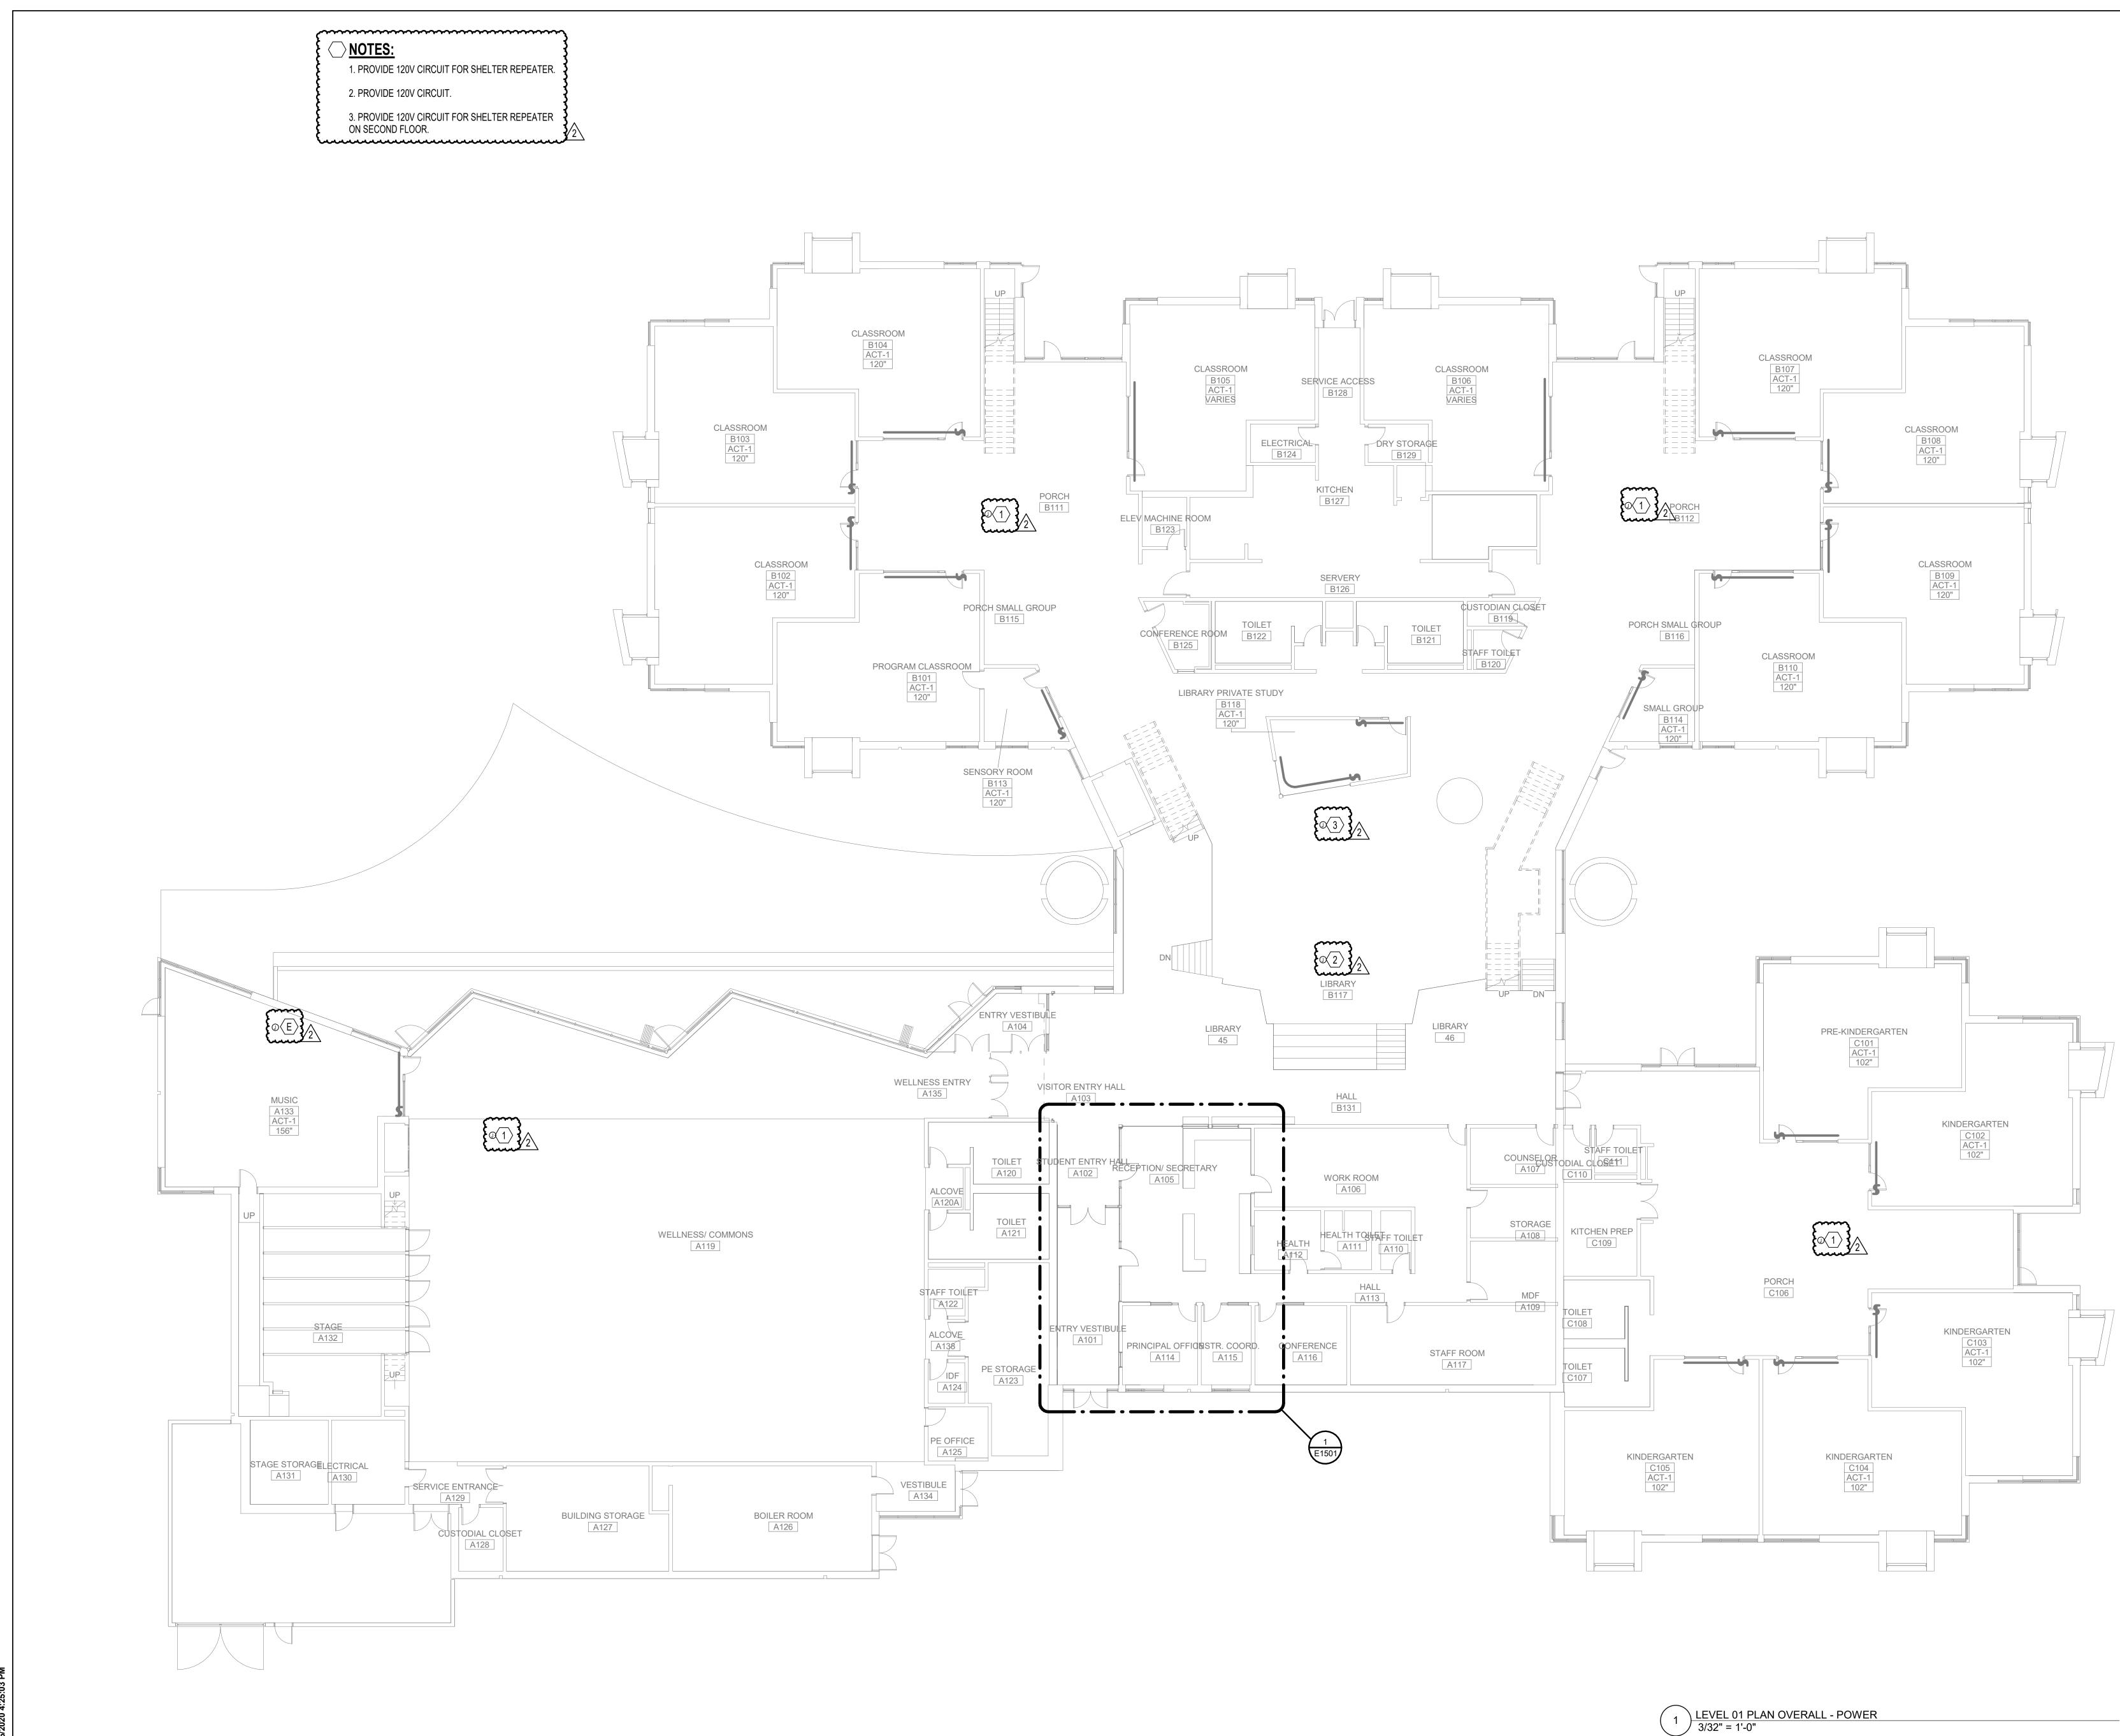


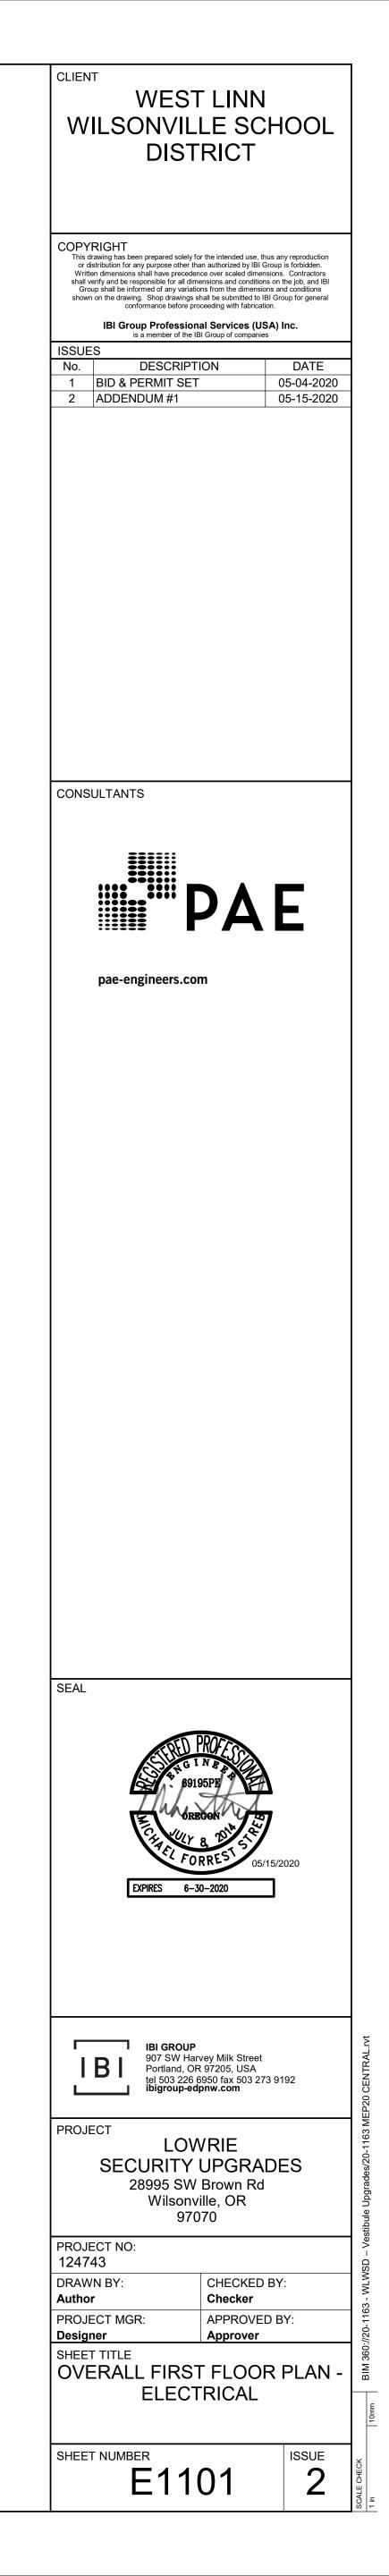


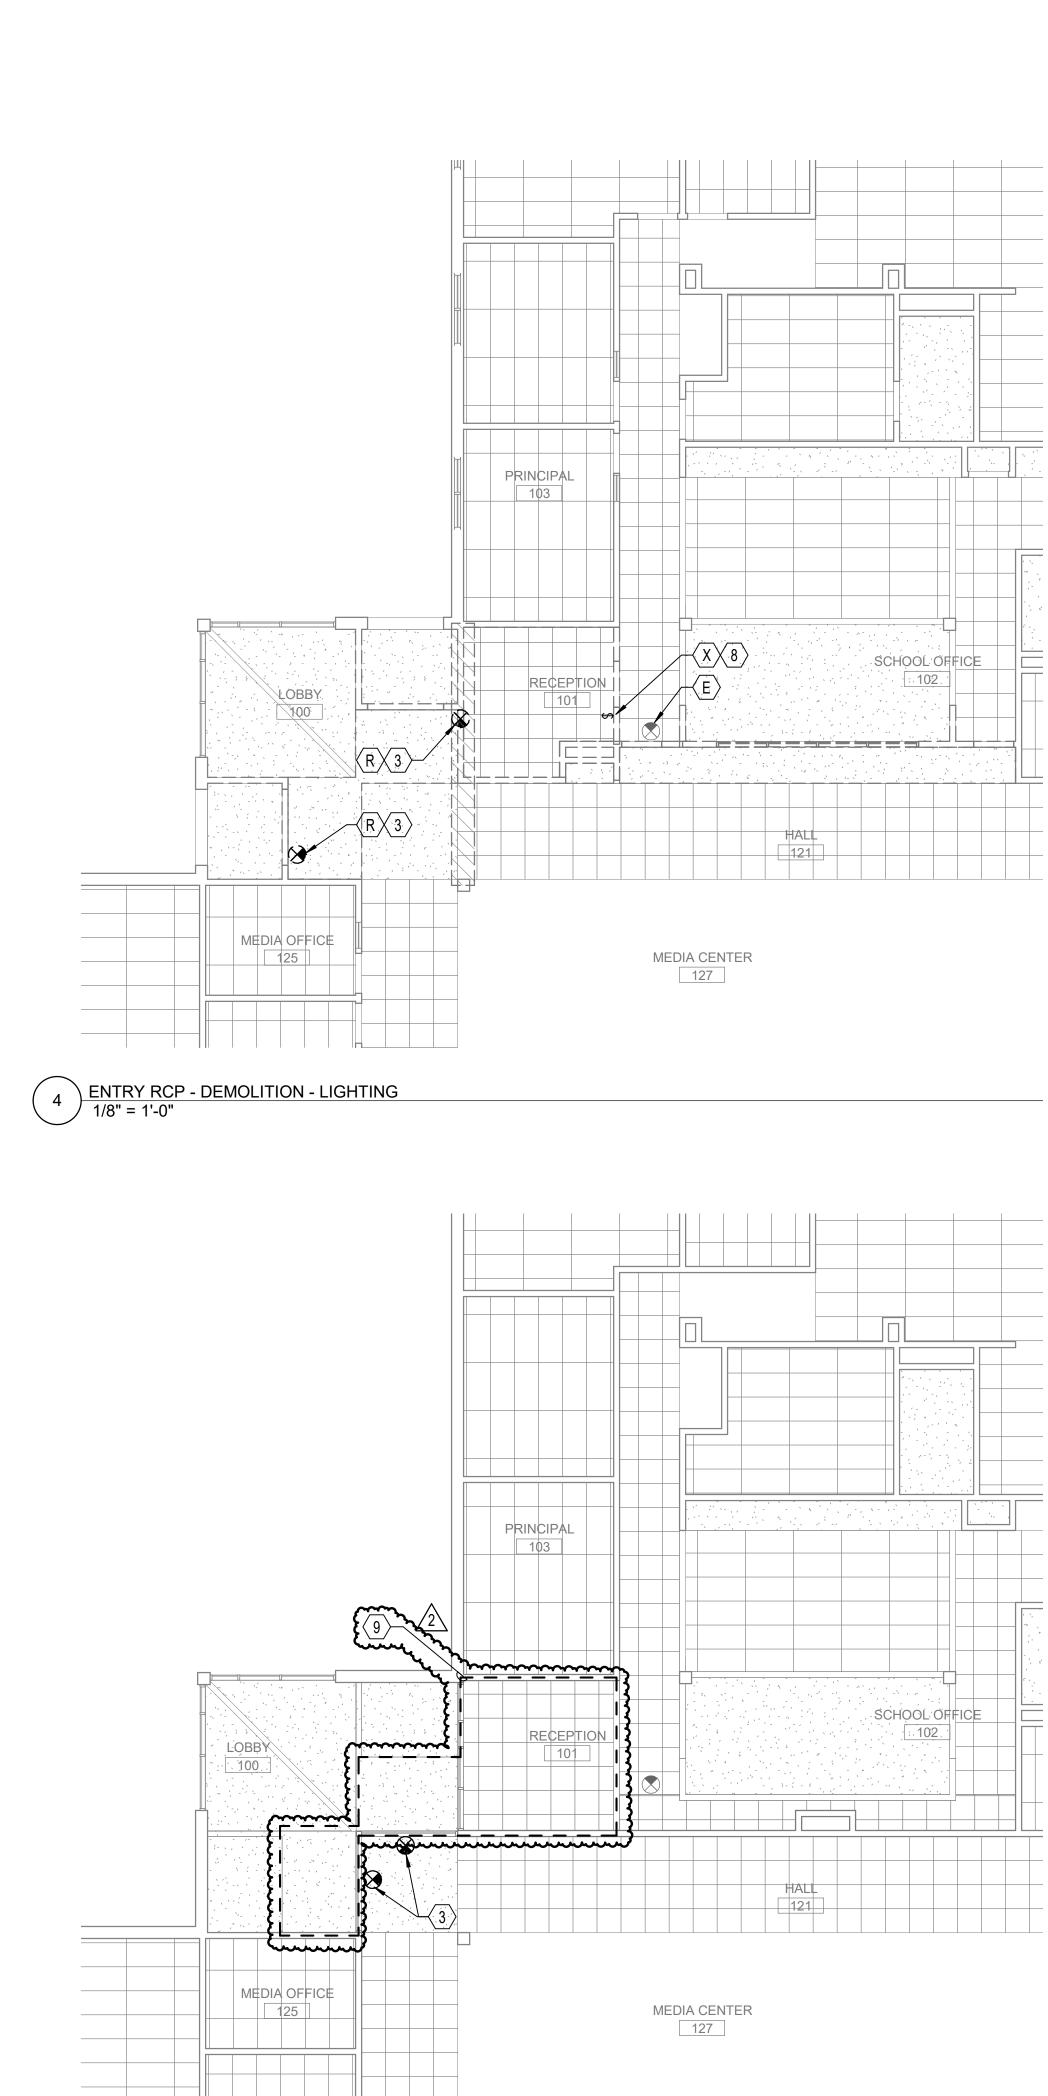

3 ENTRY RCP - NEW CONSTRUCTION - LIGHTING 1/8" = 1'-0"

NCIPAL 103	
	HALL 121

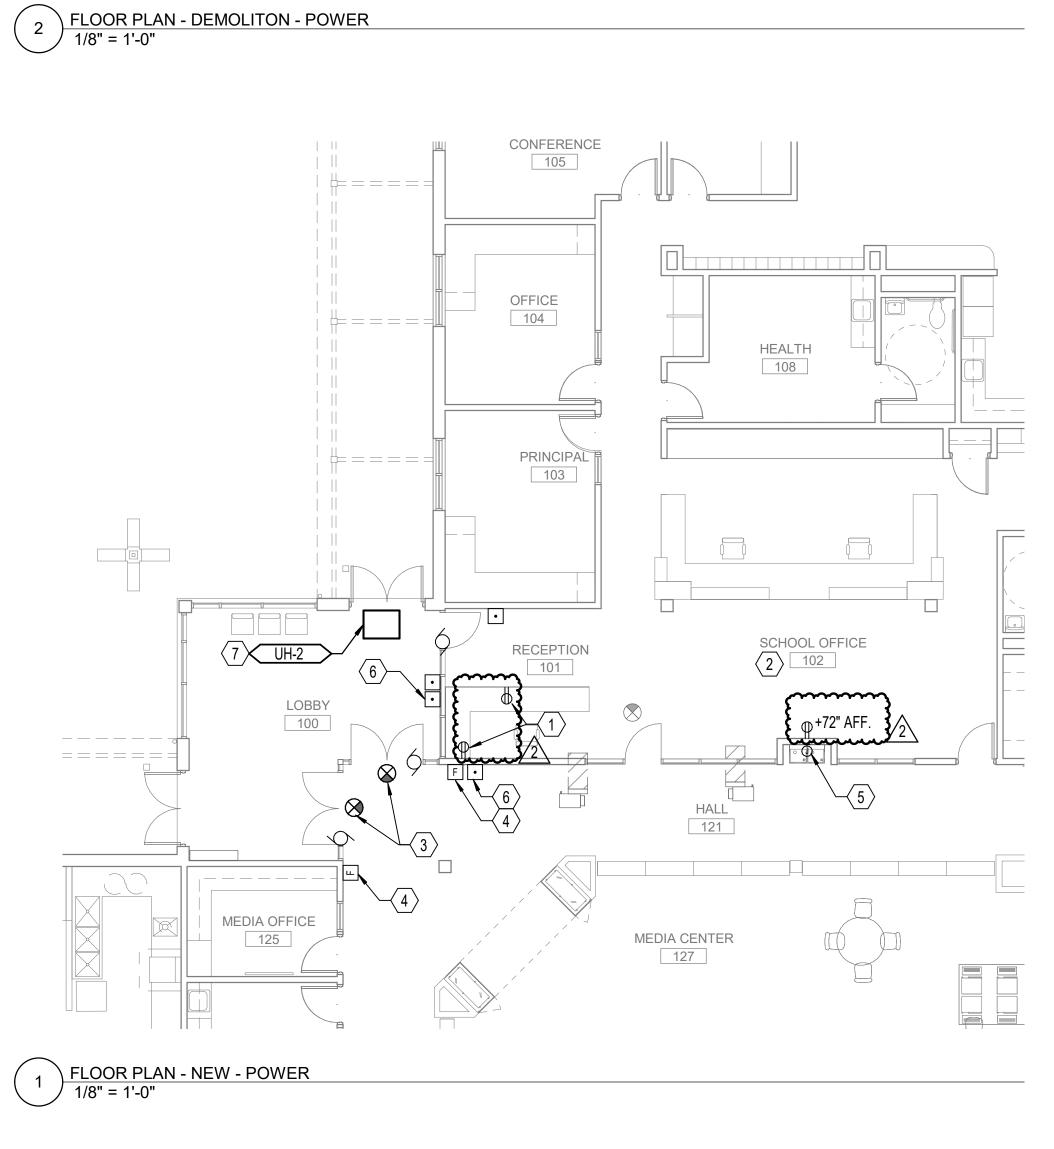

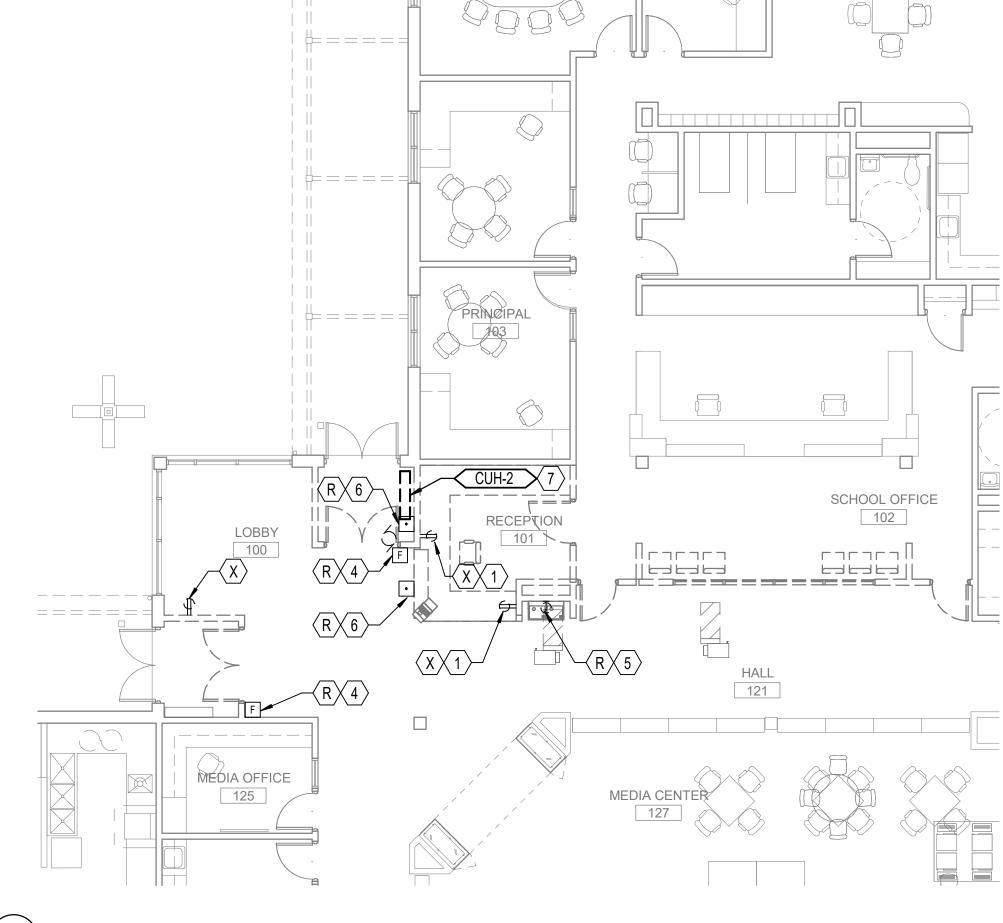

# **GENERAL NOTES:**

A. MAINTAIN CONTINUITY OF EXISTING SYSTEMS WITHIN DASHED BOUNDARY DURRING REMOVAL OF INTERIOR AND EXTERIOR WALLS.

B. PRIOVIDE CONDUIT AND CONDUCTORS AS REQUIRED FOR DIVISION 28 SCOPE OF WORK. SEE DIVISION 28 HARDWARE SPECIFICATIONS FOR REQUIREMENTS.

C. EXISTING LIGHTING AND CONTROL TO REMAIN UNLESS OTHERWISE NOTED ON LIGHTING DETAIL.

# ><u>NOTES:</u>

102

1. REMOVE EXISTING RECEPTACLES. REUSE EXISTING CIRCUIT TO SERVE (2) NEW DUPLEX RECEPTACLES.

2. PROVIDE 120V CONNECTIONS TO SECURITY LOCKDOWN "SHELTER" SYSTEM. REFERENCE DOOR HARDWARE SPECIFICATION FOR MORE INFORMATION. COORDINATE WITH SECURITY SYSTEM INTEGRATOR FOR CONNECTION POINTS.

3. RELOCATE EXISTING EXIT SIGN TO NEW LOCATION SHOWN.

4. RELOCATE EXISTING FIRE ALARM PULL STATION AND COVER TO NEW LOCATION SHOWN.

5. RELOCATE EXISTING CIRCUIT SERVING REFRIGERATED DRINKING FOUNTAIN TO NEW LOCATION SHOWN.


6. RELOCATE EXISTING DOOR OPERATOR POWER CONNECTION, PUSH

BUTTONS AND CONTROL TO NEW LOCATION VIA ACCESIBLE CEILING.

7. RELOCATE EXISTING CONNECTION TO WALL MOUNTED CABINET UNIT HEATER TO CEILING HEATER.

BE SERVED BY EXISTING CIRCUIT AND CONTROL IN SCHOOL OFFICE

9. RE-INSTALL EXISTING LIGHT FIXTURES IN SAME LOCATION.

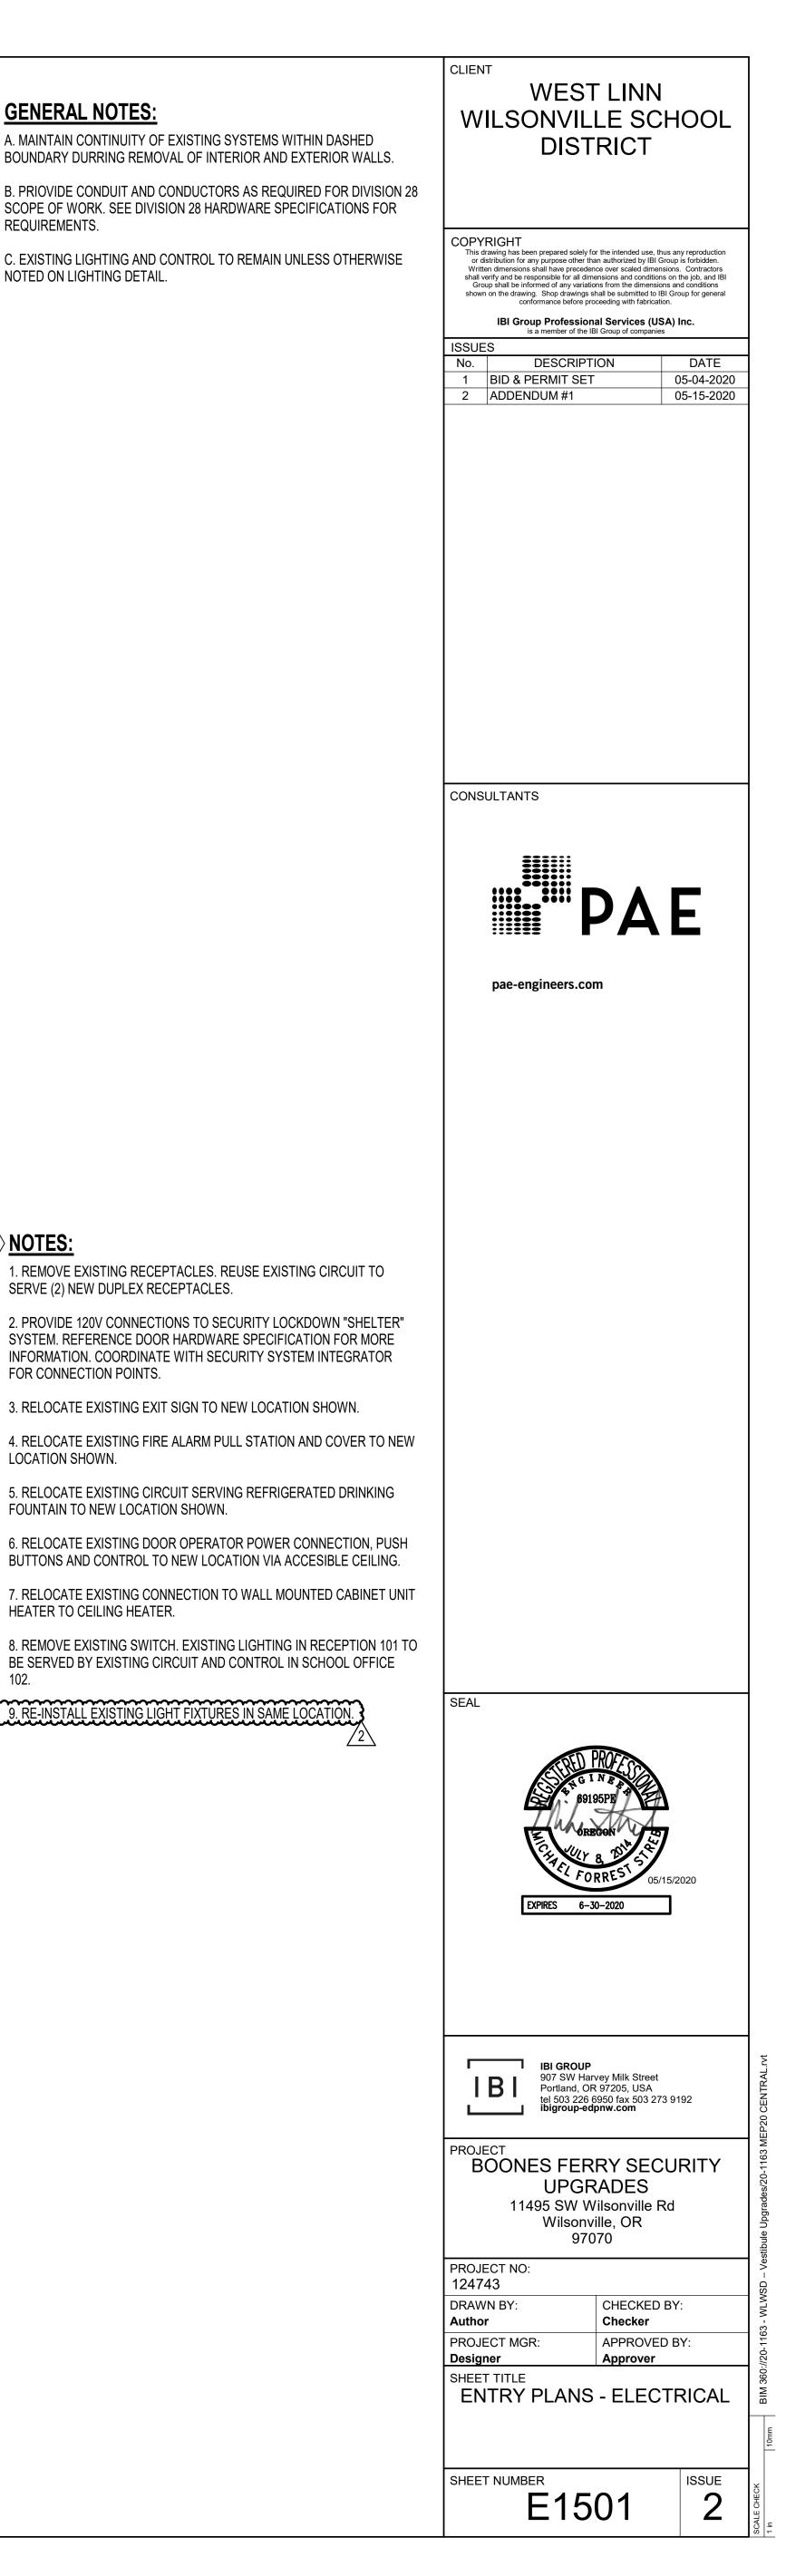


#### **GENERAL NOTES:**


A. MAINTAIN CONTINUITY OF EXISTING SYSTEMS WITHIN DASHED BOUNDARY DURRING REMOVAL OF INTERIOR AND EXTERIOR WALLS.

B. PRIOVIDE CONDUIT AND CONDUCTORS AS REQUIRED FOR DIVISION 28 SCOPE OF WORK. SEE DIVISION 28 HARDWARE SPECIFICATIONS FOR REQUIREMENTS.

C. EXISTING LIGHTING AND CONTROL TO REMAIN UNLESS OTHERWISE NOTED ON LIGHTING DETAIL.

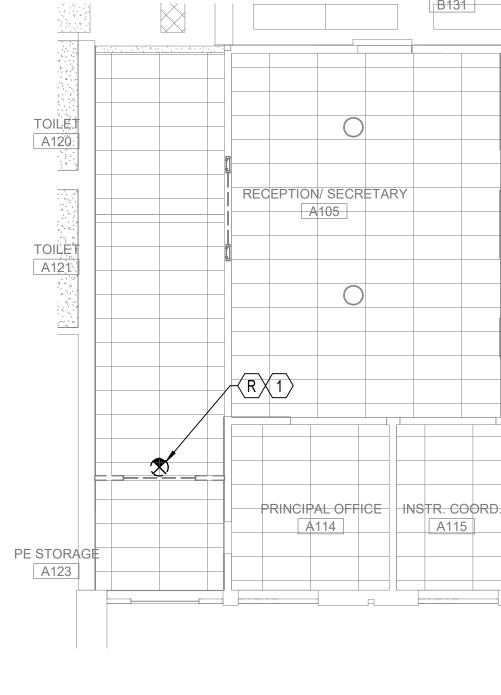

4 ENTRY RCP - DEMOLITION - LIGHTING 1/8" = 1'-0"

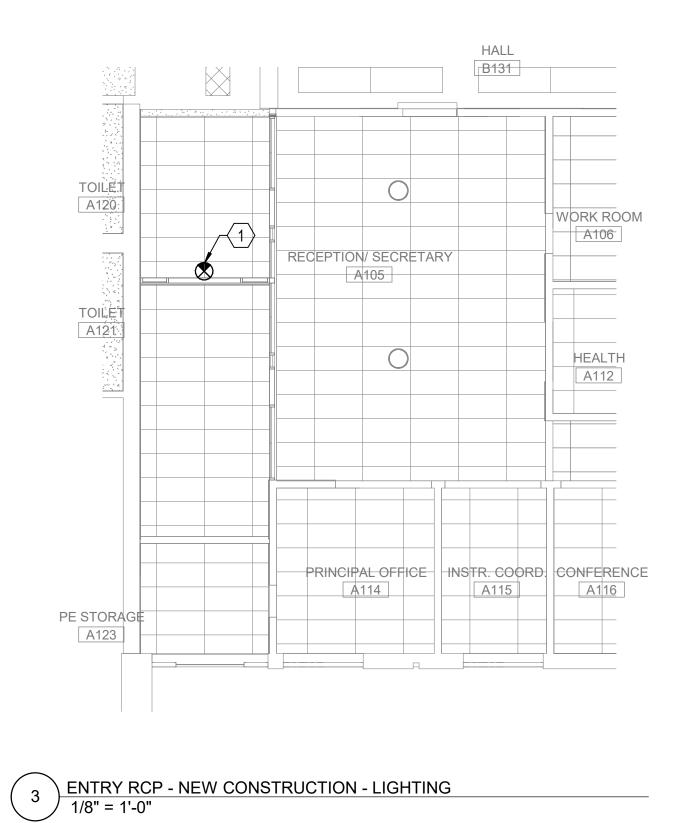

#### ∑<u>NOTES:</u>

1. RELOCATE EXISTING DOOR OPERATOR POWER CONNECTION, PUSH BUTTONS AND CONTROL TO NEW LOCATION VIA ACCESIBLE CEILING.

2. RELOCATE EXISTING EXIT SIGN AND CIRCUIT TO NEW LOCATION VIA ACCESSIBLE CEILING.

3. PROVIDE ADDITIONAL DOOR CONTROL PUSH BUTTON.


4. PROVIDE 120V CONNECTIONS TO SECURITY LOCKDOWN "SHELTER" SYSTEM. REFERENCE DOOR HARDWARE SPECIFICATION FOR MORE INFORMATION. COORDINATE WITH SECURITY SYSTEM INTEGRATOR FOR CONNECTION POINTS.


5. PROVIDE DOOR OPERATOR POWER CONNECTION, PUSH BUTTON AND CONTROL. CONNECT TO EXISTING CIRCUIT SERVING RELOCATED DOOR OPERATOR.


	/~~~~~~~~~~~~~~~~~~~~~~~~~~~~~~~~~~~~~	
	6. PROVIDE DOOR OPERATOR POWER CONNECTION,	3
	PUSH BUTTON AND CONTROL. DOOR LATCH TO	<b>{</b>
	6. PROVIDE DOOR OPERATOR POWER CONNECTION, PUSH BUTTON AND CONTROL. DOOR LATCH TO SHARE THE SAME CIRCUIT AS DOOR OPERATOR.	2
1	hanananananananananananananana	


 $\sim$ 7. PROVIDE 120V CONNECTION FOR OFFICE DOOR CONTROL.

8. PROVIDE 120V CONNECTION FOR SHELTER REPEATER. 

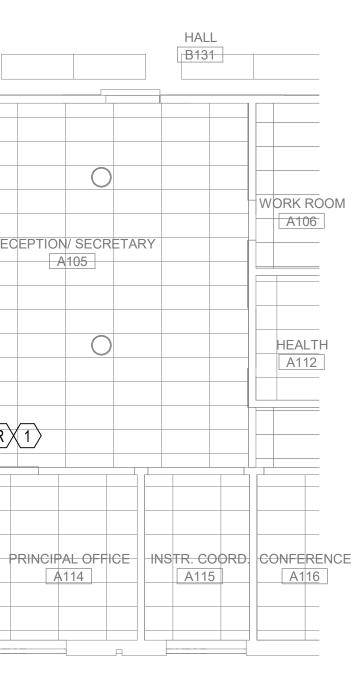


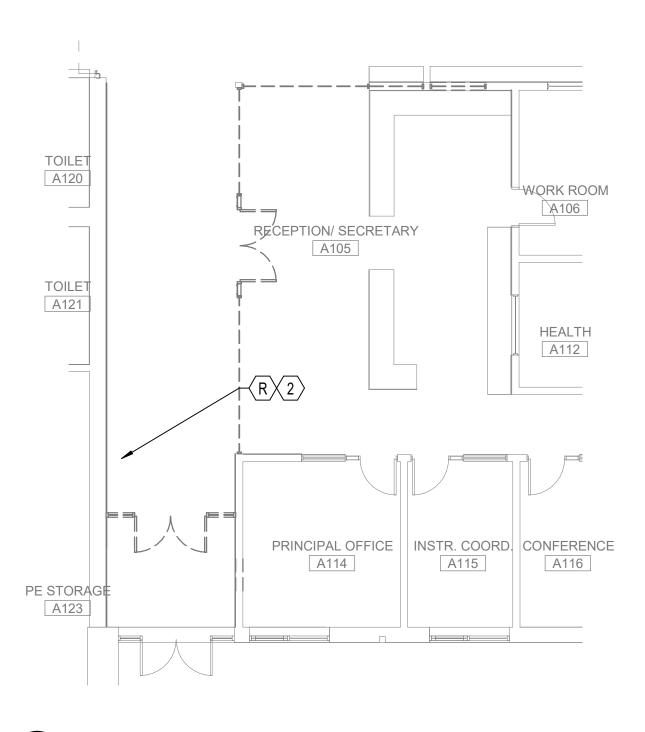


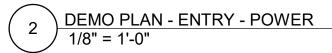


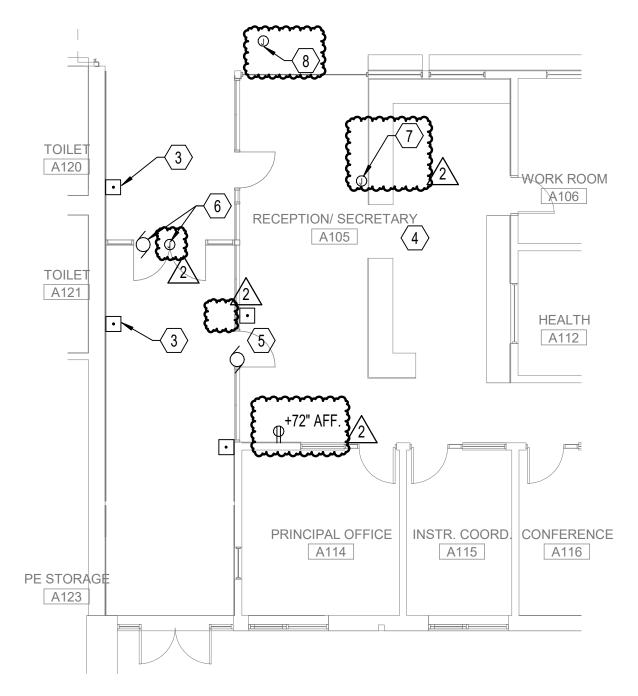


1 FLOOR PLAN - ENTRY - POWER 1/8" = 1'-0"

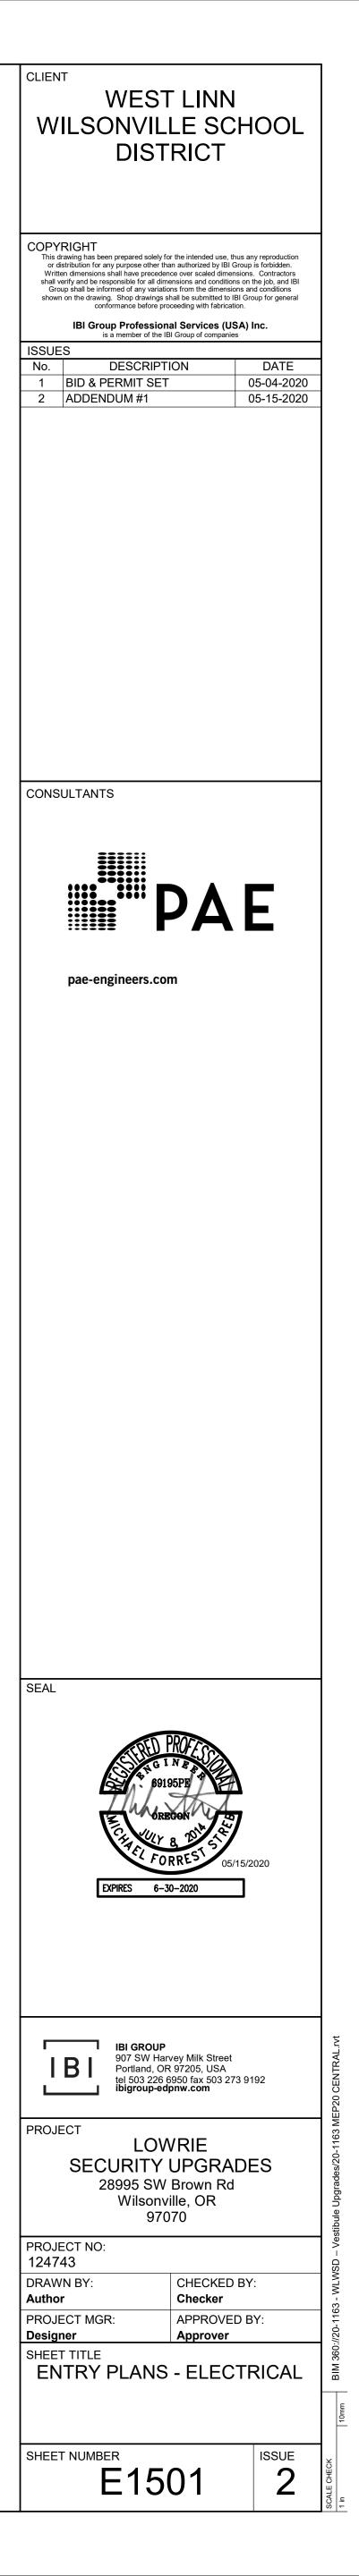


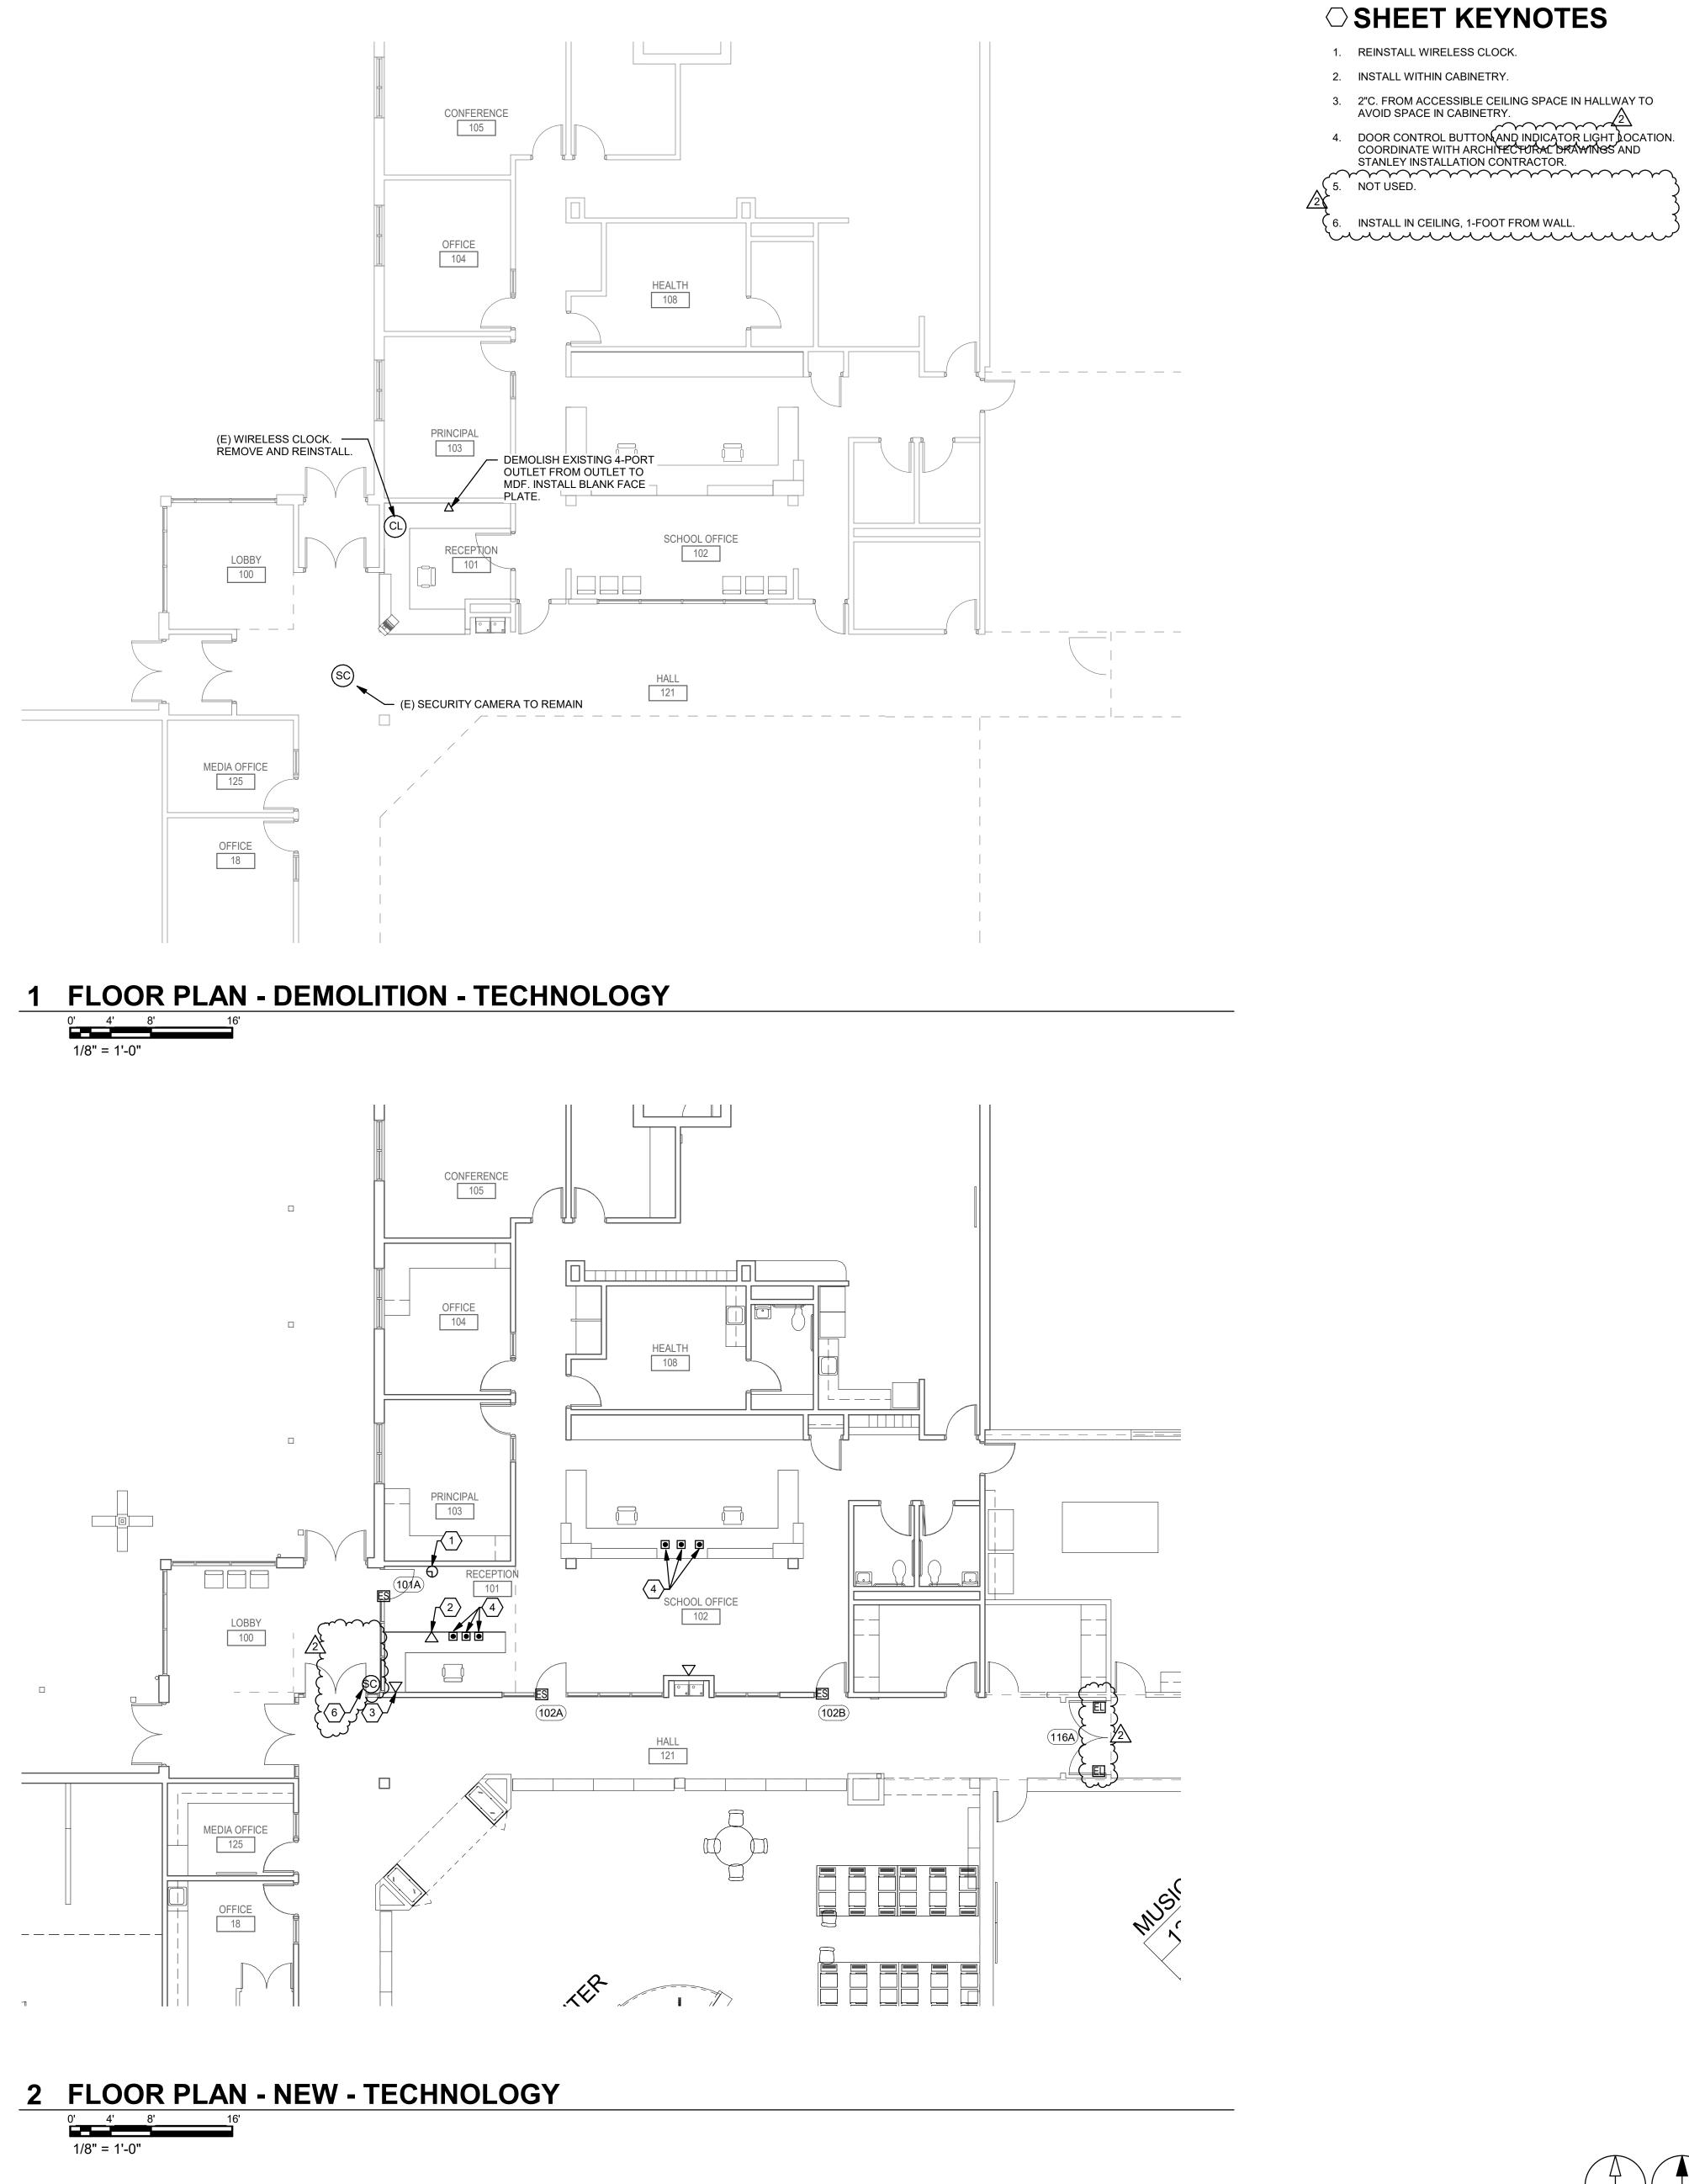


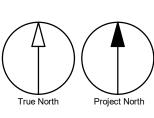

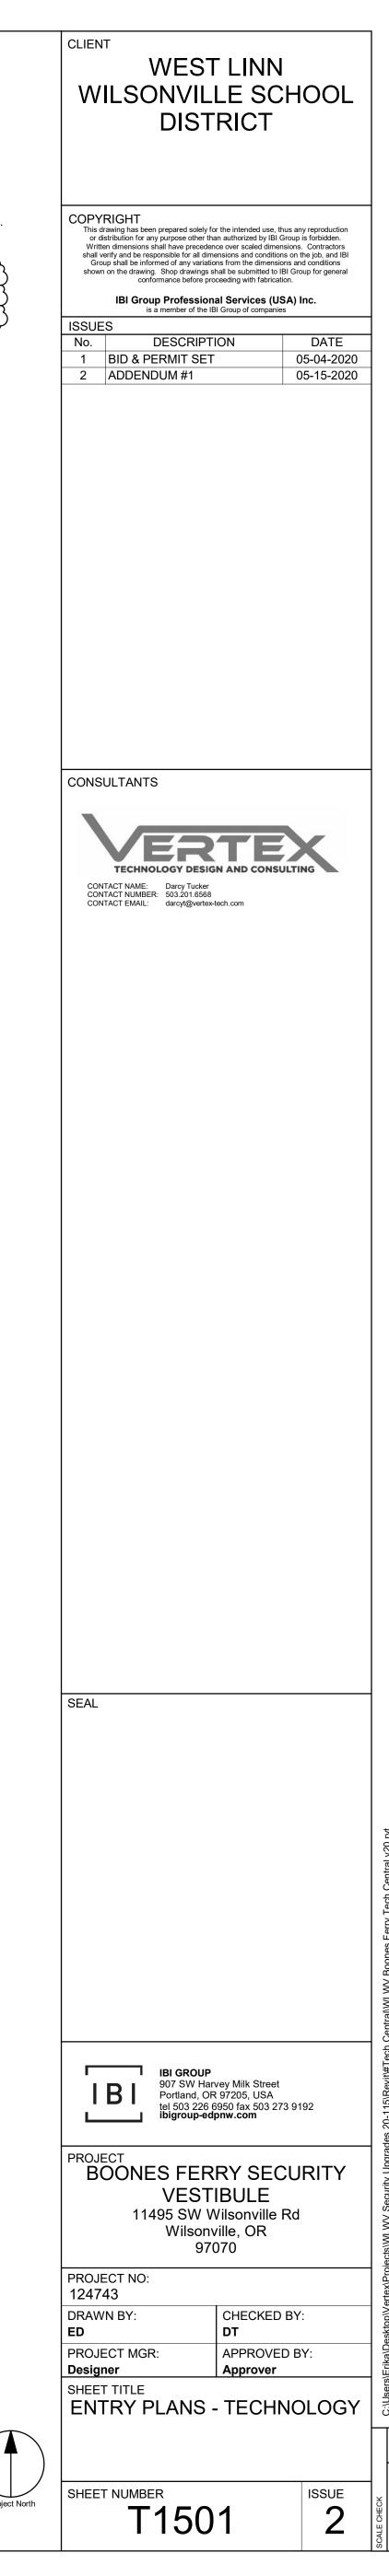

# 5/14/2020 3:21:40 PN

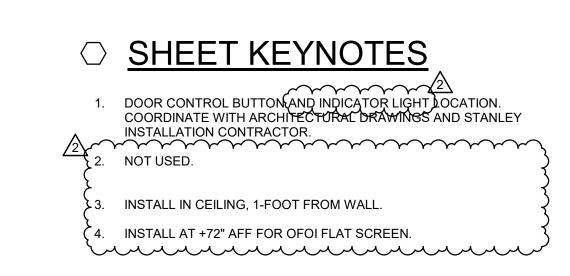

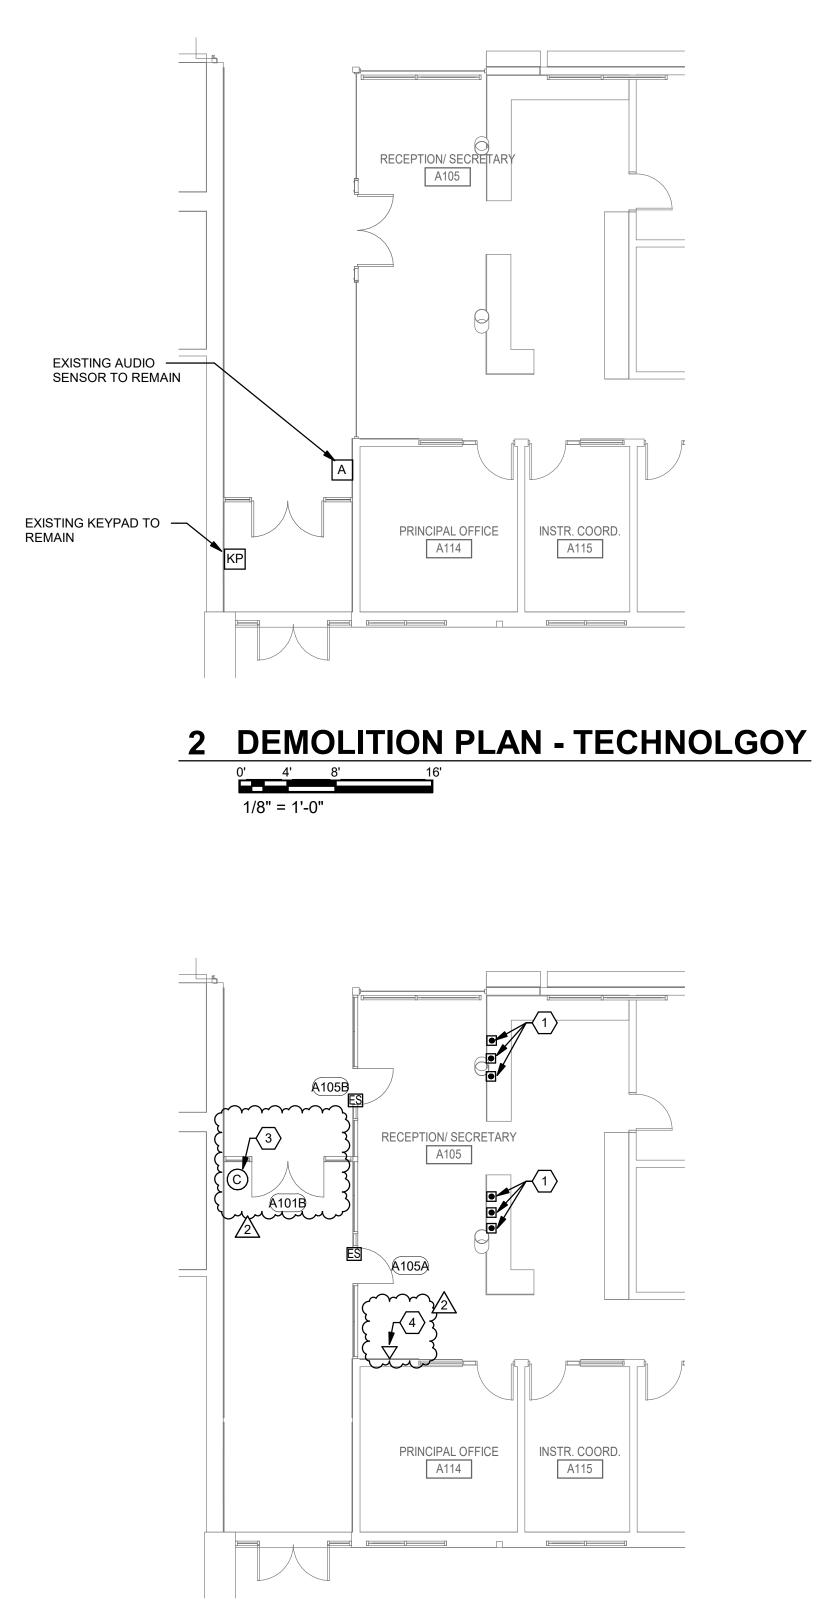

**1 FLOOR PLAN - ENTRY - TECHNOLOGY** 

CLIENT WEST WILSONVILL DIST	E SCH	IOOL	
COPYRIGHT         This drawing has been prepared solely for or distribution for any purpose other than Written dimensions shall have precedencies shall verify and be responsible for all dimer Group shall be informed of any variation shown on the drawing. Shop drawings sha conformance before proce         IBI Group Professiona is a member of the IBI         ISSUES         No.       DESCRIPTIC	authorized by IBI Group e over scaled dimensions isions and conditions on s from the dimensions a all be submitted to IBI Gr eading with fabrication. I Services (USA) Group of companies	is forbidden. s. Contractors the job, and IBI nd conditions oup for general Inc.	-
1 BID & PERMIT SET 2 ADDENDUM #1		05-04-2020 05-15-2020	-
CONSULTANTS	TE	×	
TECHNOLOGY DESIGN CONTACT NAME: CONTACT NUMBER: CONTACT EMAIL: Darcy Tucker 503.201.6568 darcyt@vertex-te			
SEAL			-
			Sentral v20.rvt
			Security Upgrades 20-115\Revit\#Tech Central\WLWV Lowrie Tech Central v20.rvt
PROJECT LOWRIE S UPGR/ 28995 SW	97205, USA 950 fax 503 273 9 nw.com ECURIT ADES Brown Rd		
Wilsonvi 970 PROJECT NO: 124743 DRAWN BY: ED PROJECT MGR: Designer	lle, OR		C:\Users\Erika\Desktop\Vertex\Projects\WLWV
SHEET TITLE ENTRY PLANS - SHEET NUMBER		DLOGY ISSUE	10mm
T150	1	2	SCALE CHECK 1 in

# TECHNOLOGY SYMBOL LIST

### **ABBREVIATIONS**

(E)	EXISTING
(N)	NEW
(X)	DEMOLISH
AFF	ABOVE FINISHED FLOOR
С	CONDUIT
CATV	CABLE TELEVISION
CFCI	CONTRACTOR FURNISHED CONTRACTOR INSTALLED
CFOI	CONTRACTOR FURNISHED OWNER INSTALLED
IDF	INTERMEDIATE DISTRIBUTION FRAME
MDF	MAIN DISTRIBUTION FRAME
NTS	NOT TO SCALE
OFCI	OWNER FURNISHED, CONTRACTOR INSTALLED
OFOI	OWNER FURNISHED, OWNER INSTALLED
QTY	QUANTITY
TGB	TELECOMMUNICATIONS GROUNDING BUS BAR
TYP	TYPICAL
UON	UNLESS OTHERWISE NOTED
UPS	UNINTERRUPTABLE POWER SUPPLY
WAP	WIRELESS ACCESS POINT
WP	WEATHERPROOF

<u>SECURI</u>	<u>TY</u>	RACEWA	YS
0	3/4"C. FROM DOOR CONTROL BUTTON (BY OTHERS) TO ACCESSIBLE CEILING SPACE.		COMMUNICATIONS CABLE RUNWAY
	PATHWAY ONLY.		CONDUIT ABOVE GRADE
Α	SINGLE GANG BACKBOX WITH 3/4"C. FROM AUDIO SENSOR (BY SONITROL) TO NEAREST ACCESSIBLE CEILING SPACE. PATHWAY ONLY.		CONDUIT BELOW GRADE OR SLAB
	BACKBOX TO BE MOUNTED HORIZONTALLY.		CONDUIT DOWN
EL	3/4"C. FROM POWER TRANSFER HINGE (BY OTHERS) TO NEAREST ACCESSIBLE CEILING	]	CONDUIT SLEEVE
	SPACE. PATHWAY ONLY. REFER TO DETAIL 1/T1601.	————————————————————	CONDUIT UP
ES	3/4"C. FROM ELECTRIC STRIKE (BY OTHERS) TO NEAREST ACCESSIBLE CEILING SPACE.		CONDUIT/WIRING CONTINUATION
-	PATHWAY ONLY. REFER TO DETAIL 2/T1601.	├──⊚	GROUNDING POINT
DS	3/4"C. FROM DOOR CONTACT (BY OTHERS) TO NEAREST ACCESSIBLE CEILING SPACE. PATHWAY ONLY. REFER TO DETAILS 1/T1601	HH	HANDHOLE
2~~~~~	AND $2/T1601$ .	VT	COMMUNICATIONS VAULT
			COMMUNICATIONS BACKBOARD
} { (c)	1"C. TO NEAREST ACCESSIBLE CEILING SPACE		WIRE BASKET CABLE TRAY
$\sum_{i=1}^{i}$	TELECOM ROOM. CAMERAS ARE OFOI. PROVIDE	COMMU	NICATIONS

 $\bigtriangledown$ 

10-FOOT SERVICE LOOP ON CAMERA END. 


#### EQUIPMENT ROOMS

2-POST EQUIPMENT RACK

4-POST EQUIPMENT RACK

ENCLOSED CABINET

# <u>GENERAL</u>

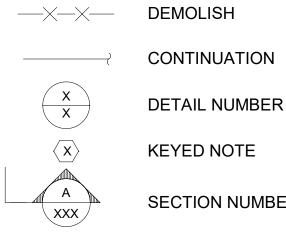

0 0

KEYED NOTE

SECTION NUMBER AND SHEET LOCATION

STANDARD COMMUNICATIONS OUTLET WITH
(3) CAT6A CABLE(S) TO NEAREST MDF/IDF AND 1"C. TO ACCESSIBLE CEILING SPACE.

DOUBLE-SIDED VERTICAL WIRE MANAGEMENT

DETAIL NUMBER AND SHEET LOCATION

# **GENERAL SHEET NOTES**

- A. COMMUNICATIONS RACEWAYS, TRAYS, AND OUTLETS ARE SHOWN DIAGRAMMATICALLY. LOCATIONS ARE APPROXIMATE UNLESS SPECIFICALLY DIMENSIONED. FIELD COORDINATE ALL WORK WITH OTHER TRADES.
- B. CONSTRUCTION DETAILS SHOW TYPICAL INSTALLATION, UON, AND APPLY TO ALL COMMUNICATIONS WORK INCLUDED IN THE SUMMARY OF WORK FOR THIS PACKAGE EVEN THOUGH NOT SPECIFICALLY REFERENCED ON THE PLAN DRAWINGS.
- C. INSTALL PULL STRINGS IN ALL CONDUITS AT THE TIME OF CONDUIT AND CABLE INSTALLATION.



T1101 OVERALL FIRST FLOOR PLAN - TECHNOLOGY T1501 ENTRY PLANS - TECHNOLOGY T1601 DETAILS - TECHNOLOGY

WEST LINN WILSONVILLE SCH DISTRICT	OOL
	is forbidden. . Contractors the job, and IBI id conditions sup for general
CONSULTANTS VERTICAL STATES TECHNOLOGY DESIGN AND CONSULTI CONTACT NAME: CONTACT NAME: CONTACT NUMBER: SO3.201.6568 CONTACT EMAIL: Darcy Tucker SO3.201.6568 darcyt@vertex-tech.com	NG
SEAL	
IBI GROUP 907 SW Harvey Milk Street 907 SW Harvey Milk Street	92 RITY
PROJECT BOONES FERRY SECU VESTIBULE 11495 SW Wilsonville Rd Wilsonville, OR 97070 PROJECT NO:	
PROJECT NO.         124743         DRAWN BY:       CHECKED BY         ED       DT         PROJECT MGR:       APPROVED B         Designer       Approver         SHEET TITLE       SYMBOL LIST AND GEN         NOTES - TECHNOLOG	Y: ERAL
sheet number TG0000	ISSUE 2

# TECHNOLOGY SYMBOL LIST

# SECHDITY

	AB	BR	EV	IAT	101	<b>1</b> S
--	----	----	----	-----	-----	------------

		SECURI	ТУ
(E)	EXISTING		<u></u>
(N)	NEW	٥	3/4"C. FROM DOOR CO
(X)	DEMOLISH		OTHERS) TO ACCESS PATHWAY ONLY.
AFF	ABOVE FINISHED FLOOR	A	SINGLE GANG BACKB
С	CONDUIT		AUDIO SENSOR (BY S ACCESSIBLE CEILING
CATV	CABLE TELEVISION		BACKBOX TO BE MOL
CFCI	CONTRACTOR FURNISHED CONTRACTOR INSTALLED	EL	3/4"C. FROM POWER
CFOI	CONTRACTOR FURNISHED OWNER INSTALLED		OTHERS) TO NEARES SPACE. PATHWAY ON
IDF	INTERMEDIATE DISTRIBUTION FRAME		1/T1601.
MDF	MAIN DISTRIBUTION FRAME	ES	3/4"C. FROM ELECTRI TO NEAREST ACCESS
NTS	NOT TO SCALE		PATHWAY ONLY. REF
OFCI	OWNER FURNISHED, CONTRACTOR INSTALLED	DS	3/4"C. FROM DOOR CO
OFOI	OWNER FURNISHED, OWNER INSTALLED		NEAREST ACCESSIBL PATHWAY ONLY. REF
QTY	QUANTITY	A~~~~~	AND 2/T1601.
TGB	TELECOMMUNICATIONS GROUNDING BUS BAR	<u> </u>	
TYP	TYPICAL	È	
UON	UNLESS OTHERWISE NOTED	Ş	1"C. TO NEAREST ACC
UPS	UNINTERRUPTABLE POWER SUPPLY	<b>}</b> ©	AND (1) CATEGORY 64
WAP	WIRELESS ACCESS POINT	ξ	TELECOM ROOM. CAN 10-FOOT SERVICE LO
WP	WEATHERPROOF	KS	SINGLE GANG BACKB

# EQUIPMENT ROOMS

° ° 	2-POST EQUIPMENT R
	4-POST EQUIPMENT R
	DOUBLE-SIDED VERTI
	ENCLOSED CABINET

### <u>GENERAL</u>

$\longrightarrow$	$\langle - \rangle$	<
$\left( \right)$	$\mathbf{x}$	$\rightarrow$
	$\langle \mathbf{x} \rangle$	
	A XXX	

- DEMOLISH CONTINUATION DETAIL NUMBER AND SHEET LOCATION
- KEYED NOTE
- SECTION NUMBER AND SHEET LOCATION

<u>RITY</u>	RACEWA	<u>YS</u>
3/4"C. FROM DOOR CONTROL BUTTON (BY OTHERS) TO ACCESSIBLE CEILING SPACE.		COMMUNICATIONS CABLE RUNWAY
PATHWAY ONLY.		CONDUIT ABOVE GRADE
SINGLE GANG BACKBOX WITH 3/4"C. FROM AUDIO SENSOR (BY SONITROL) TO NEAREST ACCESSIBLE CEILING SPACE. PATHWAY ONLY.		CONDUIT BELOW GRADE OR SLAB
BACKBOX TO BE MOUNTED HORIZONTALLY.		CONDUIT DOWN
3/4"C. FROM POWER TRANSFER HINGE (BY OTHERS) TO NEAREST ACCESSIBLE CEILING	]	CONDUIT SLEEVE
SPACE. PATHWAY ONLY. REFER TO DETAIL 1/T1601.	———————————————————————————————————————	CONDUIT UP
3/4"C. FROM ELECTRIC STRIKE (BY OTHERS) TO NEAREST ACCESSIBLE CEILING SPACE.		CONDUIT/WIRING CONTINUATION
PATHWAY ONLY. REFER TO DETAIL 2/T1601.		GROUNDING POINT
3/4"C. FROM DOOR CONTACT (BY OTHERS) TO NEAREST ACCESSIBLE CEILING SPACE. PATHWAY ONLY. REFER TO DETAILS 1/T1601	HH	HANDHOLE
AND 2/T1601.	VT	COMMUNICATIONS VAULT
		COMMUNICATIONS BACKBOARD
1"C. TO NEAREST ACCESSIBLE CEILING SPACE		WIRE BASKET CABLE TRAY
TELECOM ROOM. CAMERAS ARE OFOI. PROVIDE	<u>COMMU</u>	NICATIONS
SINGLE GANG BACKBOX WITH 3/4"C. TO NEAREST ACCESSIBLE CEILING SPACE. KEY SWITCH BY OTHERS.	$\bigtriangledown$	STANDARD COMMUNICATIONS OUTLET WITH (3) CAT6A CABLE(S) TO NEAREST MDF/IDF AND 1"C. TO ACCESSIBLE CEILING SPACE.

MENT RACK

MENT RACK

VERTICAL WIRE MANAGEMENT

# **GENERAL SHEET NOTES**

- A. COMMUNICATIONS RACEWAYS, TRAYS, AND OUTLETS ARE SHOWN DIAGRAMMATICALLY. LOCATIONS ARE APPROXIMATE UNLESS SPECIFICALLY DIMENSIONED. FIELD COORDINATE ALL WORK WITH OTHER TRADES.
- B. CONSTRUCTION DETAILS SHOW TYPICAL INSTALLATION, UON, AND APPLY TO ALL COMMUNICATIONS WORK INCLUDED IN THE SUMMARY OF WORK FOR THIS PACKAGE EVEN THOUGH NOT SPECIFICALLY REFERENCED ON THE PLAN
- DRAWINGS. C. INSTALL PULL STRINGS IN ALL CONDUITS AT THE TIME OF CONDUIT AND CABLE INSTALLATION.



TG0000 SYMBOL LIST AND GENERAL NOTES - TECHNOLOGY T1101 OVERALL FIRST FLOOR PLAN - TECHNOLOGY T1501 ENTRY PLANS - TECHNOLOGY T1601 DETAILS - TECHNOLOGY

CLIENT	
WEST LINN	
WILSONVILLE SCH	OOL
COPYRIGHT This drawing has been prepared solely for the intended use, thus any or distribution for any purpose other than authorized by IBI Group i Written dimensions shall have precedence over scaled dimensions.	s forbidden. Contractors
shall verify and be responsible for all dimensions and conditions on the Group shall be informed of any variations from the dimensions and shown on the drawing. Shop drawings shall be submitted to IBI Gro conformance before proceeding with fabrication.	d conditions
IBI Group Professional Services (USA) In is a member of the IBI Group of companies	nc.
No. DESCRIPTION	DATE 5-04-2020
2 ADDENDUM #1 0	5-15-2020
CONSULTANTS	
	_
TECHNOLOGY DESIGN AND CONSULTIN	NG
CONTACT NAME: Darcy Tucker CONTACT NUMBER: 503.201.6568 CONTACT EMAIL: darcyt@vertex-tech.com	
SEAL	
	ral v20.rv
	ech Cent
	Lowrie T
	al/WL WV
	sch Centr
IBI GROUP 907 SW Harvey Milk Street Portland, OR 97205, USA	\Revit\#T€
tel 503 226 6950 fax 503 273 91 ibigroup-edpnw.com	92 [115] \$20-115
	Security Upgrades 20-115\Revit\#Tech Central\WLWV Lowrie Tech Central v20.rvt
UPGRADES 28995 SW Brown Rd	
Wilsonville, OR 97070	cts/WLW
PROJECT NO: 124743	tex/Projec
DRAWN BY: CHECKED BY: ED DT	iktop/Vert
PROJECT MGR: APPROVED B' Designer Approver	C:\Users\Erika\Desktop\Vertex\Projects\WLWV
SHEET TITLE SYMBOL LIST AND GEN	
NOTES - TECHNOLOG	
SHEET NUMBER	
TG0000	2
	SCA 1 in