# LIBERTY ELEMENTARY SCHOOL 2020 RENOVATION AND REPAIR PROJECT 2345 LIBERTY ST. SW, ALBANY, OR 97321 REPIPE AND REMODEL

#### PROJECT TEAM

**GREATER ALBANY PUBLIC SCHOOLS** OWNER: 718 SEVENTH AVE. SW

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PROJECT MANAGER:

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SALEM, OREGON 97301

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email: john@andersonshirley.com email: danny@andersonshirley.com

MECHANICAL/ MFIA, INC. CONSULTING ENGINEERS **ELECTRICAL**:

2007 SE ASH ST.

PORTLAND, OR 97214 CONTACT: JIM TORMEY

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STRUCTURAL: MSC ENGINEERS, INC.

3470 PIPEBEND PL. NE #120 SALEM, OR 97301 CONTACT:

**CAM CARROLL** email: camc@mscengineers.com

#### **DRAWING INDEX**

#### ARCHITECTURAL:

- A0.0 TITLE PAGE, SITE PLAN, & GENERAL NOTES
- A1.1 KEY PLAN
- A2.1 FLOOR PLANS & REFLECTED CEILING PLAN A2.2 FLOOR PLANS & REFLECTED CEILING PLAN
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#### PLUMBING:

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DP3.1 ENLARGED PLUMBING DEMOLITION FLOOR PLAN P2.1 PLUMBING FLOOR PLAN

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- P6.4 PLUMBING DETAILS
- **MECHANICAL**

#### M3.1 MECHANICAL PLAN

**ELECTRICAL**:

E1.1 ELECTRICAL PLAN

#### PROJECT SCOPE

- 1. REPLACE EXISTING DOMESTIC WATER PIPES
- 2. UPGRADE SELECTED RESTROOMS TO MEET ADA 3. REMODEL EXISTING SIDE ENTRY

# **GENERAL NOTES**


ALL QUANTITIES ARE FOR INFORMATION ONLY, CONTRACTOR TO VERIFY ALL QUANTITIES.

GENERAL CONTRACTOR TO FIELD VERIFY ALL EXISTING CONDITION AND DIMENSIONS.

ALL CONSTRUCTION / DEMOLITION MATERIAL TO BE CLEANED UP DAILY.

ALL CONTENTS (FURNITURE) WITHIN THE AREA OF CONSTRUCTION TO BE PROTECTED FROM DAMAGE AND/OR REMOVED BY GENERAL CONTRACTOR.

#### PROJECT LOCATION-

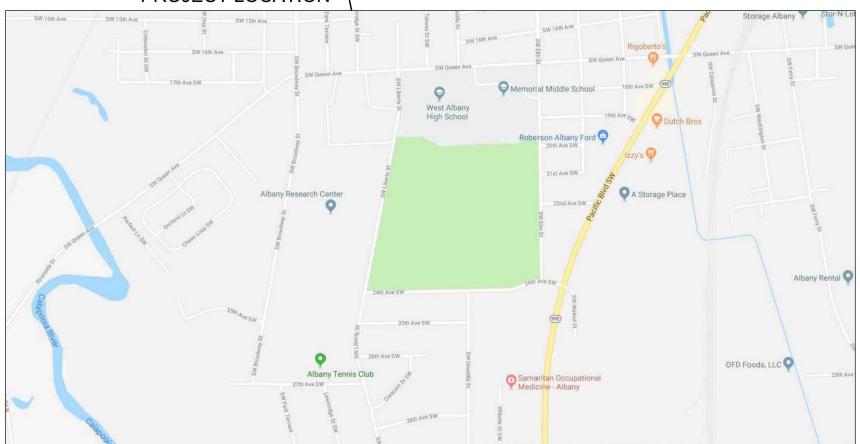

## **VICINITY MAP**

NOT TO SCALE

#### SITE AERIAL NOT TO SCALE

#### **CODE SUMMARY**

STATE OF OREGON STRUCTURAL SPECIALTY CODE 2010 EDITION OF THE 2009 INTERNATIONAL BUILDING CODE

OCCUPANCY GROUP: E CONSTRUCTION TYPE: V-B SPRINKLERS: NO

ALLOWABLE AREA: 9,500 S.F.

ACTUAL AREA: (SEE FLOOR PLAN ON SHEET A1.1) AREA A: 30,021 S.F. (NO CHANGE IN AREA) AREA B: 8,248 S.F. + 250 S.F. ENTRY PORCH = 8,498 S.F.

REQUIRED EXITS: NO CHANGE IN EXITING OR OCCUPANT LOAD PLUMBING FIXTURES: NO CHANGE IN FIXTURE COUNT

PORTABLE CLASSROOMS: 1,680 S.F. + 1,680 S.F. = 3,360 S.F.

REQUIRED RATINGS: EXISTING 2-HOUR FIRE DOOR TO REMAIN

-NEW ENTRY PORCH






DRAWING SYMBOLS (NOT ALL SYMBOLS MAY BE USED IN THIS PROJECT)					
X DRAWING TITLE  SCALE	DETAIL NUMBER SHEET NUMBER WALL / BLDG. SECTION				
——————————————————————————————————————	ELEVATION NUMBER SHEET NUMBER INTERIOR ELEVATIONS				
123 DOOR NUMBER	DETAIL NUMBER SHEET NUMBER DETAIL REFERENCE				
ROOM TITLE ROOM NAME / NUMBER 123	NORTH ARROW				
NEW DOOR	X WINDOW TYPE				
EXISTING DOOR	X GLASS TYPE				
EXISTING DOOR  TO BE REMOVED	X WALL TYPE				
	====== 1-HR. RATED WALL				

ABBREVIATIONS									
SF DIA.  @ & CL. PL. +\- A.B. A.C. ACOUS. ACT. A.D. ADJ. A.F.F. AGGR. ALUM. ALT. APPROX.	SQUARE FEET DIAMETER AT AND CENTER LINE PLATE PLUS/MINUS ANCHOR BOLT ASPHALTIC CONCRETE ACOUSTICAL ACOUSTICAL ACOUSTICAL CEILING TILE AREA DRAIN ADJUSTABLE ABOVE FINISHED FLOOR AGGREGATE ALUMINUM ALTERNATE APPROXIMATE	CORR. CLG. CPT.  DBL. D.F. DIM. DN. DWR. D.S.  (E) EA. E.I.F.S. EL. ELEC. ELEV. E.P. EQ.	CORRIDOR CEILING CARPET  DOUBLE DRINKING FOUNTAIN DIMENSION DOWN DRAWER DOWNSPOUT  EXISTING EACH EXTERIOR INSULATION & FINISH SYSTEM ELEVATION ELECTRICAL ELEVATION OR ELEVATOR ELECTRICAL PANEL EQUAL	GYP. GLB. HC H.M. H.B. HORIZ.	FLOOR SINK FOOT/FEET FURRING FOOTING  GAUGE GALVANIZED GRAB BAR GROUND FAULT CIRCUIT INTERRUPT GLASS GLASS REINFORCED GYPSUM GLAZED MASONRY UNIT GYPSUM GLUE LAM BEAM  HANDICAP HOLLOW METAL HOSE BIB HORIZONTAL	MAG. MAX. M.B. MECH. MFR. MTL. MIN. MISC. M.O. M.S. MT. M.R.  N.I.C. NO. NOM. N.T.S. N.D.	MAGNETIC MAXIMUM MARKER BOARD MECHANICAL MANUFACTURER METAL MINIMUM MISCELLANEOUS MASONRY OPENING MOP SINK MOUNT MAP RAIL NOT IN CONTRACT NUMBER NOMINAL NOT TO SCALE SANITARY NAPKIN DISPOSAL	RM. R.O. S SD. S.C.D. SHR. SHT. SHTHG. S.N. SIM. ST. STL. STD. STL. STOR. SUSP. SYS.	ROOM ROUGH OPENING  INTERCOM SYSTEM SPEAKER SOAP DISPENSER OR SMOKE DETECTOR SEAT COVER DISPENSER SHOWER SHEET SHEATHING SANITARY NAPKIN DISPENSER SIMILAR STAINLESS STEEL STANDARD STEEL STORAGE SUSPENDED SYSTEM
ARCH. BRD. BLDG. BLK. BLKG. B.O. BM. BRG.	ARCHITECT  BOARD  BUILDING  BLOCK  BLOCKING  BOTTOM OF  BEAM  BEARING	EQUIP. E.W. E.W.C. EXIST. EXT.  F.D. F.EXT. F.E.C. F.HY.	EQUIPMENT EACH WAY ELECTRICAL WATER COOLER EXISTING EXTERIOR  FLOOR DRAIN FIRE EXTINGUISHER FIRE EXTINGUISHER CABINET FIRE HYDRANT	HGT.  I.D. INSUL. INT. INV. IRRIG.	HEIGHT  INSIDE DIAMETER/DIMENSION INSULATION INTERIOR INVERT IRRIGATION INTERCOM SYSTEM STAFF PHONE	OCC. O.C. O.D. O.F. OFE O.I. OPP. O.S.	OCCUPANT(S) ON CENTER OVERFLOW DRAIN OWNER FURNISHED OFFICE OWNER INSTALLED OPPOSITE OCCUPANCY SENSOR	T.B. T.O. T.P.H. TV. TYP. U.O.N.	TACK BOARD TOP OF (SEE B.O.) TOILET PAPER HOLDER TELEVISION TYPICAL UNLESS OTHERWISE NOTED VISUAL STROBE
C CAB. C.B. CER. C.I. C.M.U. C.O. COL. CONC. CONSTR. CONT.	CLOCK CABINET CATCH BASIN CERAMIC CONTRACTOR INSTALLED CONCRETE MASONRY UNIT CLEANOUT COLUMN CONCRETE CONSTRUCTION CONTINUOUS	F.H.C. FIN. FLASH. FLUOR. FLR. F.O.C. F.O.F. F.O.M. F.O.S. F.R.P. FRT	FIRE HYDRANT FIRE HOSE CABINET FINISH/FINISHED FLASHING FLUORESCENT FLOOR FACE OF CONCRETE FACE OF FINISH FACE OF MASONRY FACE OF STUD FIBERGLASS REINFORCED PLASTIC FIRE RETARDANT TREATED	JAN.  KIT.  LAV.  LANDSC.  LAM.  LLH.  LLV.	JANITOR  KITCHEN  LAVATORY LANDSCAPING LAMINATED LONG LEG HORIZONTAL LONG LEG VERTICAL	P. LAM. PLAS. P.S. PLYWD. P.T.D. PREFIN. P.T.  RAD. R.D. REQ'D.	PLASTIC LAMINATE PLASTER PROJECTION SCREEN PLYWOOD PAPER TOWEL DISPENSER PREFINISHED PRESSURE TREATED  RADIUS ROOF DRAIN REQUIRED	V VAT VCT VERT. VEST.  W.F. WD. W.W.F. W/ W/O WDW.	VINYL ASBESTOS TILE VINYL COMPOSITION TILE VERTICAL VESTIBULE  WASH FOUNTAIN WOOD WELDED WIRE FABRIC WITH WITHOUT WINDOW

CONSULTANTS REVISIONS ALS BECISION KEY PLAN SHEET TITLE SITE PLAN, & GENERAL NOTES

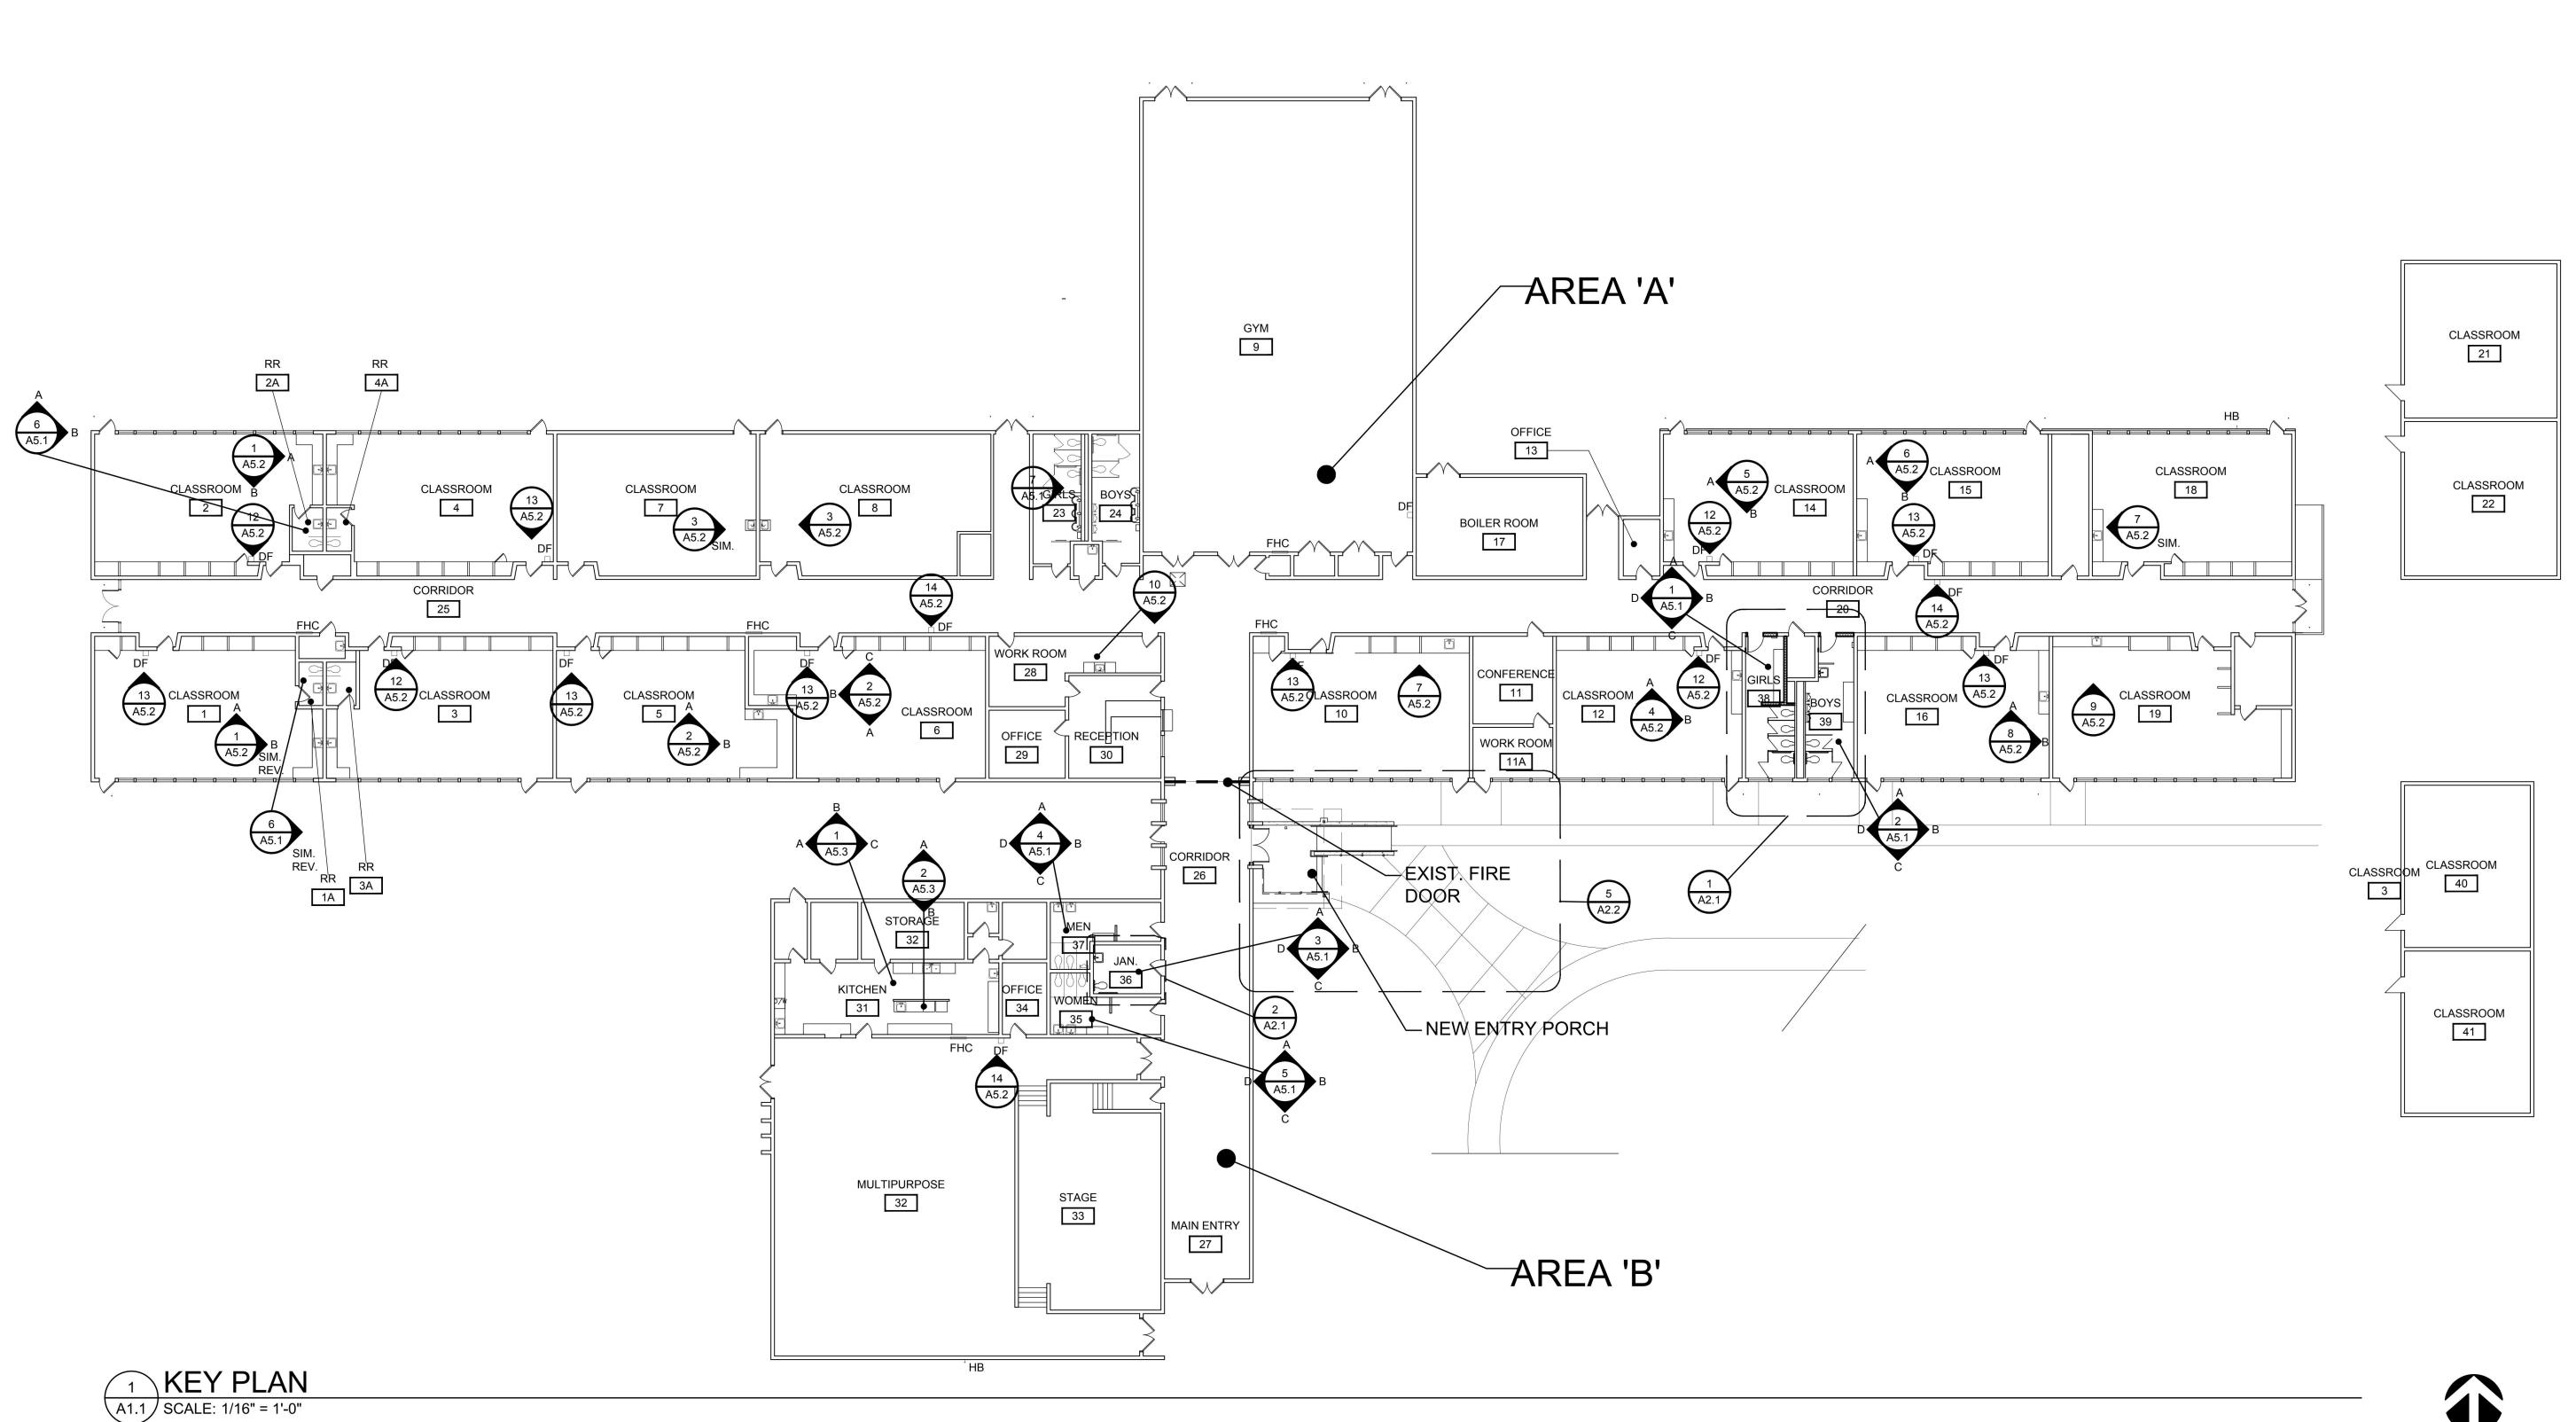


A1.1 2 of 9


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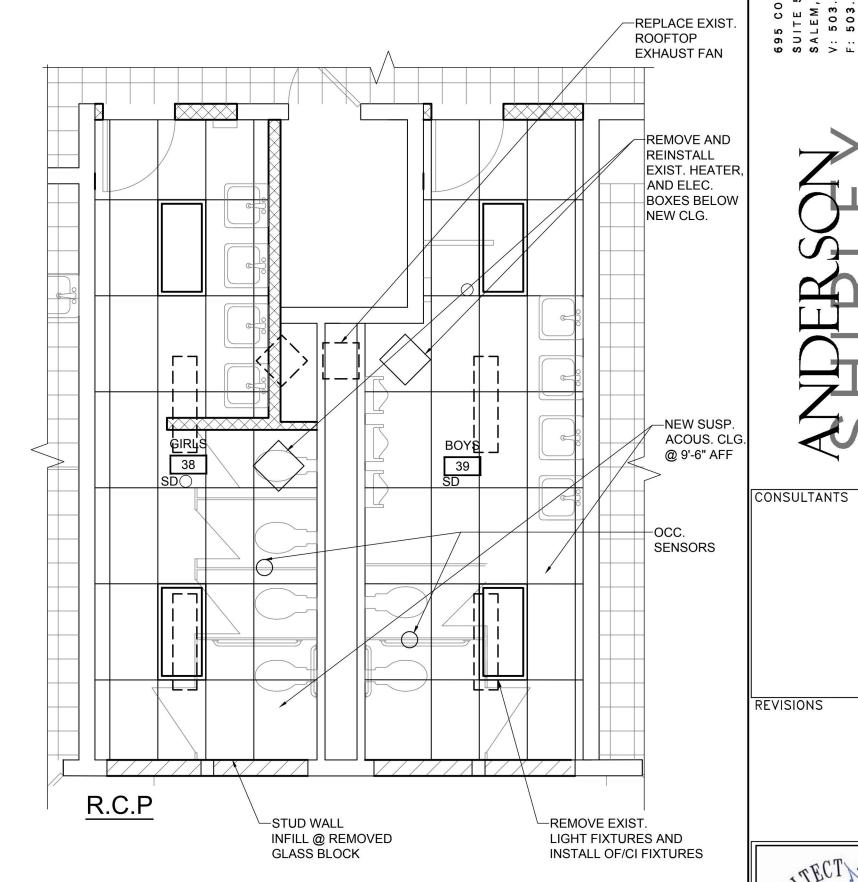
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SHEET TITLE





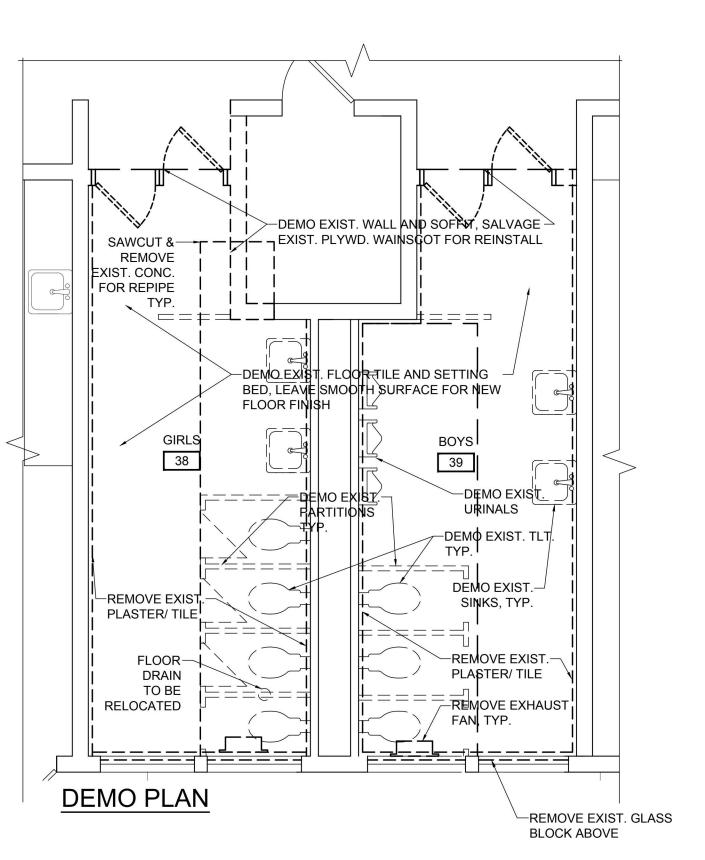



1 GIRLS 38 & BOYS 39 A2.1 SCALE: 1/4" = 1'-0"

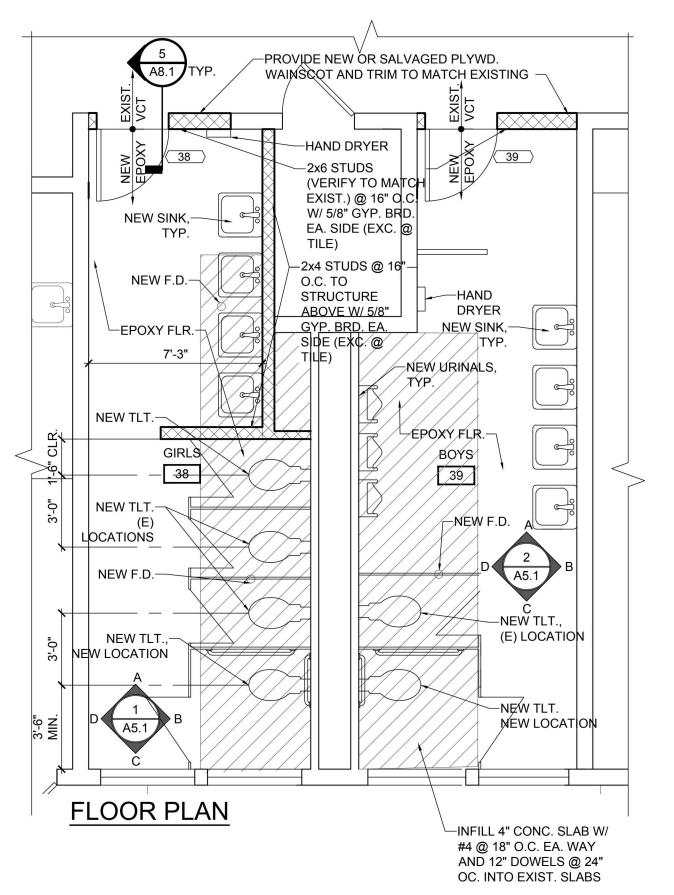



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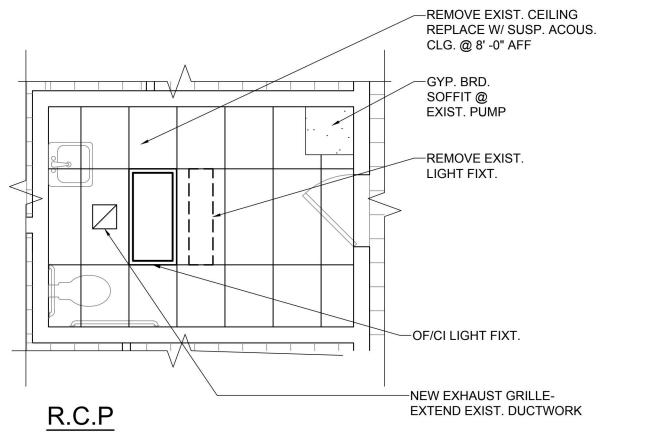
REMODEL CELEMENTARY



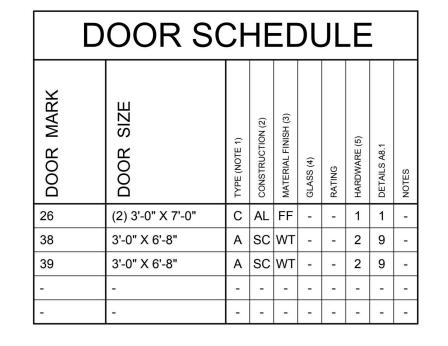

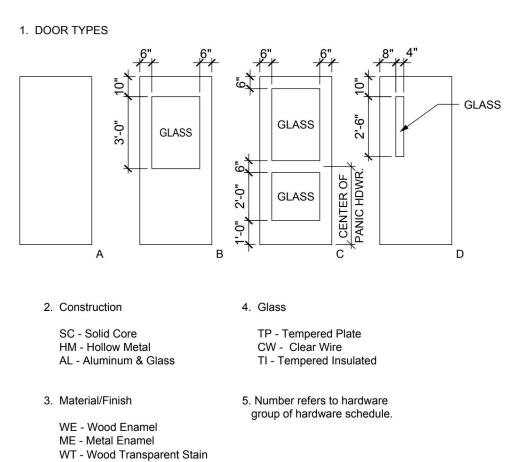

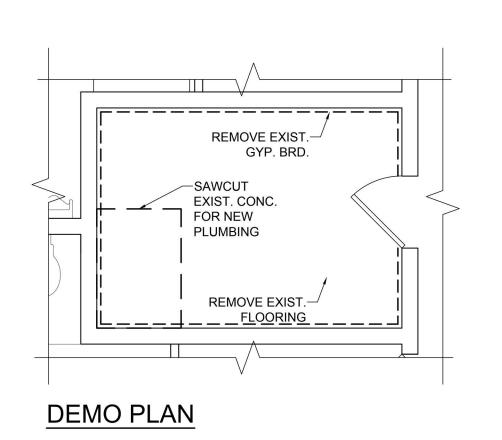

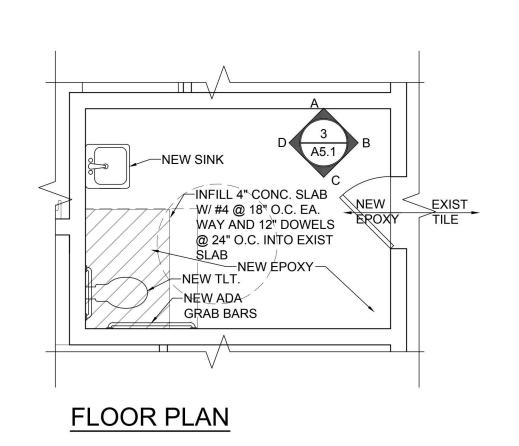

NEW RESTROOM A2.1 | SCALE: 1/4" = 1'-0"




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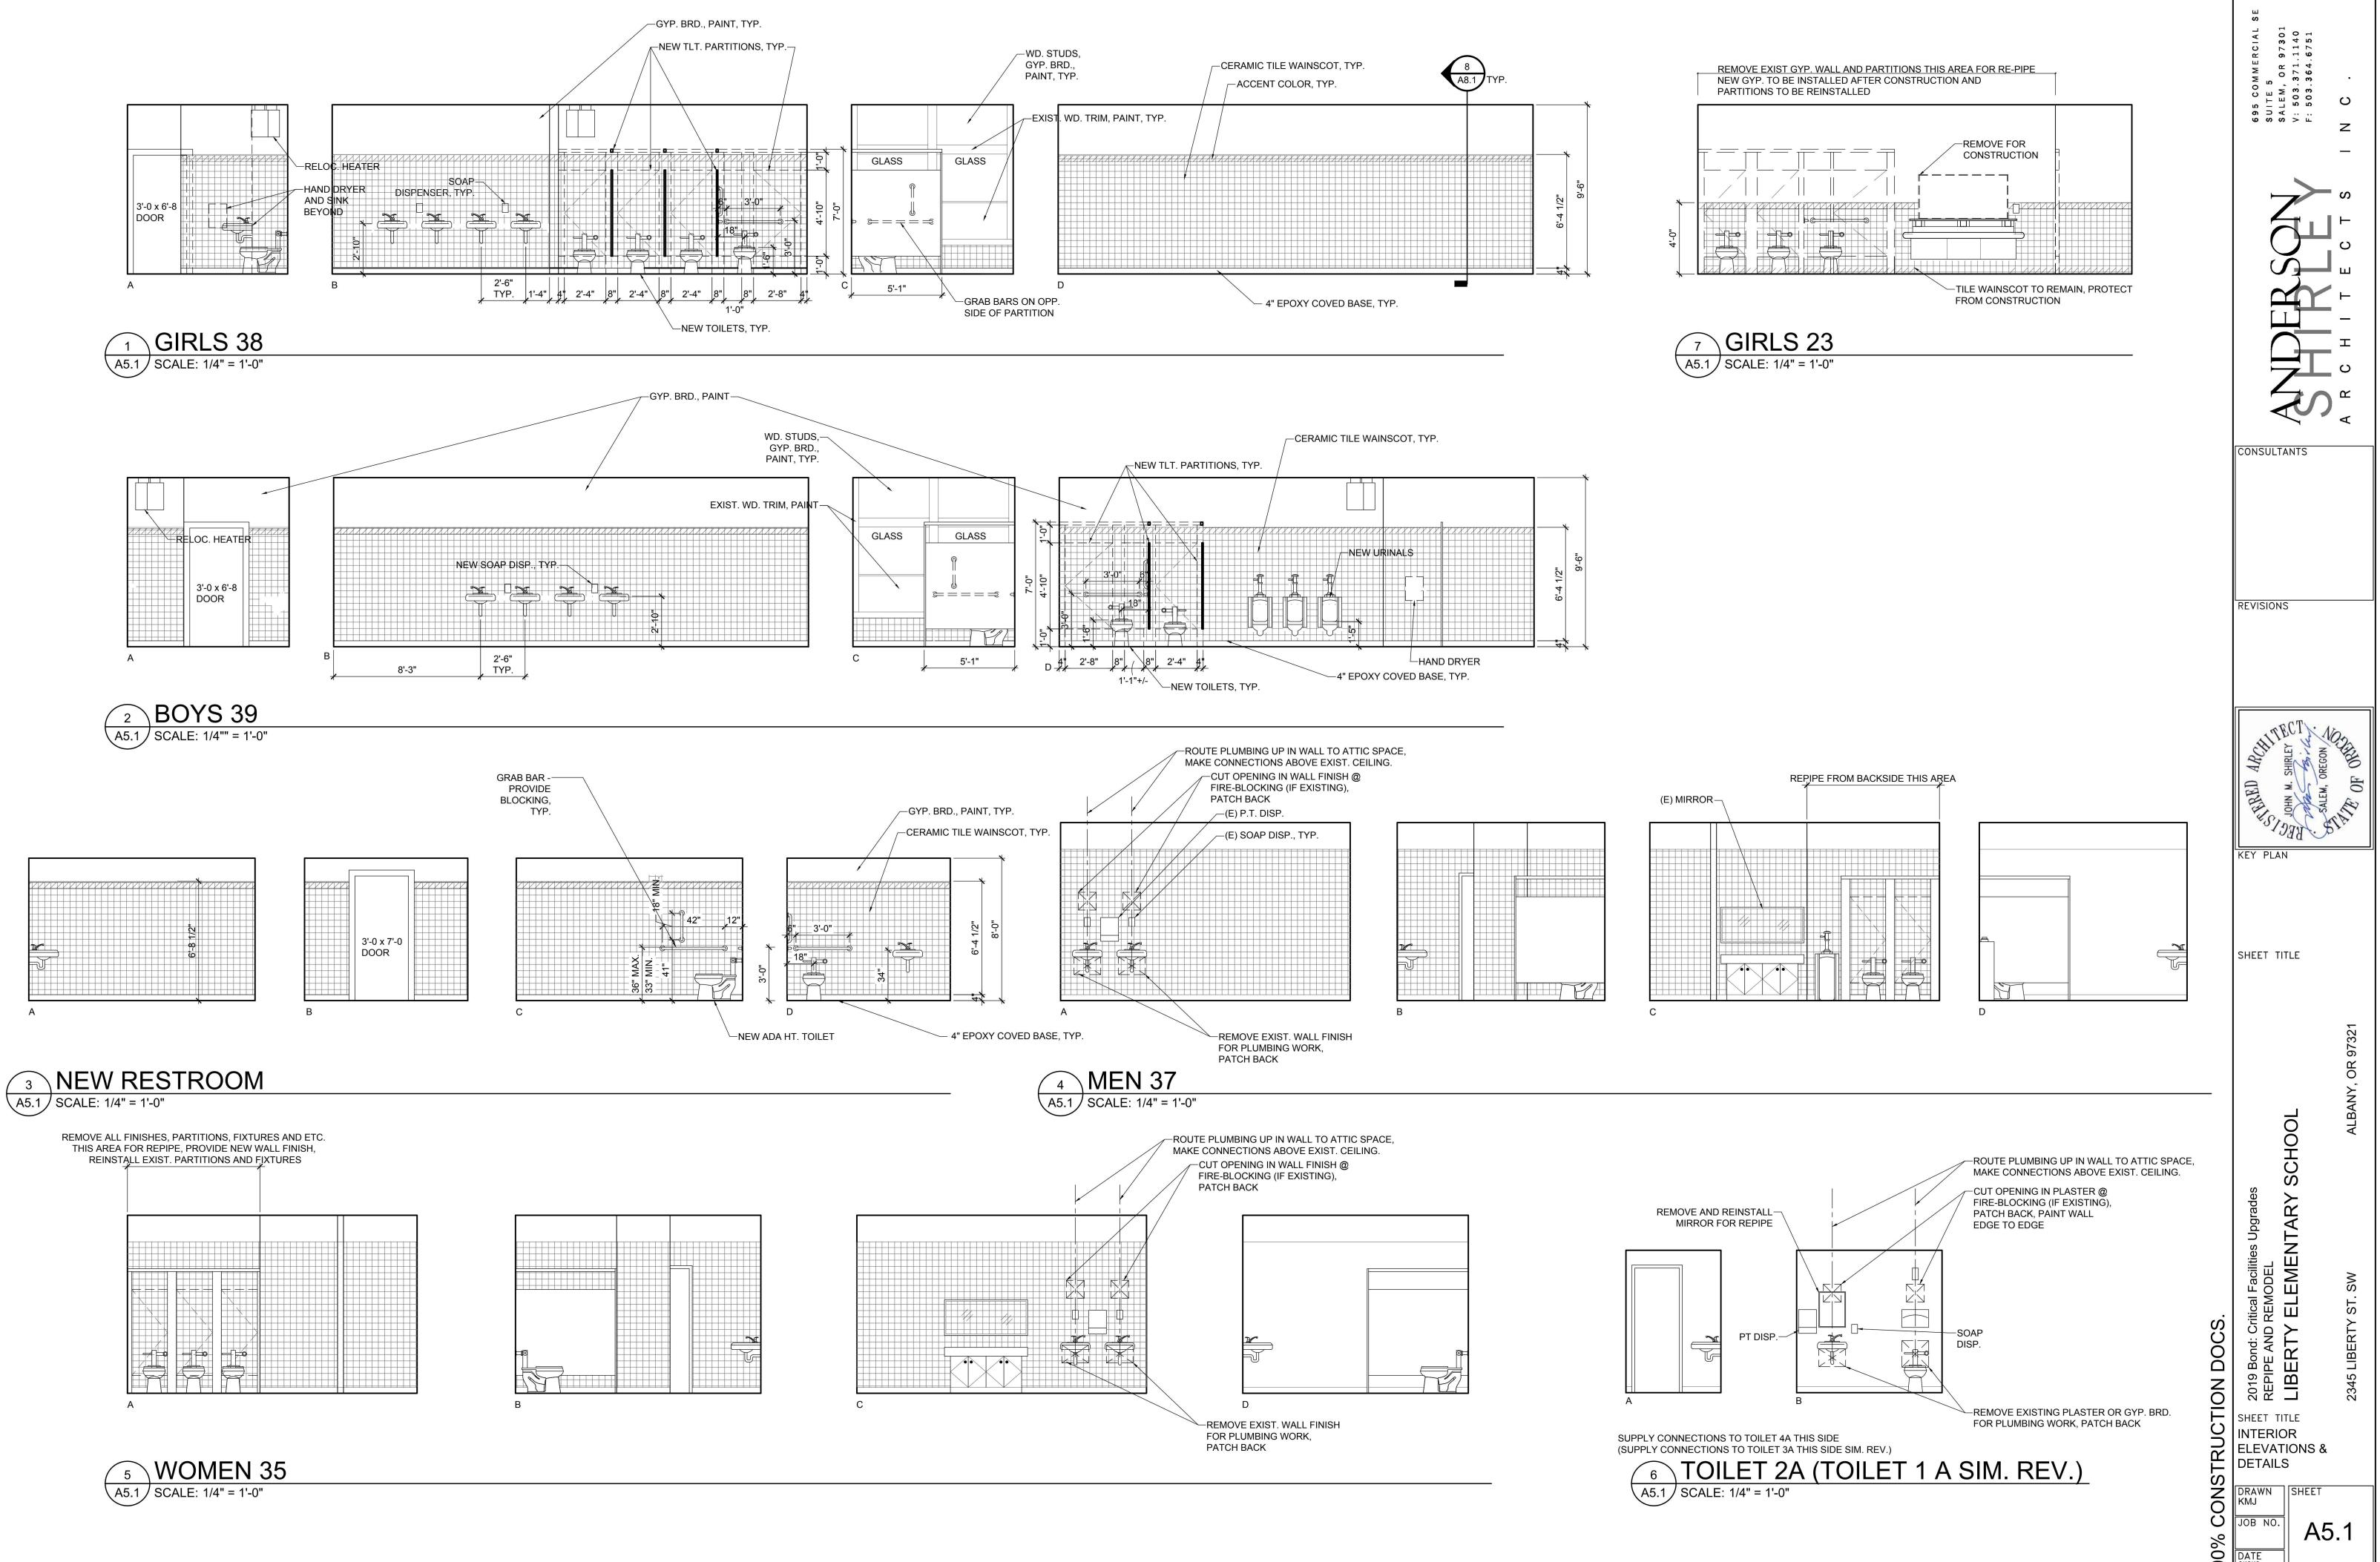
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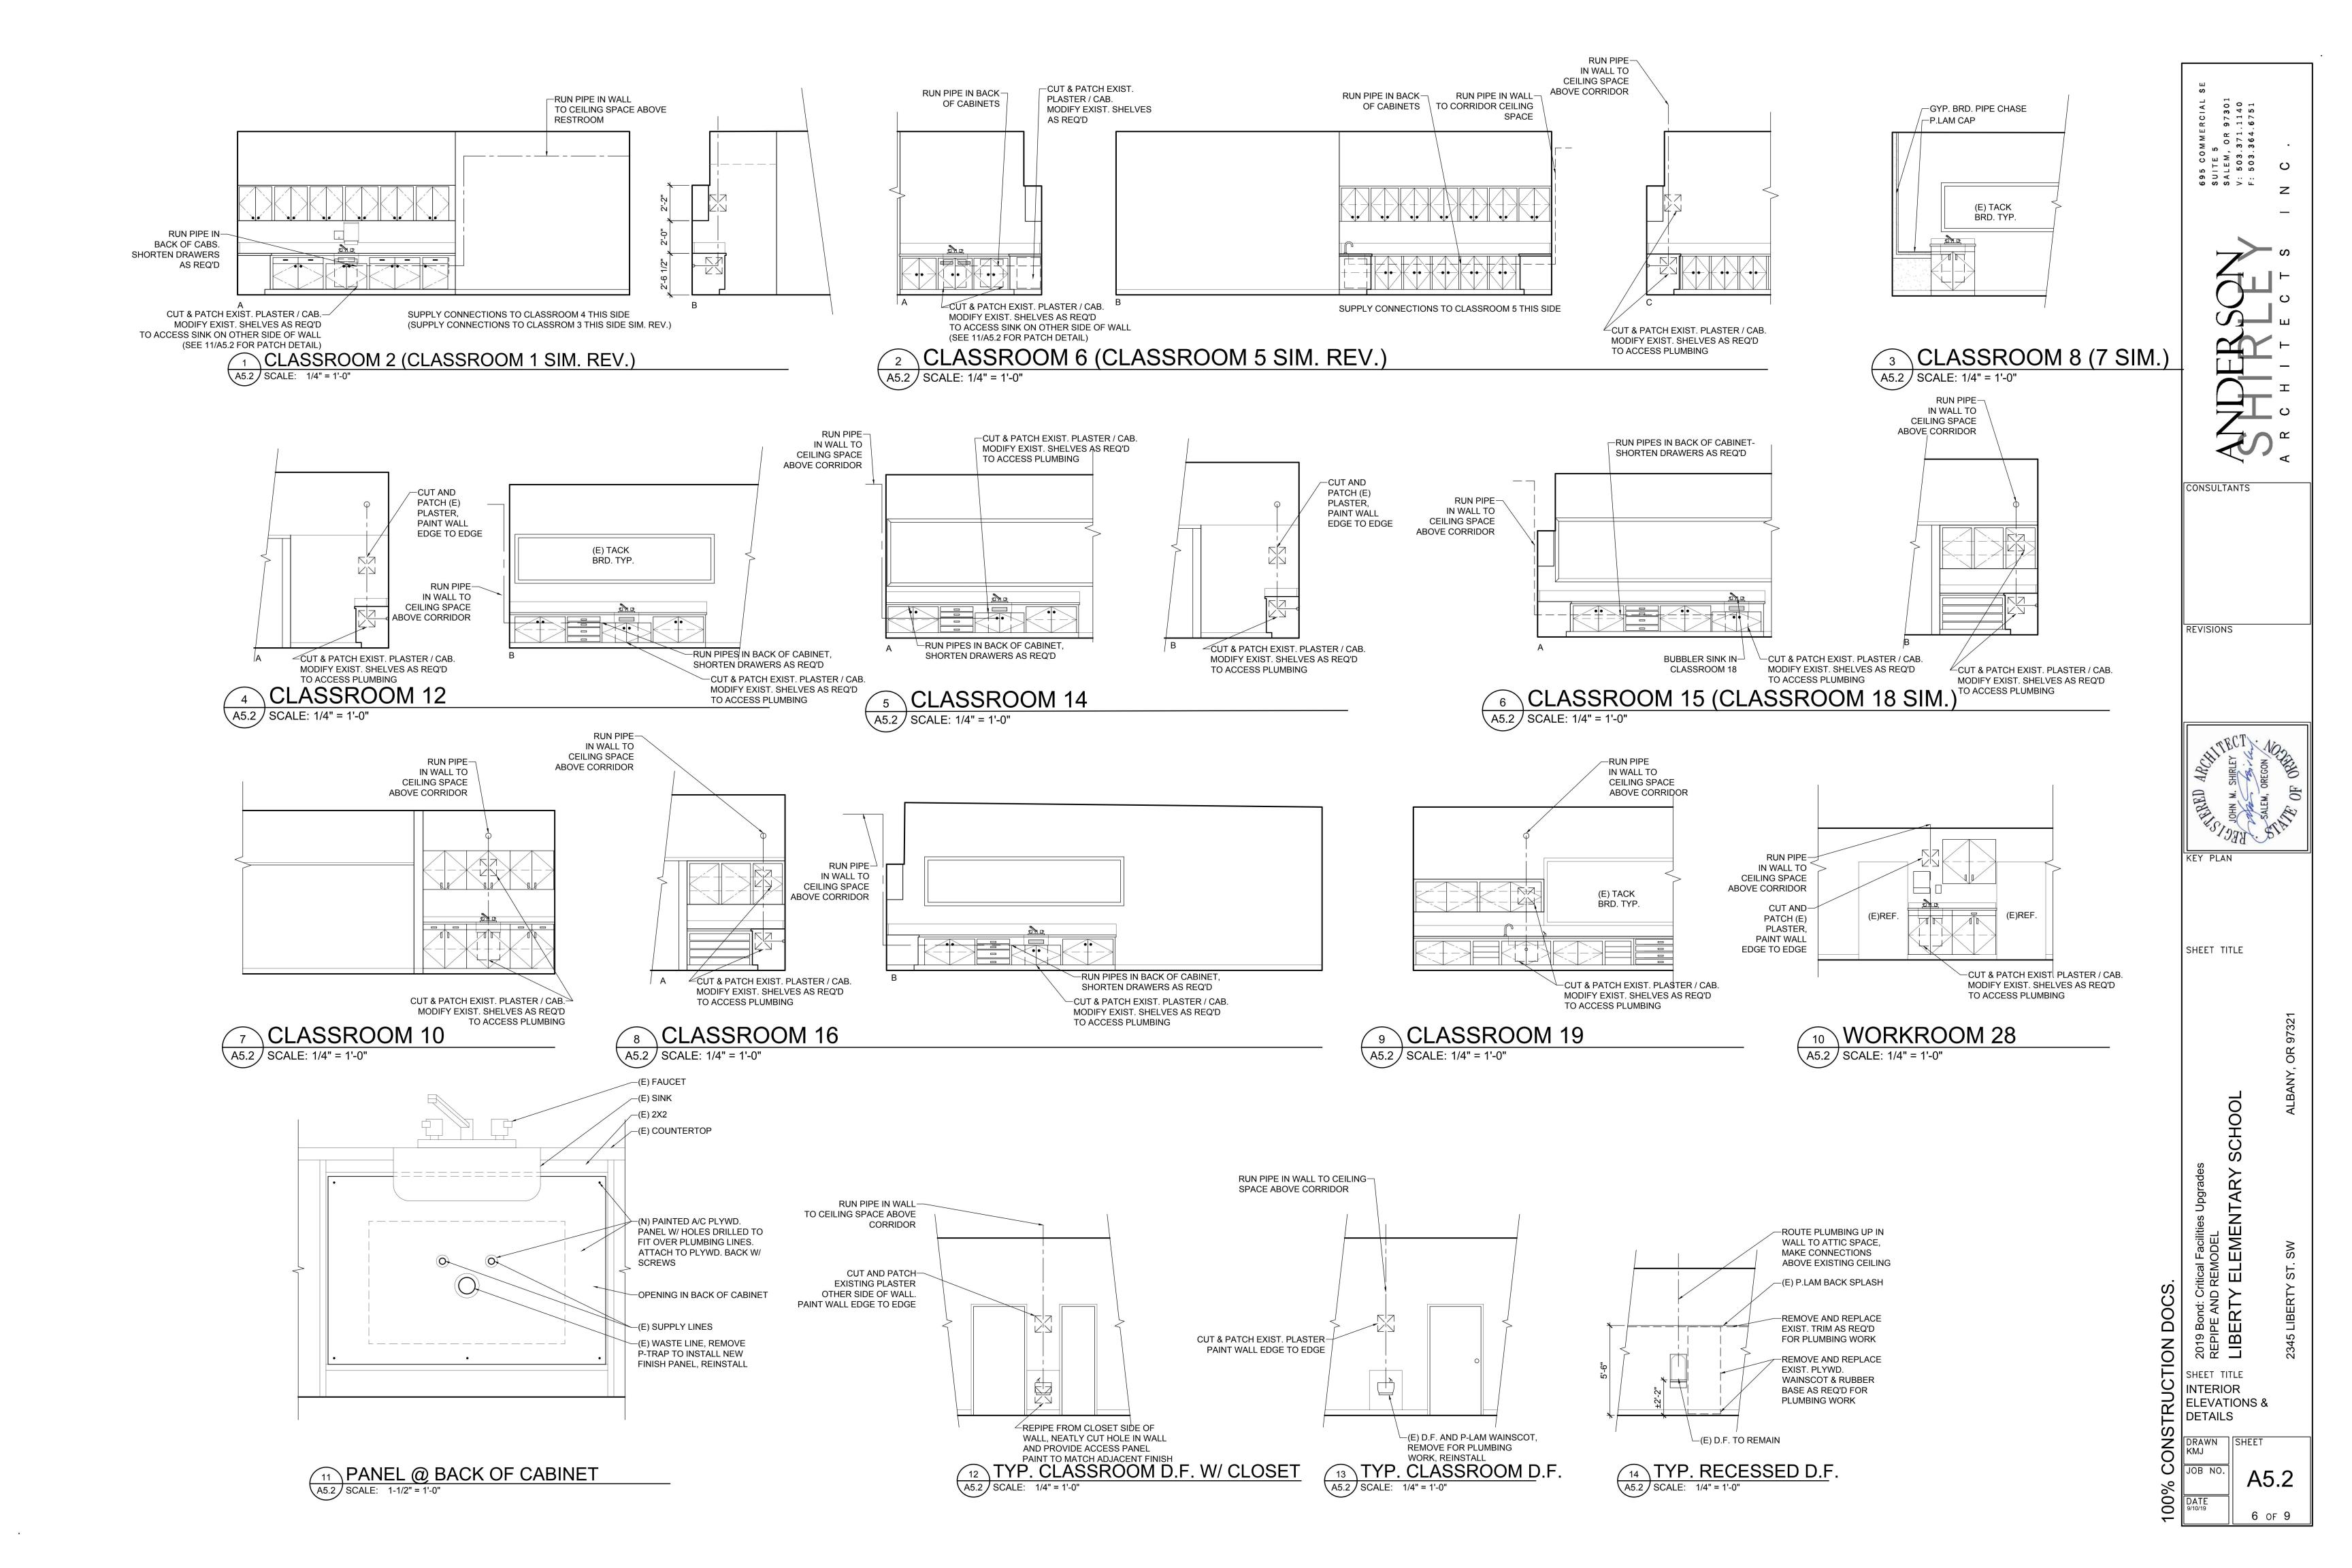
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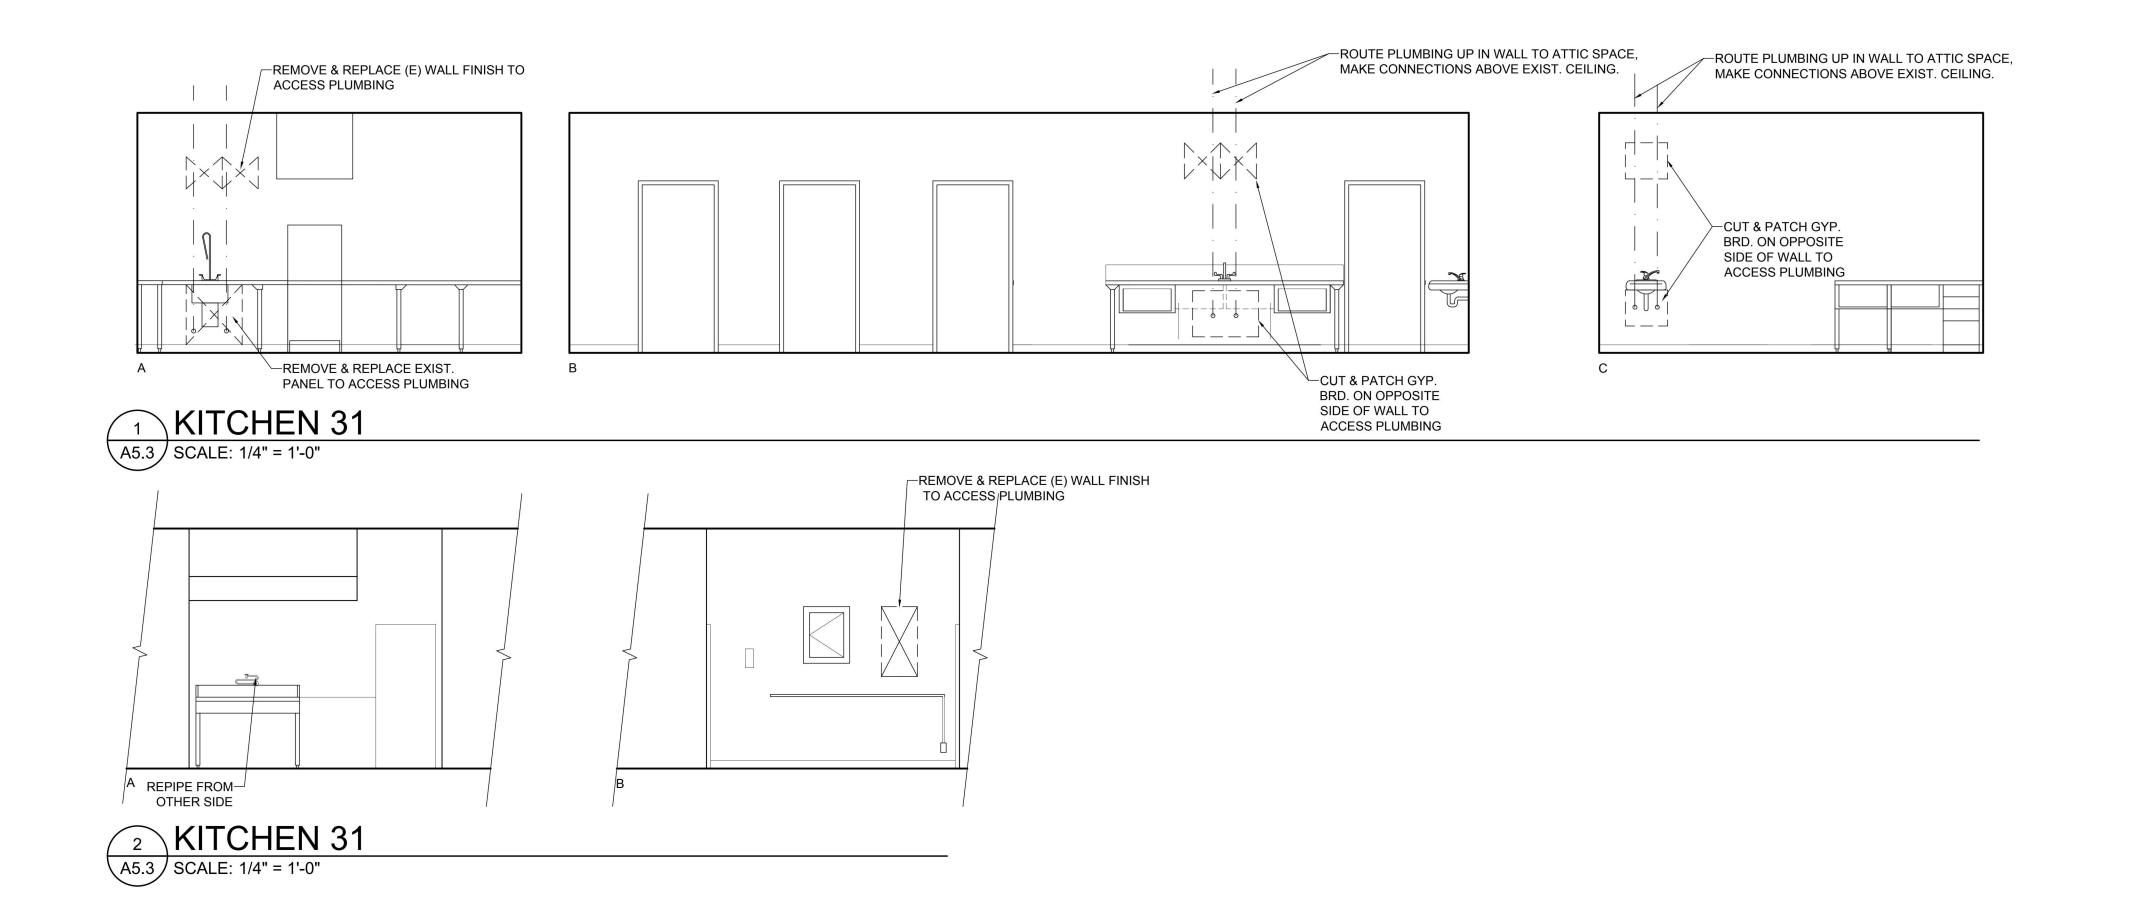
CONSTRUCTION DOCS.

A MARAD A MARA FLOOR PLANS & REFLECTED CEILING








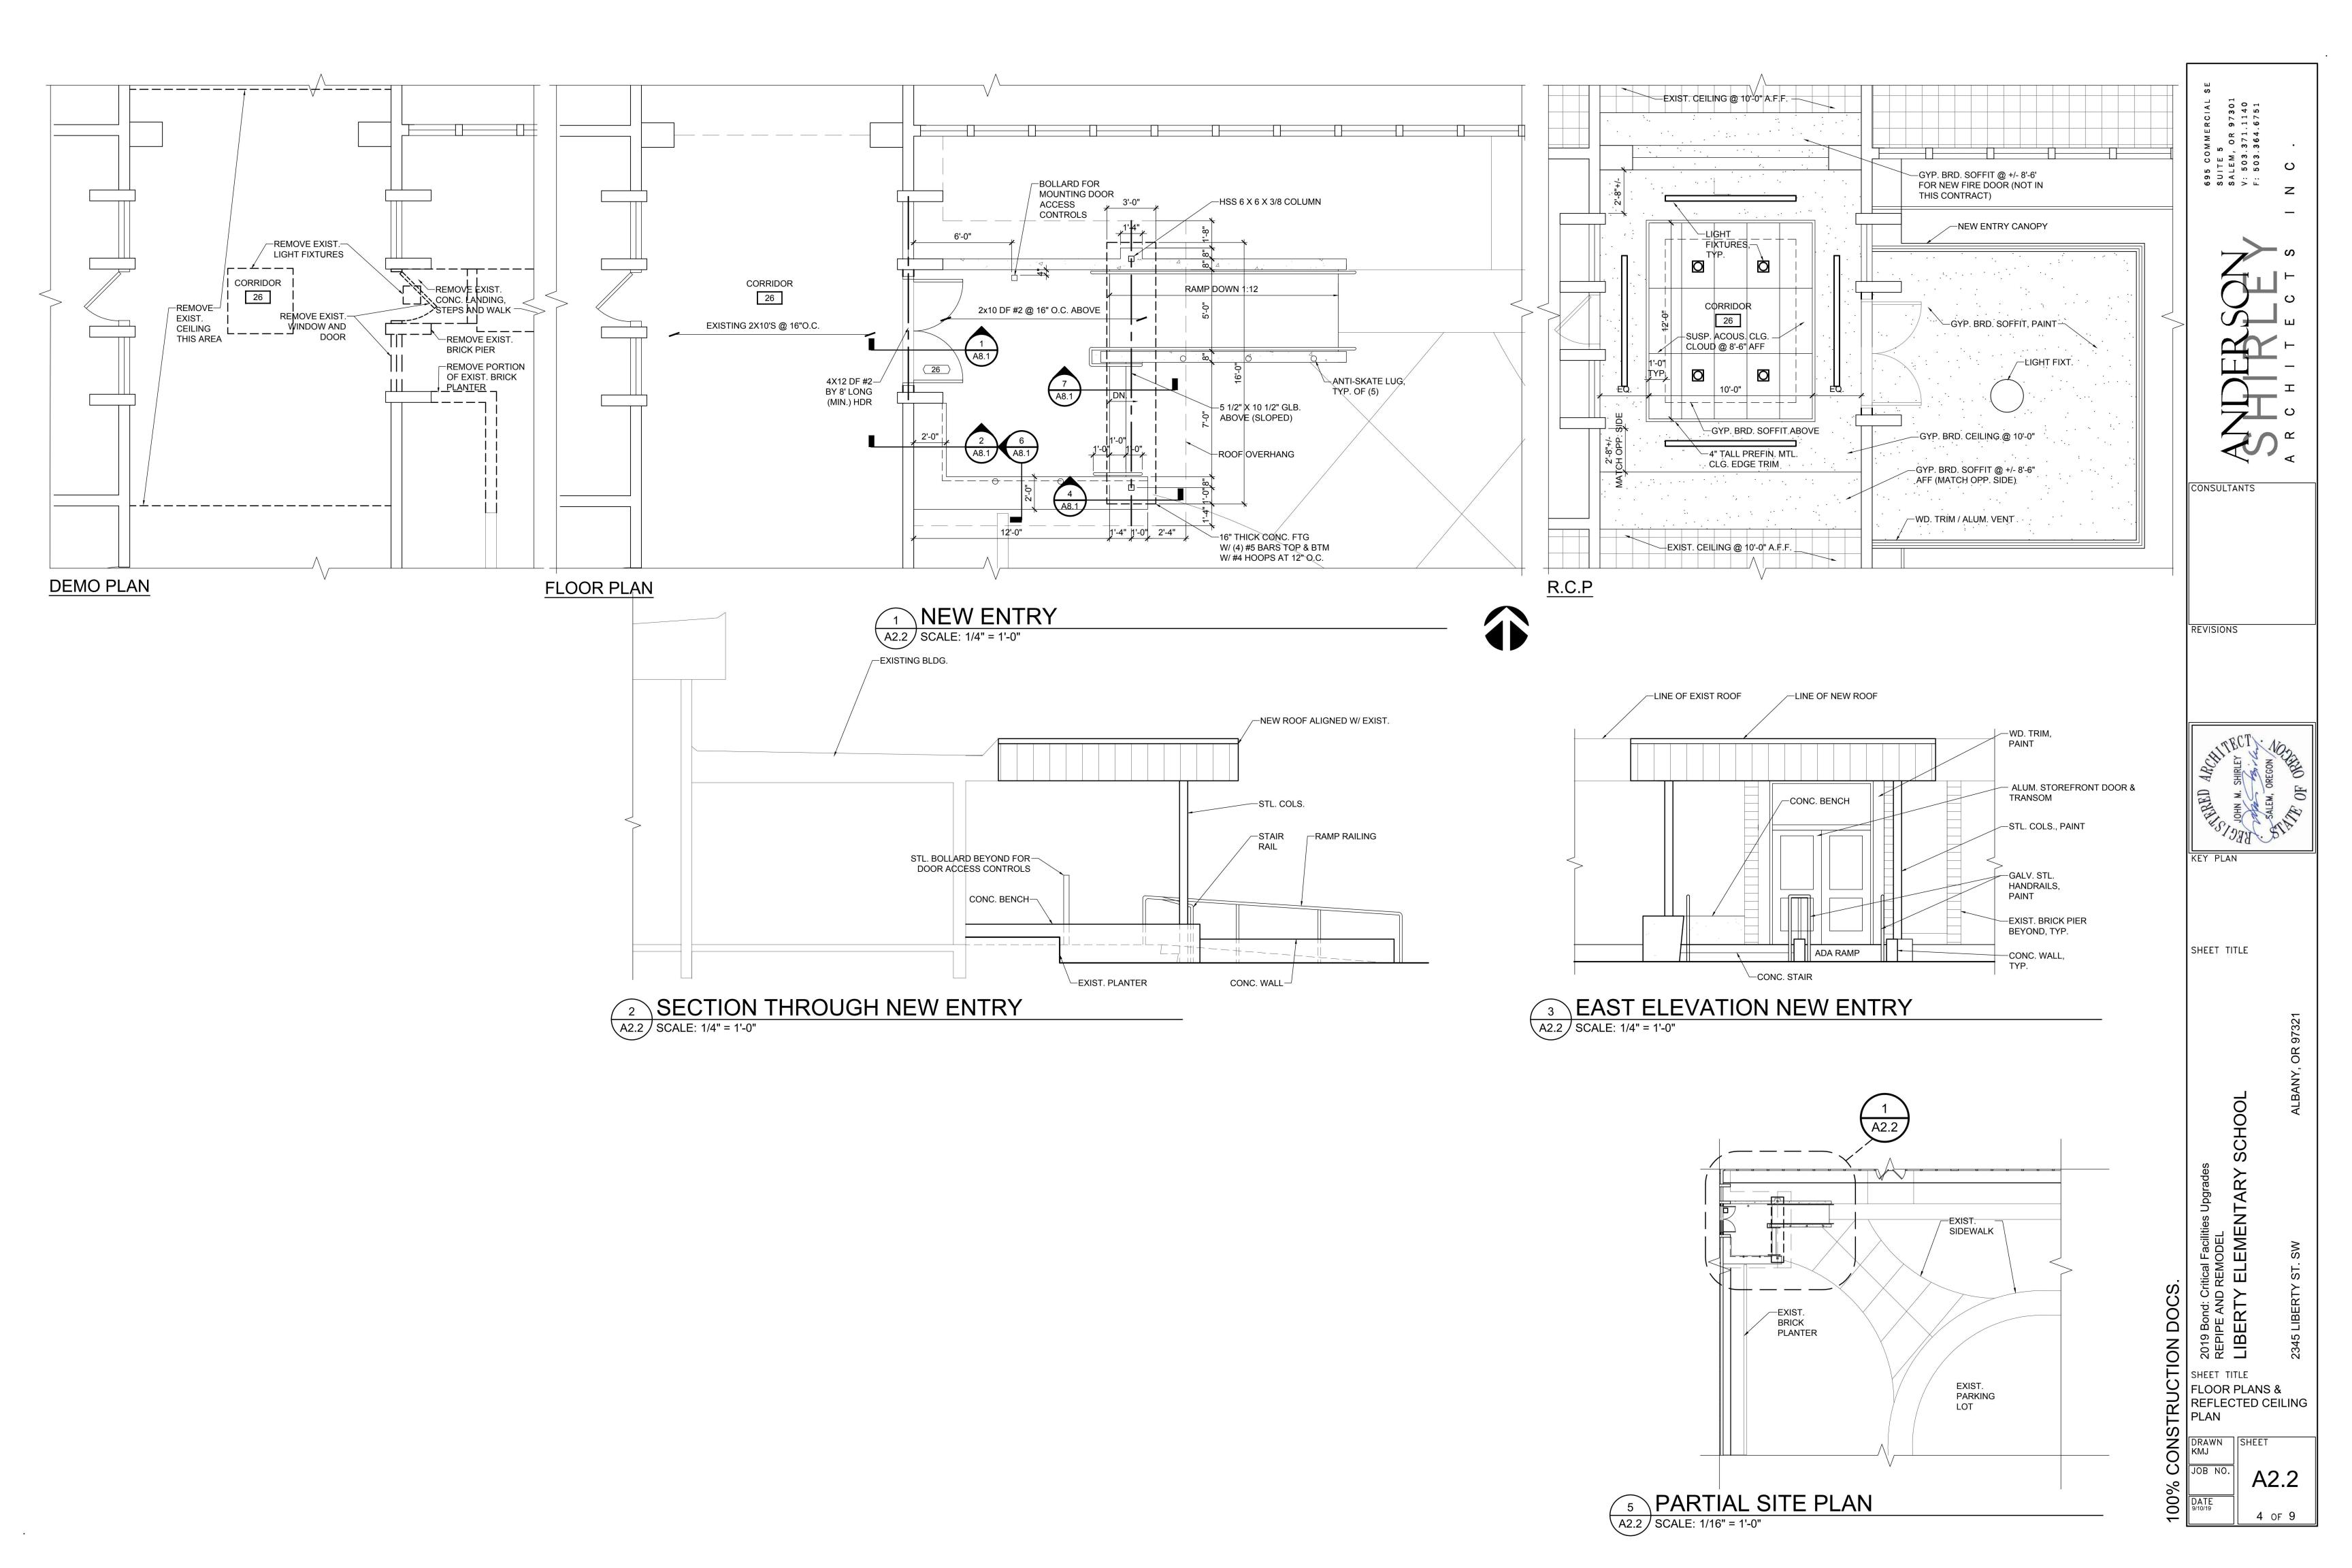


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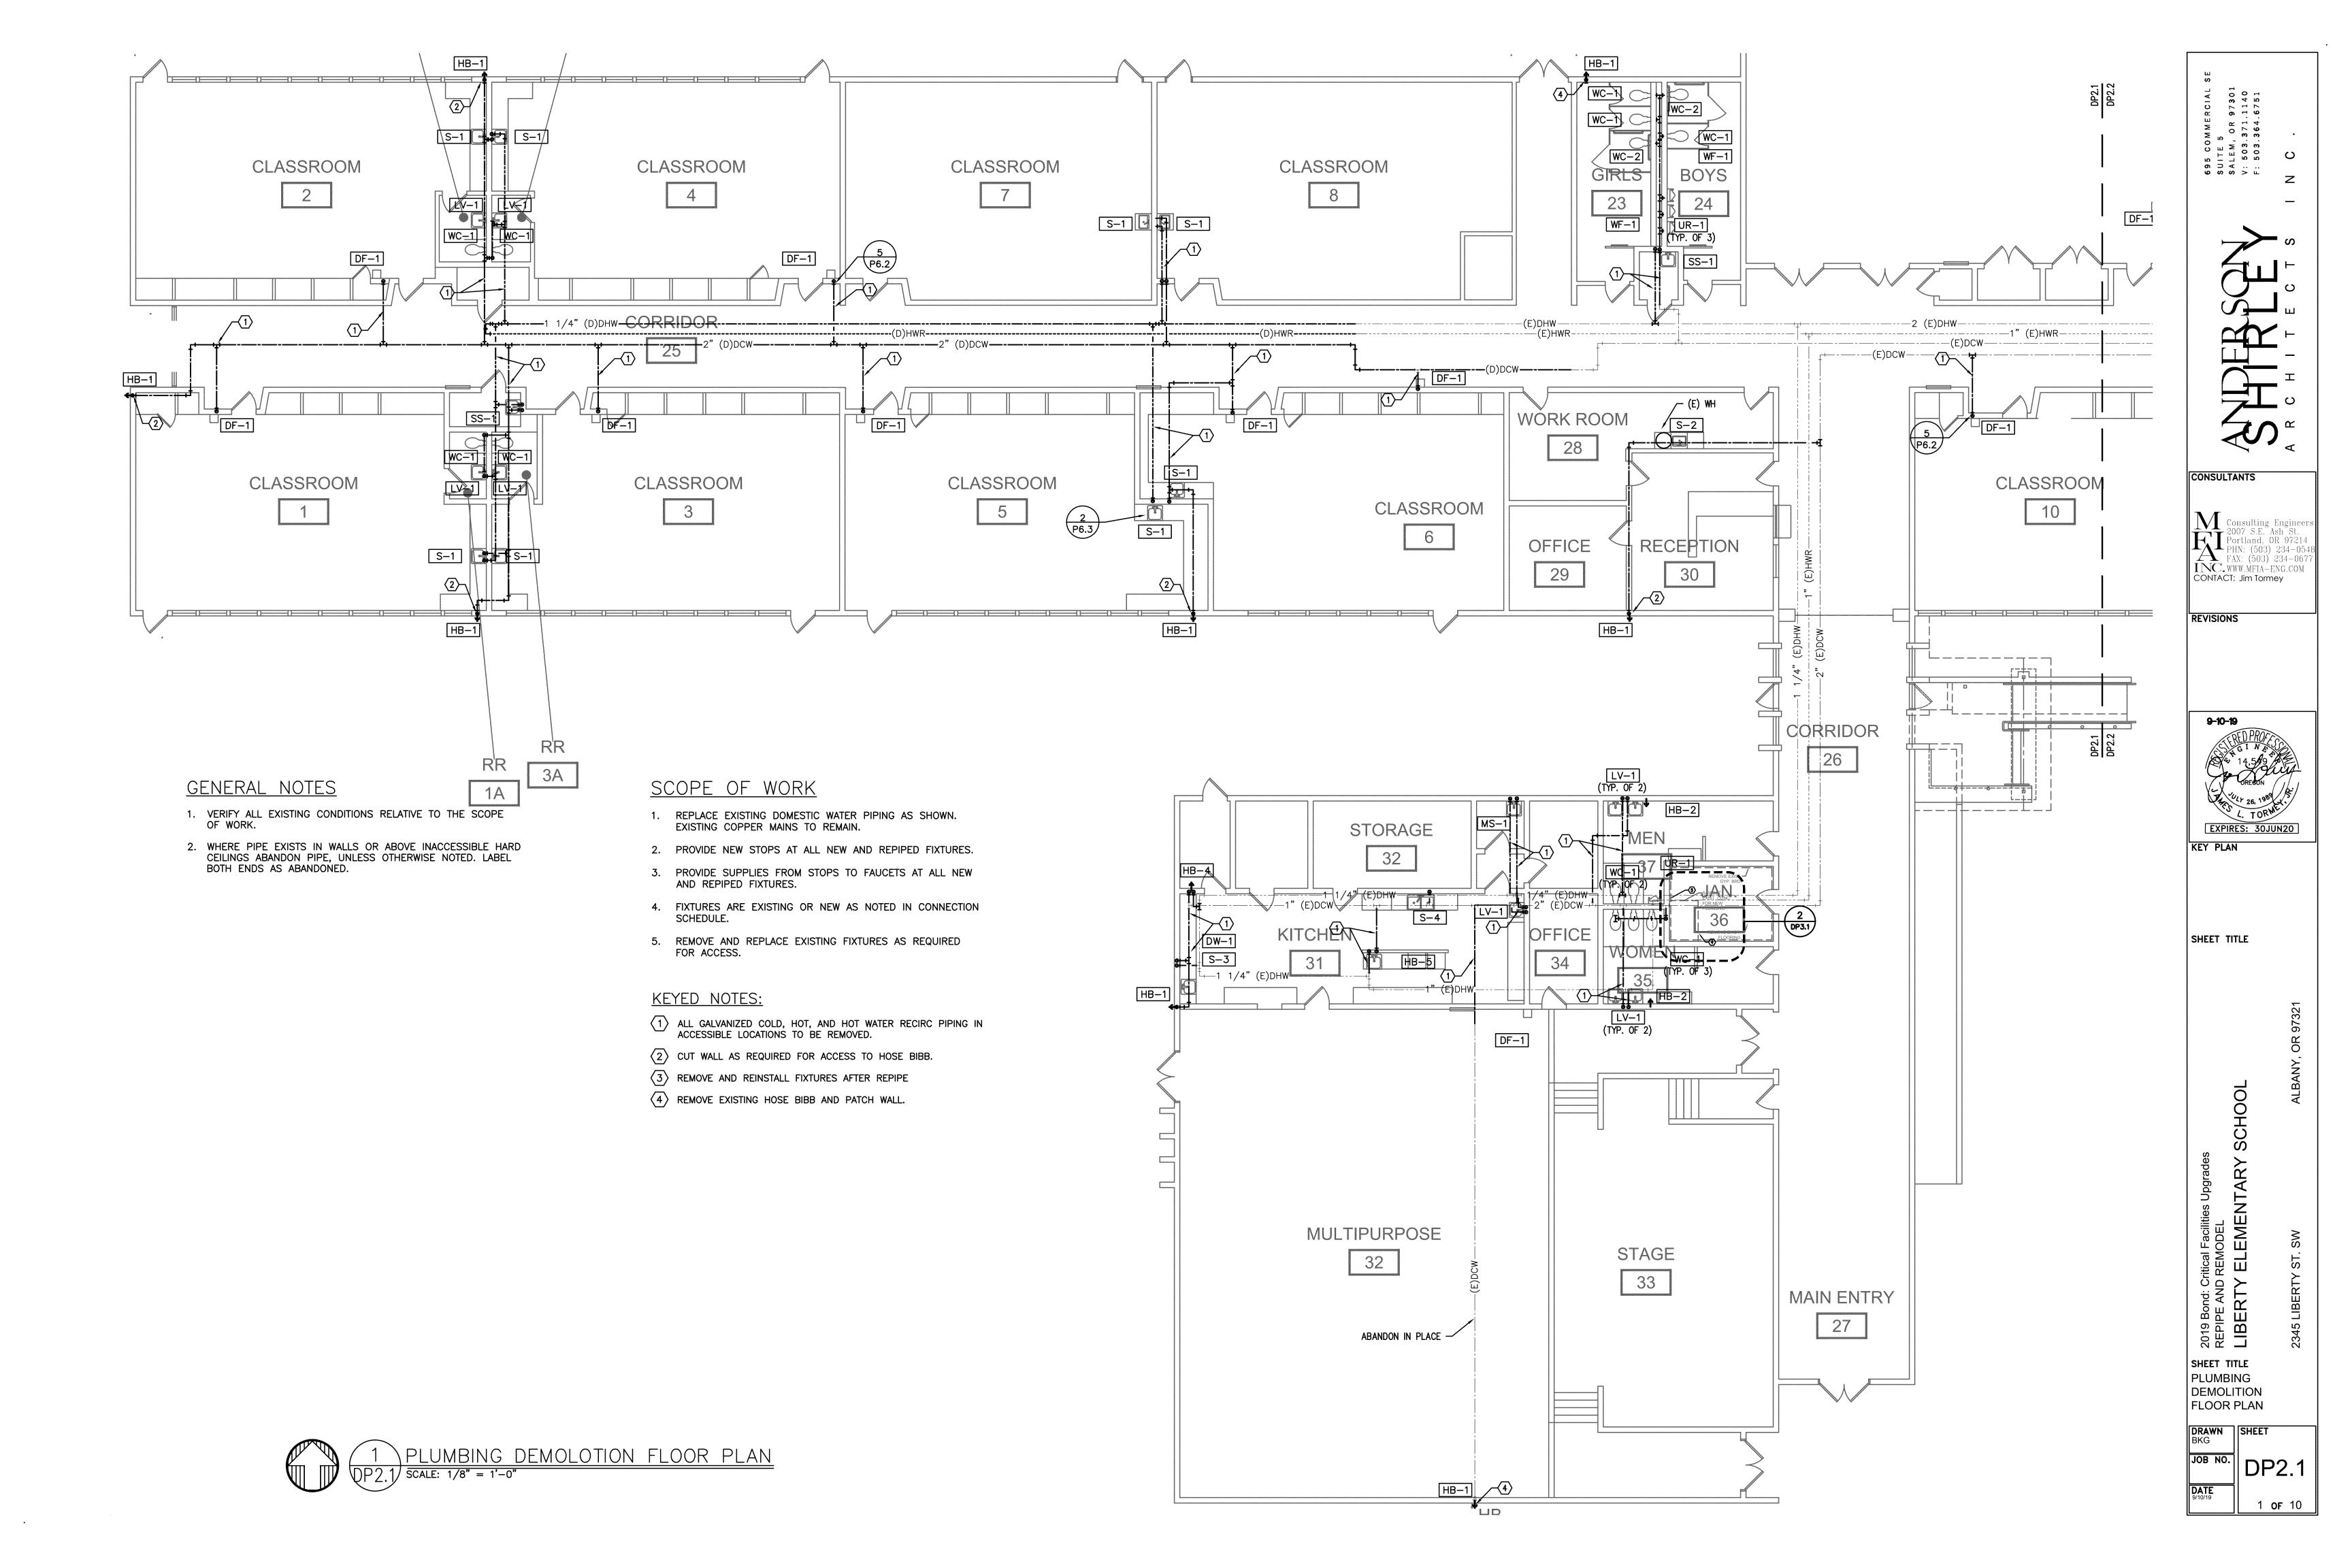
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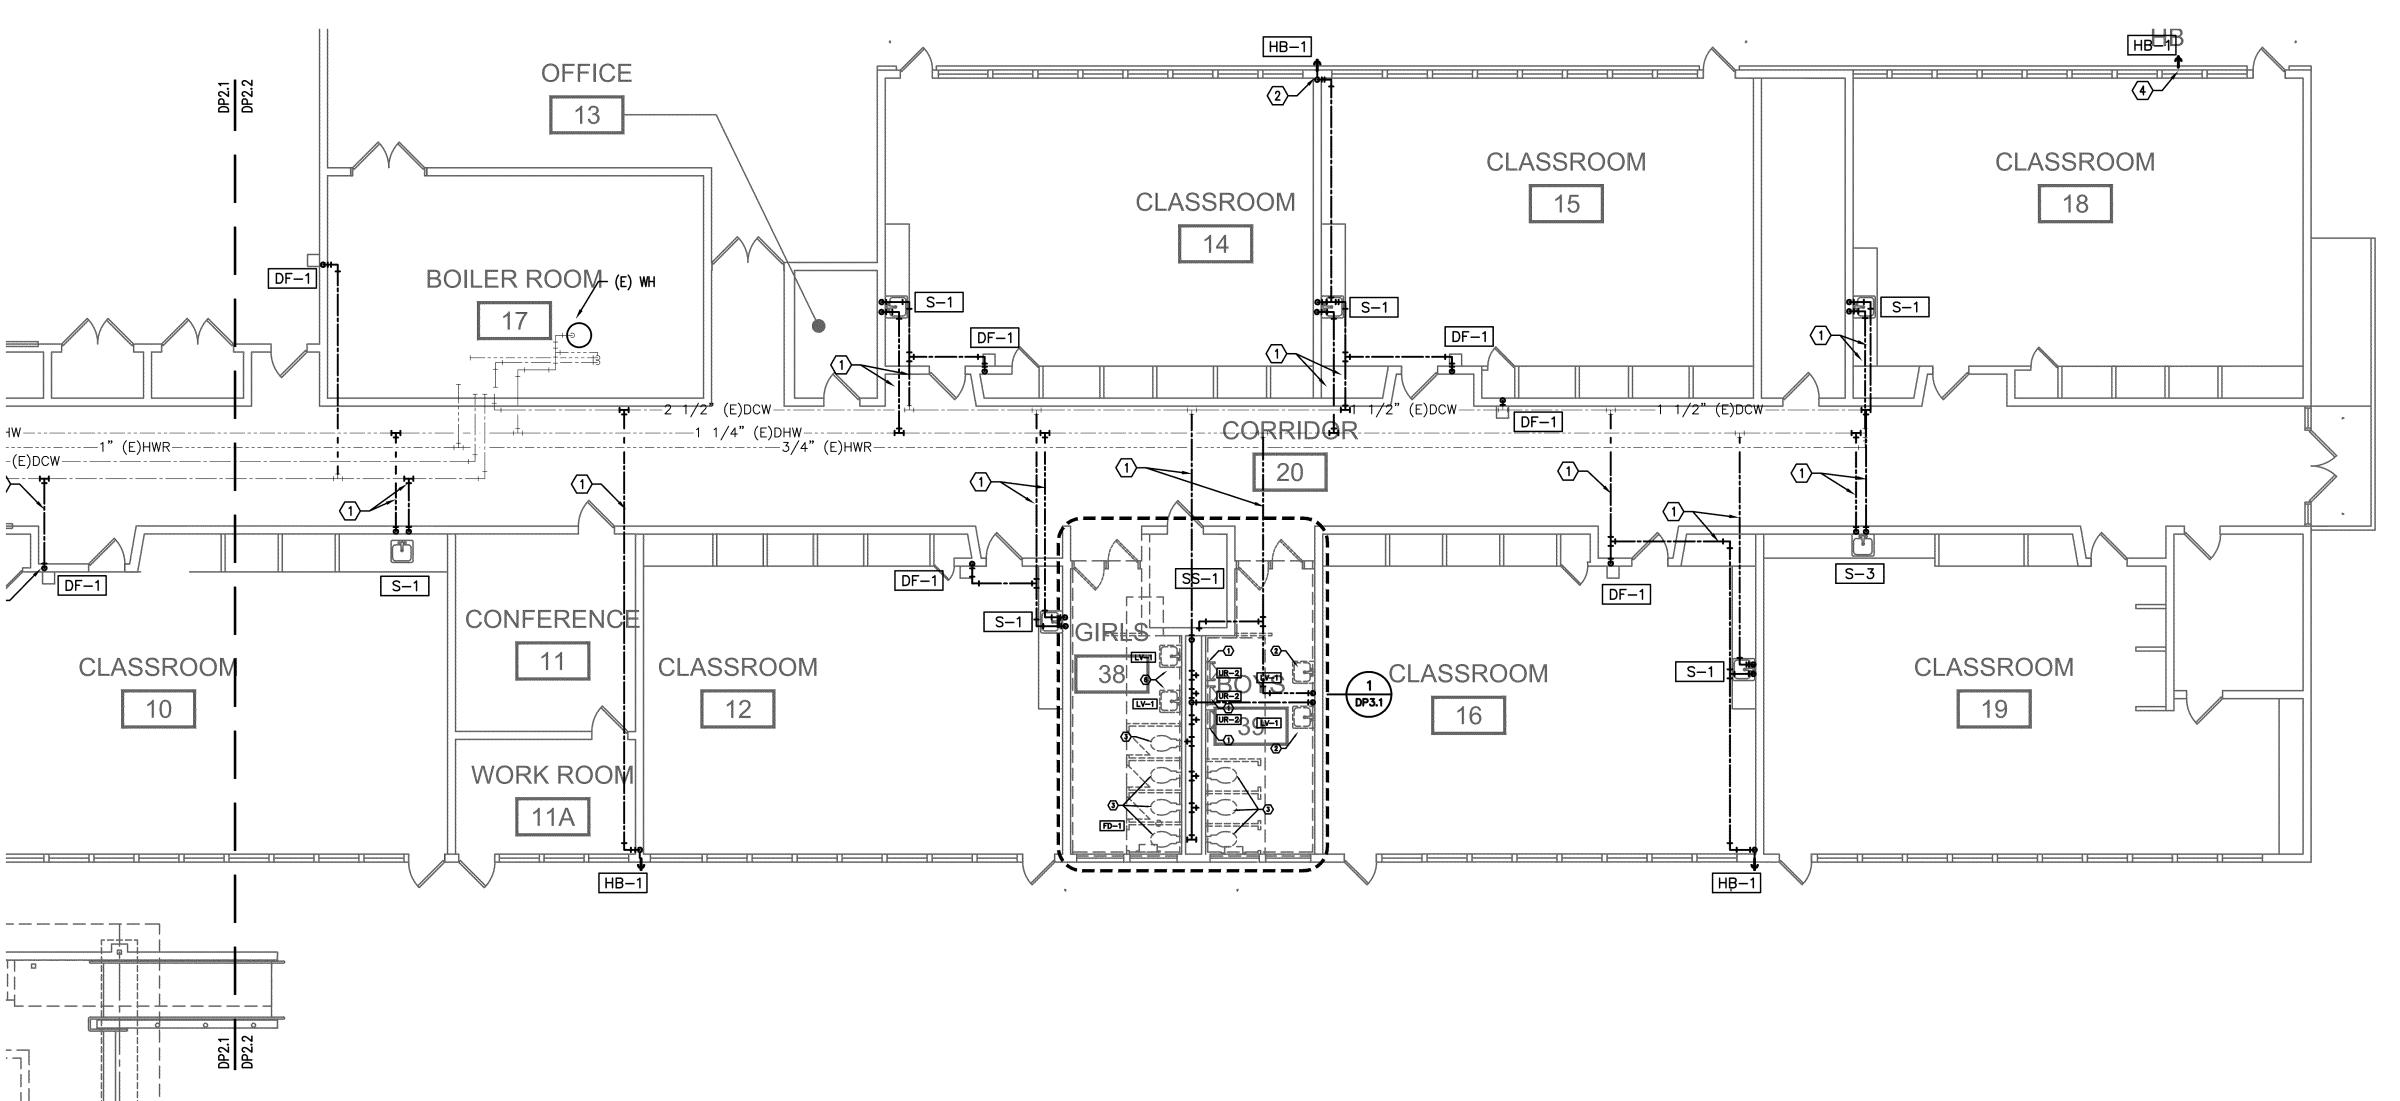
A5.3



A6.1 8 of 9

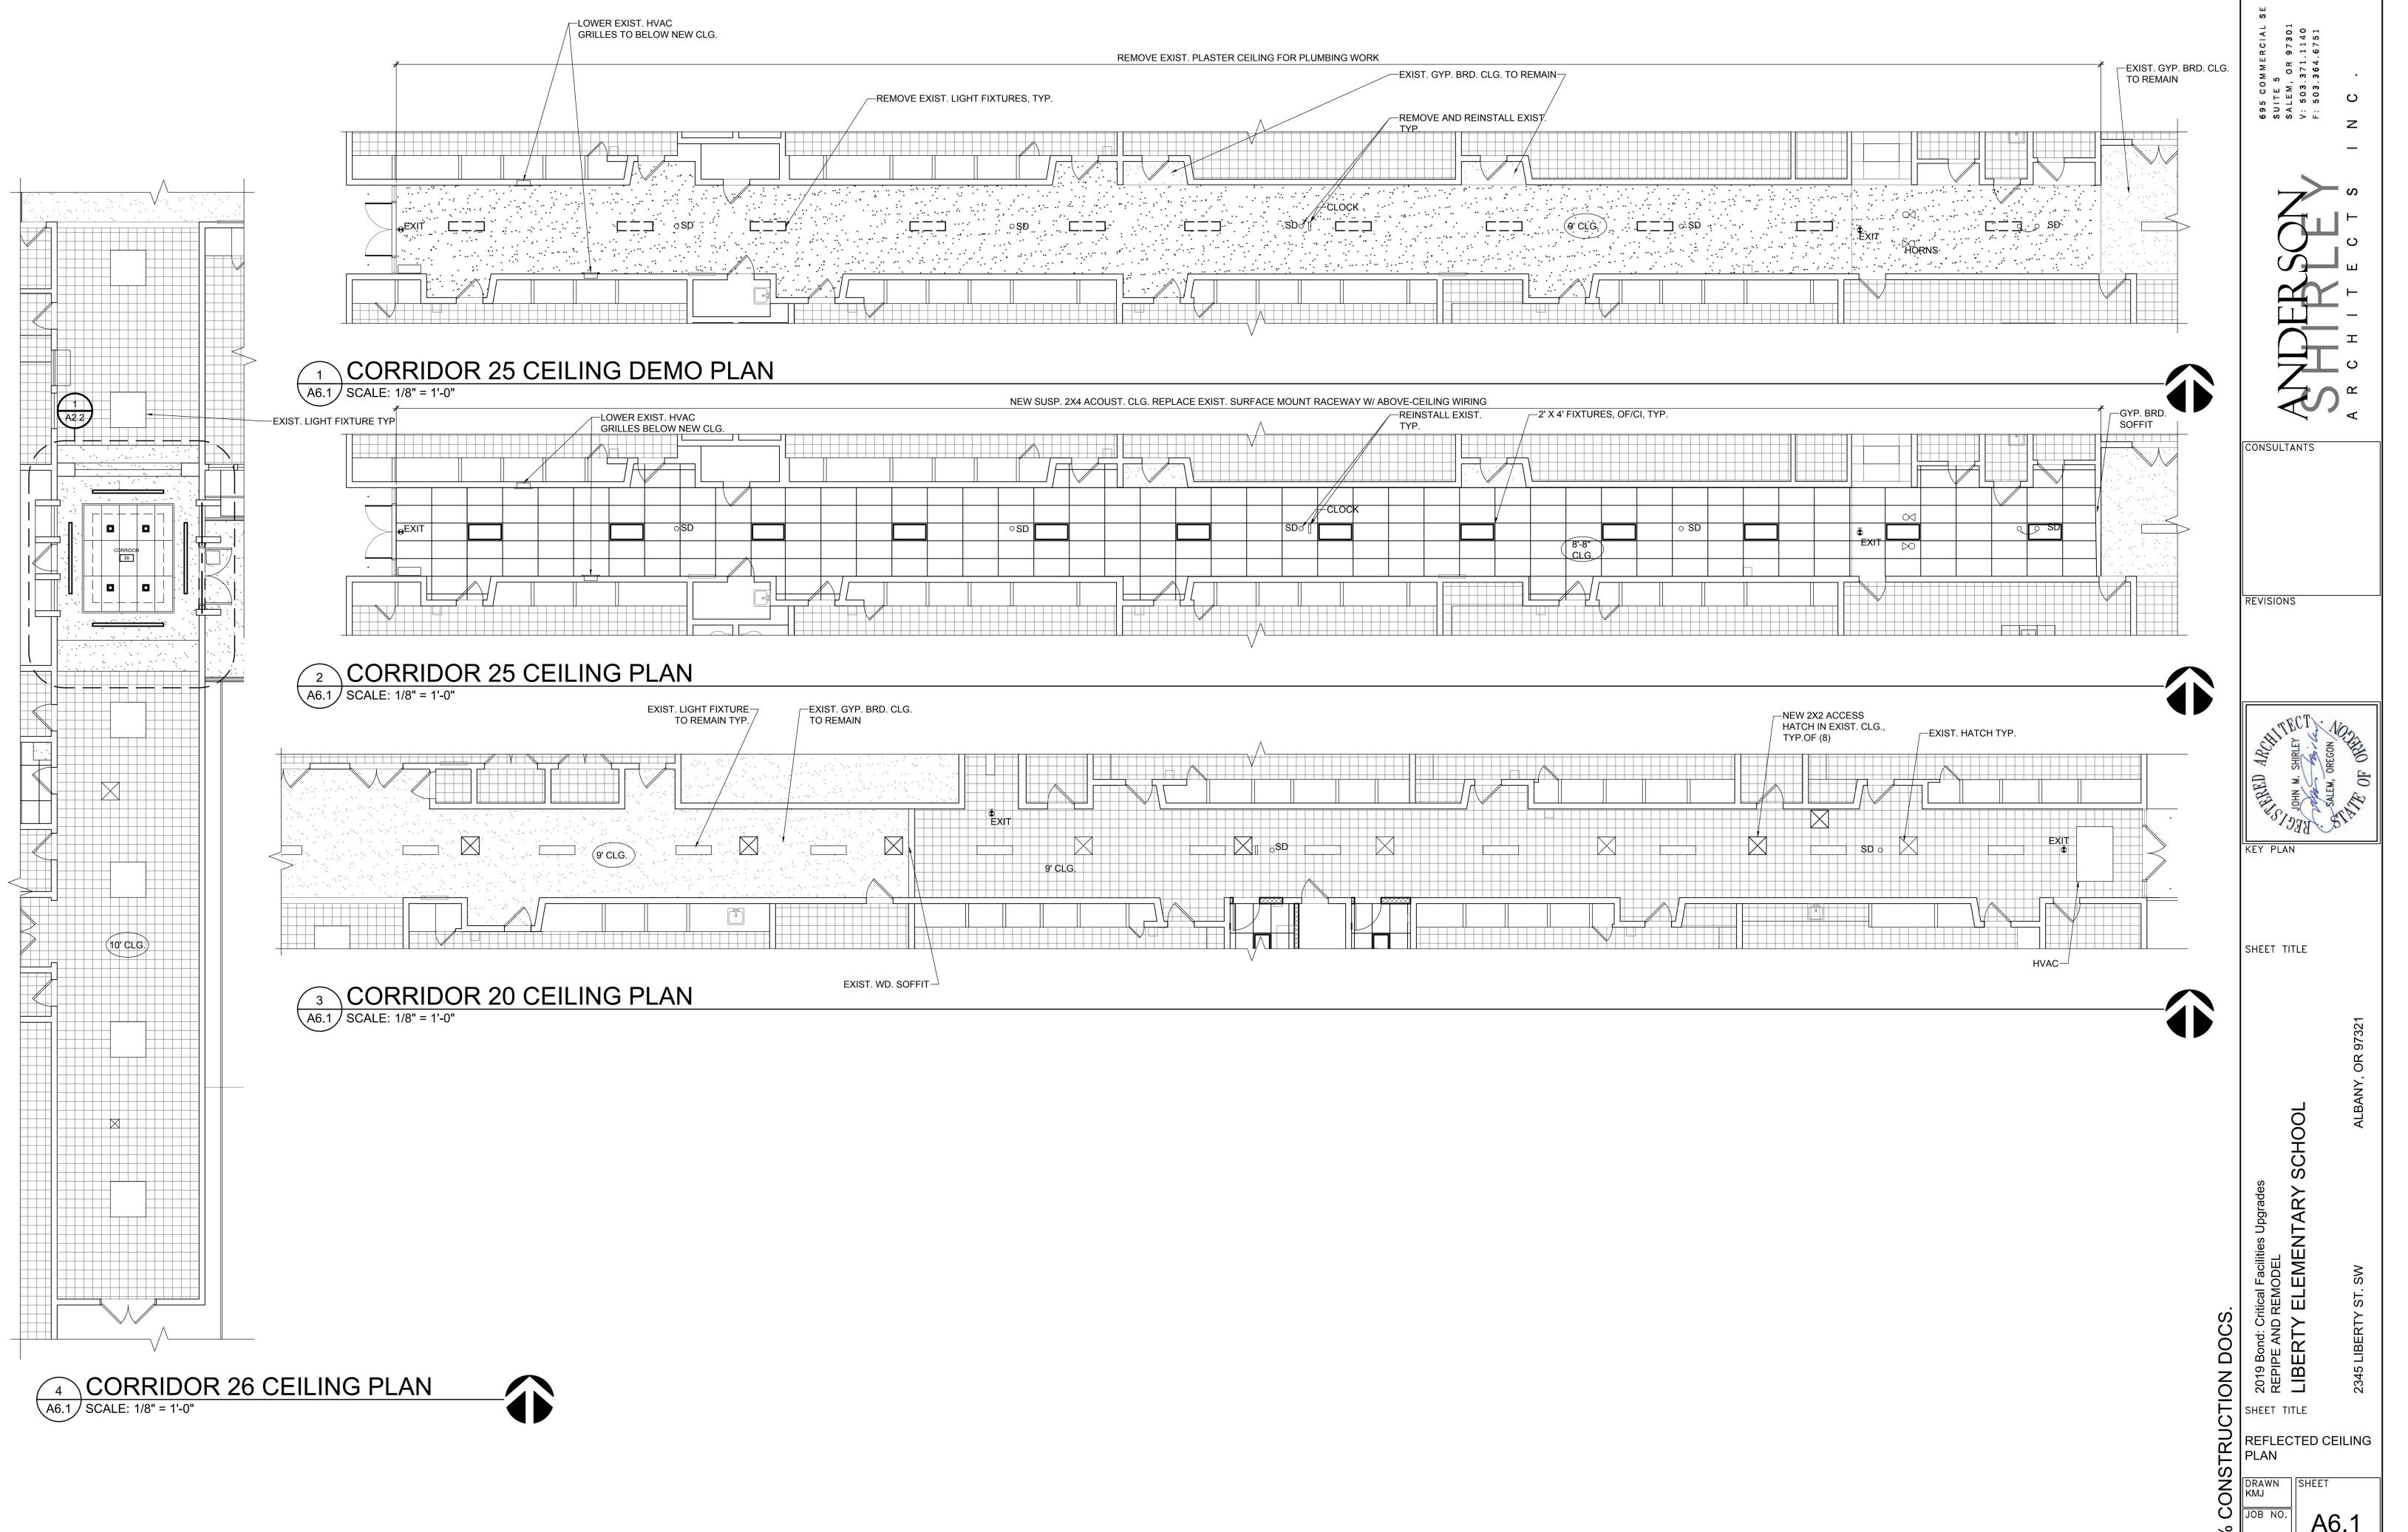



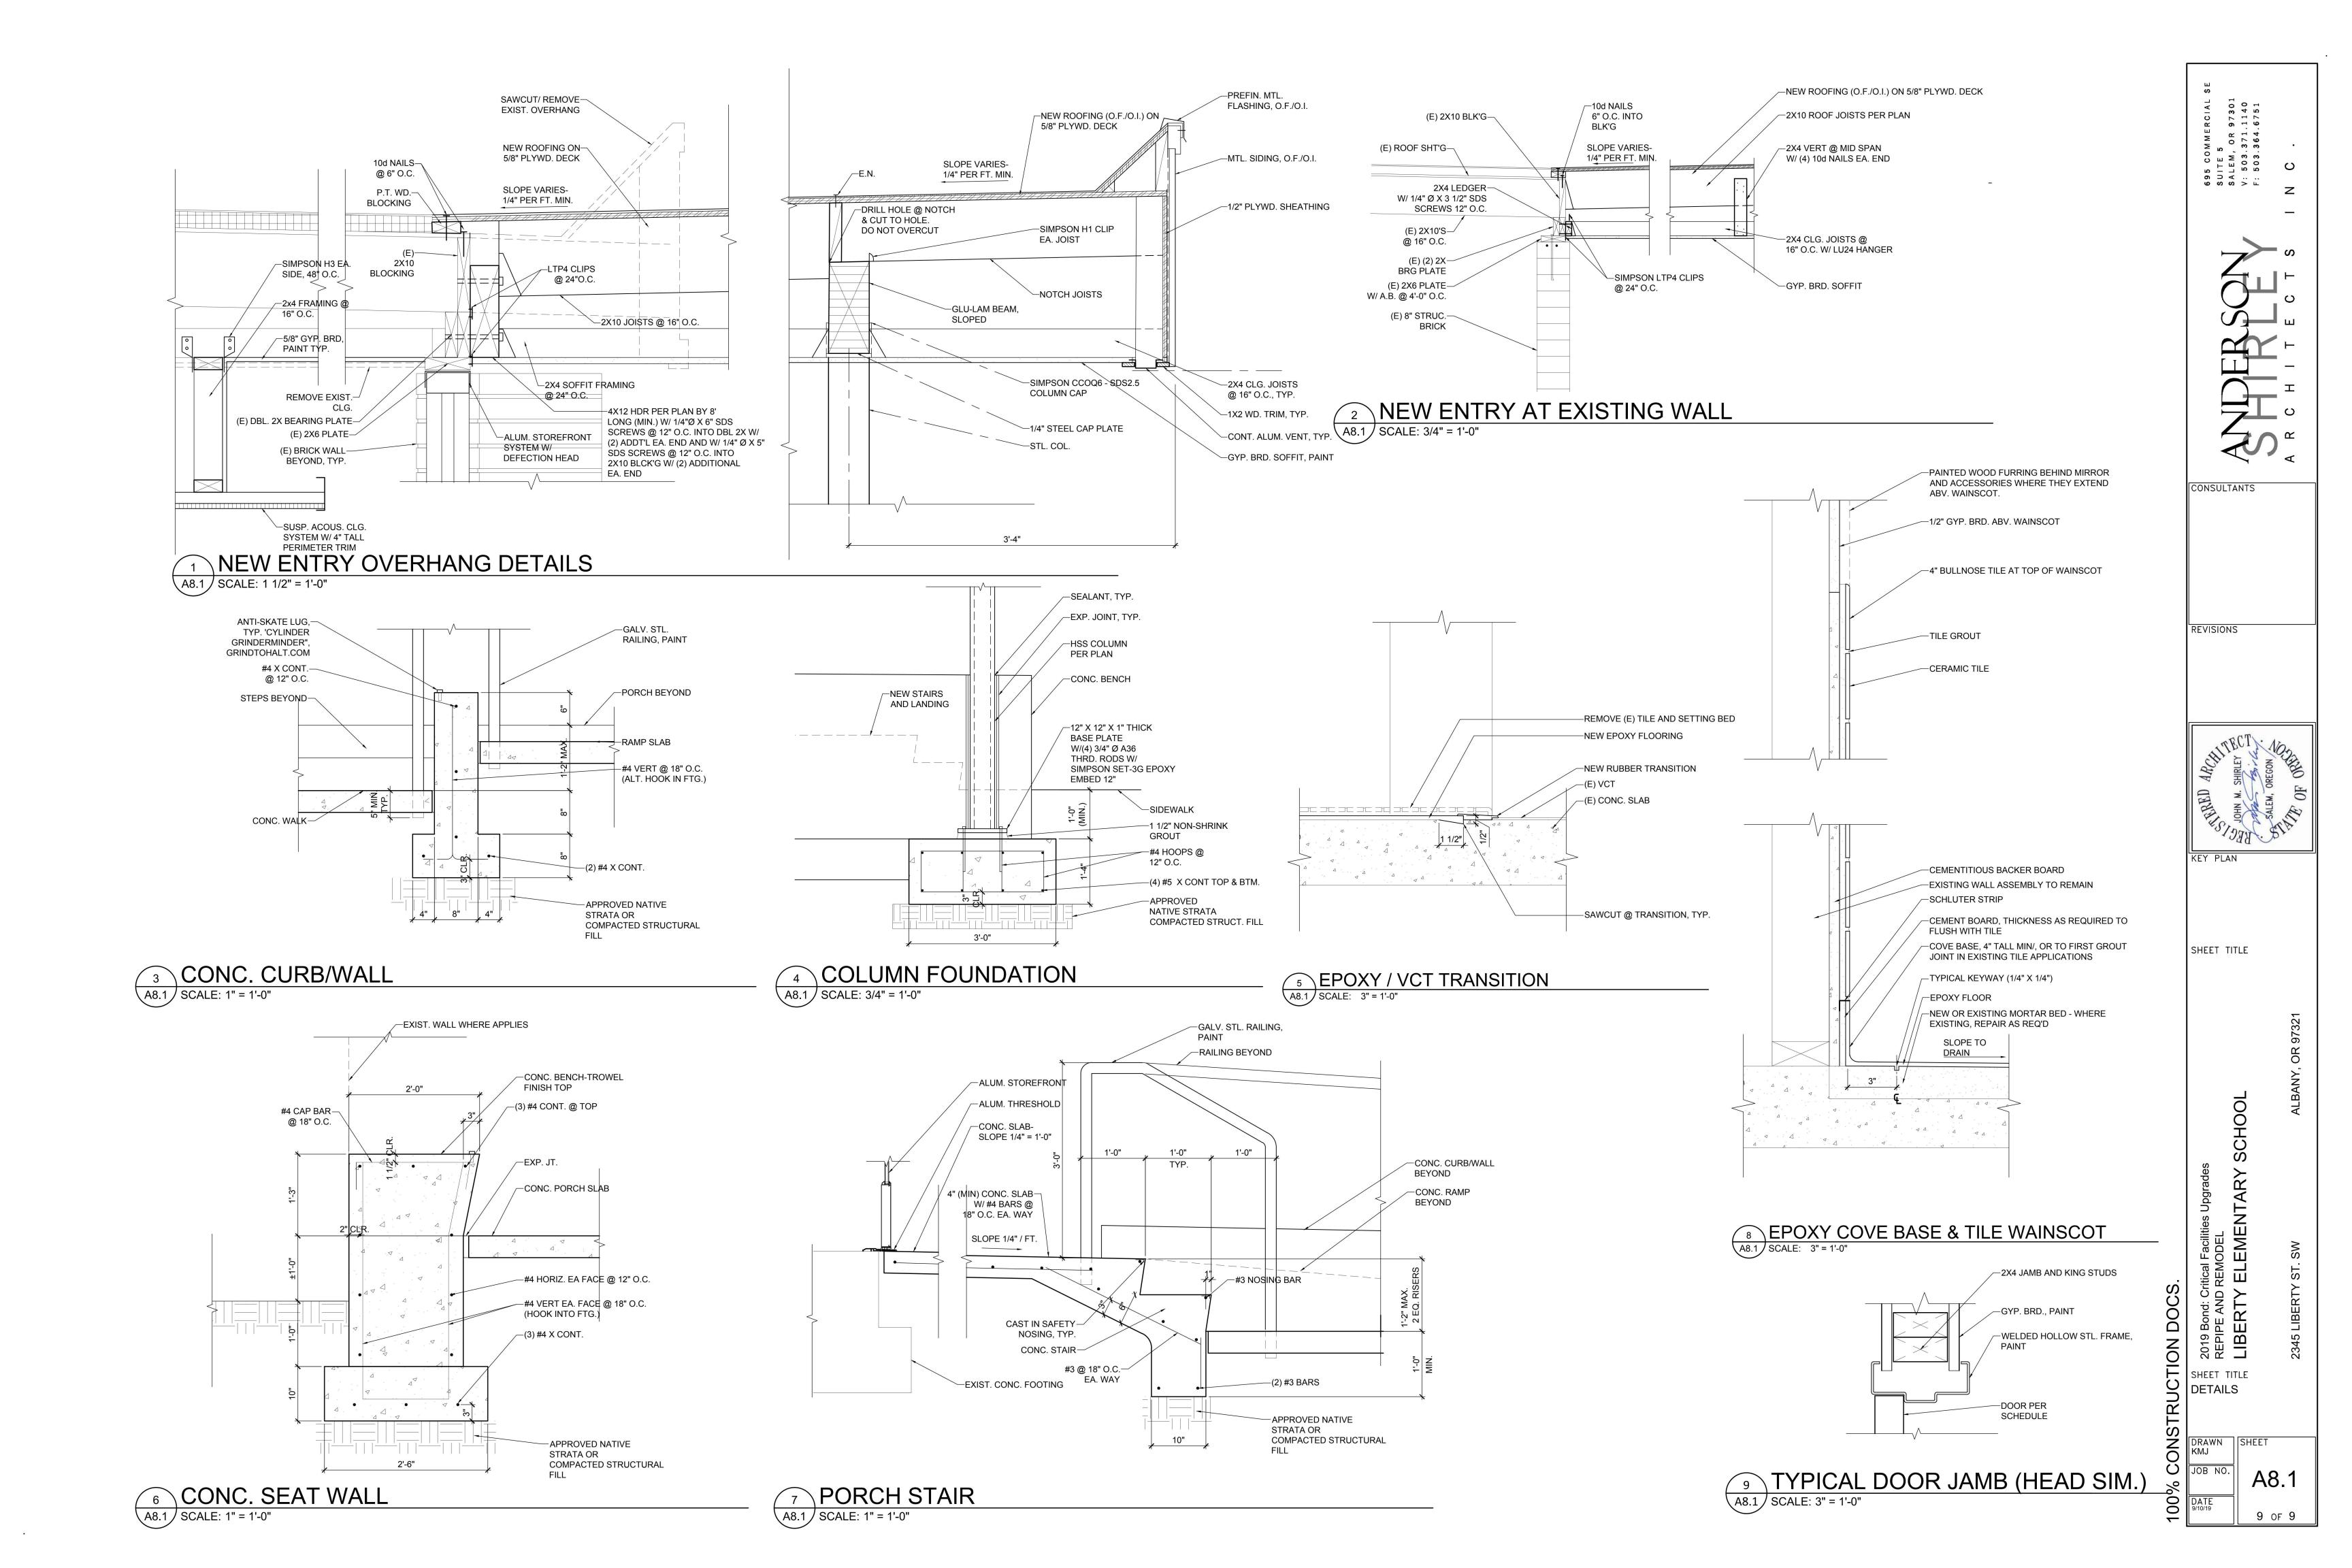

## GENERAL NOTES

- 1. VERIFY ALL EXISTING CONDITIONS RELATIVE TO THE SCOPE OF WORK.
- 2. WHERE PIPE EXISTS IN WALLS OR ABOVE INACCESSIBLE HARD CEILINGS ABANDON PIPE, UNLESS OTHERWISE NOTED. LABEL BOTH ENDS AS ABANDONED.

## SCOPE OF WORK

- 1. REPLACE EXISTING DOMESTIC WATER PIPING AS SHOWN. EXISTING COPPER MAINS TO REMAIN.
- 2. PROVIDE NEW STOPS AT ALL NEW AND REPIPED FIXTURES.
- 3. PROVIDE SUPPLIES FROM STOPS TO FAUCETS AT ALL NEW AND REPIPED FIXTURES.
- 4. FIXTURES ARE EXISTING OR NEW AS NOTED IN CONNECTION SCHEDULE.
- 5. REMOVE AND REPLACE EXISTING FIXTURES AS REQUIRED

#### KEYED NOTES:

- ALL GALVANIZED COLD, HOT, AND HOT WATER RECIRC PIPING IN ACCESSIBLE LOCATIONS TO BE REMOVED.
- 2 CUT WALL AS REQUIRED FOR ACCESS TO HOSE BIBB.
- 3 REMOVE AND REINSTALL FIXTURES AFTER REPIPE
- 4 REMOVE EXISTING HOSE BIBB AND PATCH WALL.



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REVISIONS




KEY PLAN


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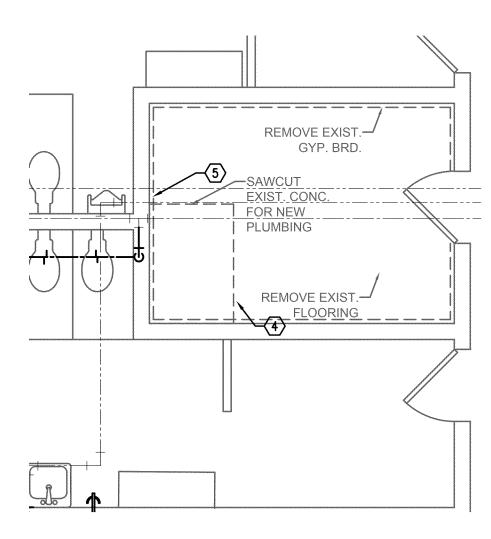
2019 Bond: Critical Facilities Upgrades REPIPE AND REMODEL LIBERTY ELEMENTARY S

SHEET TITLE PLUMBING DEMOLITION FLOOR PLAN

DRAWN BKG JOB NO. DP2.2 2 **or** 10



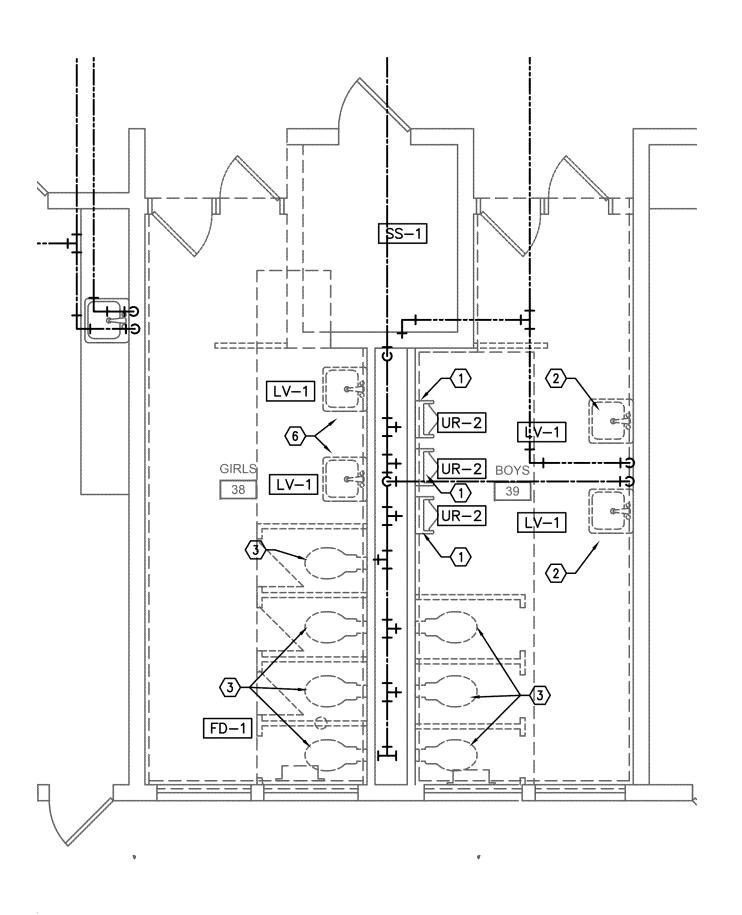

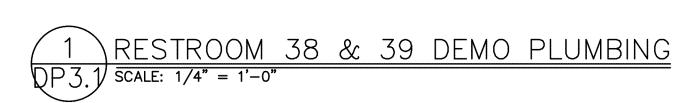

2 JANITOR 36 DEMO PLUMBING

QP3.1 SCALE: 1/4" = 1'-0"

## GENERAL NOTES

- VERIFY ALL EXISTING CONDITIONS RELATIVE TO THE SCOPE OF WORK.
- 2. WHERE PIPE EXISTS IN WALLS OR ABOVE INACCESSIBLE HARD CEILINGS ABANDON PIPE, UNLESS OTHERWISE NOTED. LABEL BOTH ENDS AS ABANDONED.

#### **KEYED NOTES:**

- REMOVE EXISTING FLOOR MOUNT URINALS. SAW CUT FLOOR AND MODIFY WASTE FOR WALL HUNG URINALS.
- 2 REMOVE EXISTING LAVATORY
- REMOVE EXISTING WATER CLOSET. SAW CUT FLOOR AND EXTEND WASTE TO NEW WATER CLOSET LOCATION.
- 4 SAWCUT CONCRETE FLOOR FOR NEW WATER CLOSET PIPING
- 5 REMOVE EXISTING SERVICE SINK AND MODIFY PIPING FOR LAVATORY
- 6 REMOVE EXISTING LAVATORY AND CAP SUPPLY, WASTE AND VENT LINES IN WALL


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KEY PLAN

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2019 Bond: Critical Facilities Upgrades
REPIPE AND REMODEL
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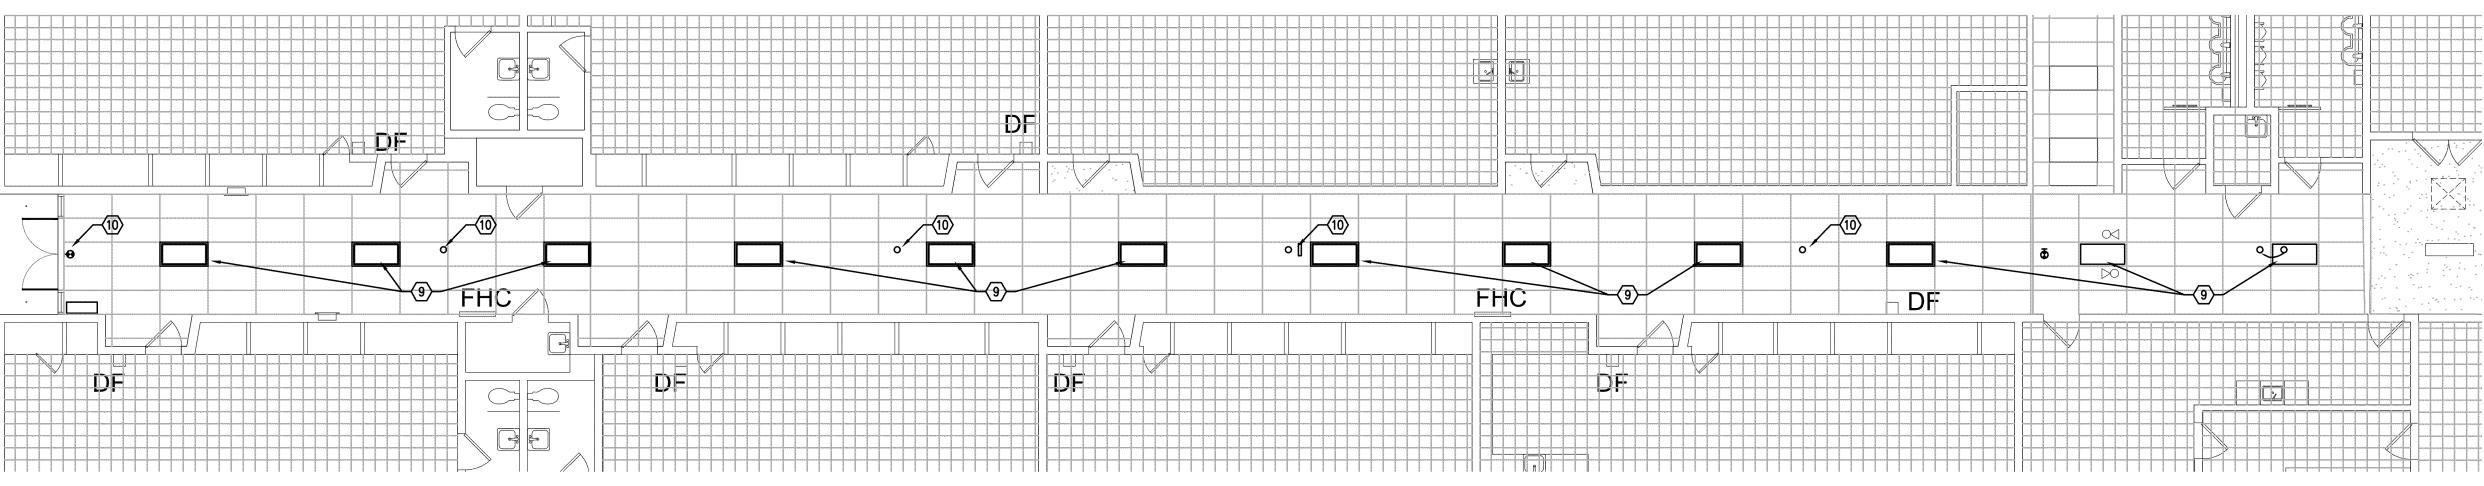
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PLUMBING


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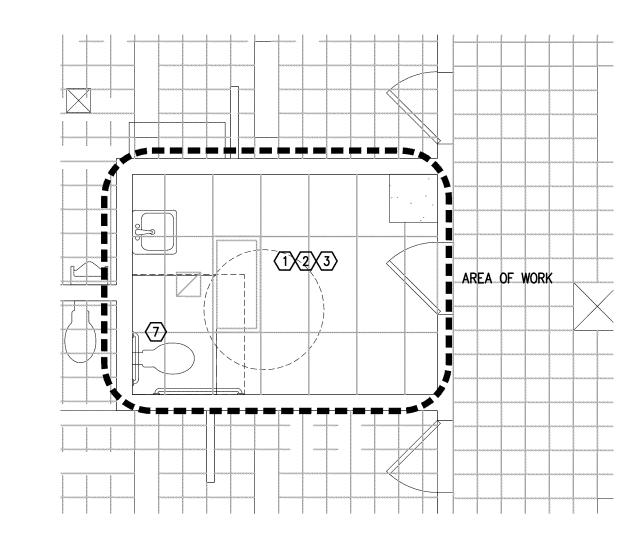
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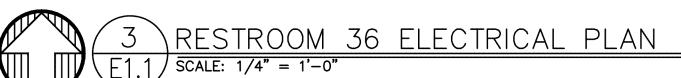
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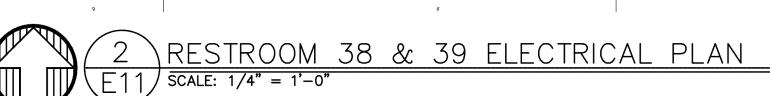







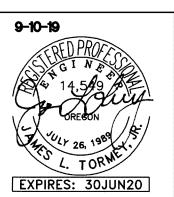



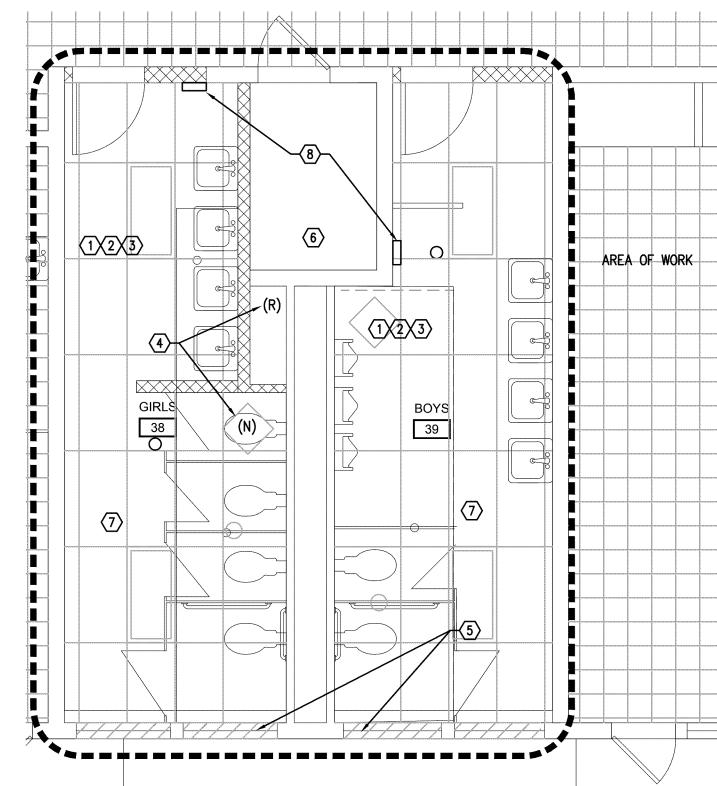

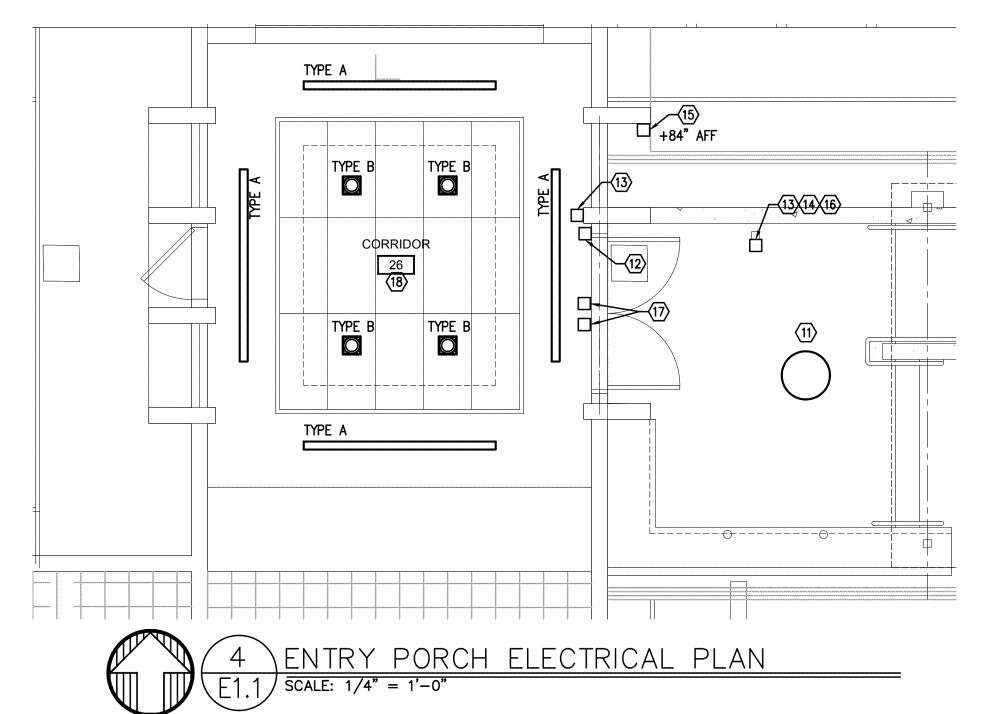

#### **GENERAL NOTES:**

- A. ELECTRICAL DRAWINGS ARE DIAGRAMMATICAL AND MAY NOT ACCURATELY REFLECT ACTUAL CONSTRUCTION CONDITIONS. THE ELECTRICAL CONTRACTOR SHALL BE RESPONSIBLE FOR COORDINATING THE INSTALLATION OF ALL ELECTRICAL EQUIPMENT, WITH ALL TRADES PRIOR TO AND DURING CONSTRUCTION.
- B. ELECTRICAL DESIGN AND CONSTRUCTION SHALL ADHERE TO ALL APPLICABLE NATIONAL, STATE AND LOCAL CODES.
- C. ELECTRICAL CONTRACTOR SHALL REVIEW ALL PROJECT DOCUMENTATION AND IMMEDIATELY ADVISE THE ARCHITECT OF ANY DISCREPANCIES AND/OR CONFLICTS.
- D. COORDINATE WITH DIVISION 23 FOR EXACT LOCATION AND POWER REQUIREMENTS OF ALL MECHANICAL EQUIPMENT PRIOR TO ROUGH IN.
- E. ALL PENETRATIONS THROUGH FIREWALLS WILL REQUIRE FIRESTOP OF THE
- F. ALL PRODUCT SUBSTITUTIONS SUBMITTED FOR REVIEW SHALL BE EQUAL TO ANY AND ALL PRODUCTS AS DEFINED IN THESE PLANS AND AS DEFINED IN THE SPECIFICATIONS. ANY PRODUCT THAT DOES NOT MEET THE DESIGN CRITERIA WILL BE REJECTED.
- G. STANDARD RECEPTACLE MOUNTING HEIGHT IS 18" A.F.F. UNLESS OTHERWISE SPECIFIED. CONTRACTOR SHALL IDENTIFY ANY AREAS WHERE DEVICE MOUNTING DOES NOT MEET THIS STANDARD FOR DIRECTION.
- H. CONSULT ARCHITECT FOR ANY MOUNTING HEIGHTS AND/OR MATERIAL FINISHES NOT INDICATED ON THE PLANS.
- I. ALL LIGHT FIXTURES, LOW VOLTAGE AND FIRE ALARM DEVICES TO BE RELOCATED AS IDENTIFIED BY THE ARCHITECT, SHALL BE RETAINED FOR REINSTALLATION. ALL FIXTURES SHALL BE CLEANED AND DETERMINED TO BE IN GOOD WORKING ORDER PRIOR TO REINSTALLATION. FIXTURES AND DEVICES FOUND TO BE DAMAGED OR DEFECTIVE AND REQUIRING REPLACEMENT SHALL BE BROUGHT TO THE ATTENTION OF THE ARCHITECT IMMEDIATELY.
- J. ALL CIRCUITS SERVING THE FIXTURES AND DEVICES BEING RELOCATED AND/OR REINSTALLED, SHALL BE RETAINS AND REUSED.

#### O KEYED NOTES:

- DISCONNECT AND RETAIN LIGHT SWITCH FOR RELOCATION AS NEEDED. CONSULT ARCHITECT FOR EXACT LOCATION OF ANY RELOCATED SWITCHES AND LOW VOLTAGE
- 2. DISCONNECT AND REMOVE LIGHT FIXTURES, LOW VOLTAGE AND/OR FIRE ALARM DEVICES IN THIS AREA. RETAIN LOW VOLTAGE & FIRE ALARM DEVICES FOR REMODEL REINSTALL.
- PROVIDE CEILING MOUNTED OCCUPANCY SENSOR FOR LIGHTING AND EXHAUST FAN CONTROL. OCCUPANCY SENSOR SHALL BE WATT STOPPER DUAL TECH (ULTRASONIC AND
- RELOCATE ELECTRICAL POWER TO UNIT HEATERS. REFER TO MECHANICAL PLANS FOR ADDITIONAL INFORMATION AND FIELD COORDINATE WITH MECHANICAL EQUIPMENT INSTALLER.
- DISCONNECT ELECTRICAL CONNECTIONS TO MECHANICAL EQUIPMENT TO BE REMOVED REMOVE ANY WIRE AND/OR CONDUIT AS FAR BACK TO THE PANEL AS POSSIBLE. LABEL ANY LEFT OVER CIRCUITS AS "SPARE" AT THE PANEL. REFER TO MECHANICAL PLANS FOR ADDITIONAL INFORMATION AND FIELD COORDINATE WITH MECHANICAL EQUIPMENT INSTALLER.
- RETAIN CIRCUIT FOR RECONNECTION TO NEW FAN.
- 7. PROVIDE ONE 20A, 120V, 1P CIRCUIT FROM CLOSEST ELECTRICAL PANEL WITH SPARE CAPACITY, TO RESTROOMS FOR AUTOFLUSH POWER TO WATER CLOSETS AND URINALS. CONSULT PLUMBING INSTALLER FOR EXACT ELECTRICAL REQUIREMENTS AND FIELD COORDINATE INSTALLATION WITH PLUMBER.
- PROVIDE ONE 20A, 120V, 1P CIRCUIT FROM CLOSEST ELECTRICAL PANEL WITH SPARE CAPACITY, TO RESTROOMS FOR WALL MOUNT ELECTRIC HAND DRYERS. CONSULT ARCHITECT FOR EXACT LOCATION AND MOUNTING HEIGHT PRIOR TO ROUGH IN. HAND DRYERS SHALL BE EXCEL DRYER, INC., "XLERATOR" XL SERIES, 1450W, 120V MODEL, OR APPROVED EQUAL. FINISH AND OPTIONS PER ARCHITECT.
- DISCONNECT AND REMOVE EXISTING CEILING LIGHTS IN THIS AREA. RETAIN LIGHTING CIRCUITS AND RECONNECT TO OWNER FURNISHED 2X4 RECESS FIXTURES TO BE INSTALLED IN TILED CEILING GRID AS SHOWN. VERIFY EXACT FIXTURE TYPE WITH OWNER PRIOR TO ROUGH IN.
- AND RETAIN FOR FOR RECONNECTION IN NEW CEILING.
- CIRCUITS AND RECONNECT TO RABB SURFACE MOUNT CEILING FIXTURE AS SHOWN. VERIFY EXACT FIXTURE TYPE WITH OWNER PRIOR TO ROUGH IN.
- 12. PROVIDE ONE 20A, 120V, 1P CIRCUIT FOR AUTOMATIC DOOR OPENERS FROM NEAREST ELECTRICAL PANEL WITH AVAILABLE CAPACITY.
- 13. PROVIDE DOOR OPENER PUSH BUTTON ON BOLLARD. FIELD VERIFY EXACT LOCATION AND MOUNTING HEIGHT.
- OFFICE AREA FOR CONNECTION BY OWNER.
- NEAREST EXISTING SECURITY SYSTEM IN OFFICE AREA FOR CONNECTION BY OWNER.
- 16. PROVIDE ONE CAT5e TWISTED PAIR CABLE FOR NEC SL1100 DOOR PHONE (BE109741/922450) AND TIE INTO EXISTING PHONE SYSTEM. MOUNT ON BOLLARD.
- CIRCUITS AND RECONNECT TO NEW LIGHT FIXTURES SHOWN. FIXTURES SHALL BE AS FOLLOWS UNLESS OTHERWISE APPROVED BY OWNER. LED COLOR TEMPERATURE AND VOLTAGE SHALL MATCH EXISTING FIXTURES IN THE VICINITY AS CLOSELY AS POSSIBLE. LIGHTING CONTROLS SHALL BE COMPATIBLE WITH EXISTING DEVICES AND/OR SYSTEMS.
  - TYPE A: METALUX SKYBAR SERIES, 96" LED LINEAR LOW BAY LUMINAIRE, 6,000 LUMEN, WIDE DISTRIBUTION. VERIFY ALL FIXTURE OPTIONS WITH OWNER PRIOR TO PLACING
  - OWNER'S DIRECTION.

DEVICES.

INSTALL NEW OWNER FURNISHED LIGHT FIXTURES.

10. DISCONNECT AND REMOVE EXISTING LOW VOLTAGE & FIRE ALARM DEVICES IN THIS AREA

11. DISCONNECT AND REMOVE EXISTING CEILING LIGHTS IN THIS AREA, RETAIN LIGHTING

14. PROVIDE ELECTRICAL CONNECTION FOR CARD READER, MOUNTED ON BOLLARD, AND ELECTRONIC STRIKE AND EXTEND CONDUCTORS TO EXISTING ACCESS CONTROL PANEL IN

15. PROVIDE ELECTRICAL CONNECTION FOR SECURITY CAMERA. EXTEND CONDUCTORS TO

COORDINATE WITH OWNER FOR MOUNTING HEIGHTS.

17. PROVIDE DOOR POSITION SENSOR (INTERLOGIX 1076D-N) AND EXTEND CONDUCTORS TO THE EXISTING SECURITY PANEL IN THE OFFICE AREA FOR CONNECTION BY OWNER.

18. DISCONNECT AND REMOVE EXISTING CEILING LIGHTS IN THIS AREA. RETAIN LIGHTING

TYPE B: LIGHTOLIER P4RDL15 4" ROUND RECESSED DOWNLIGHT. FINISH SHALL BE PER

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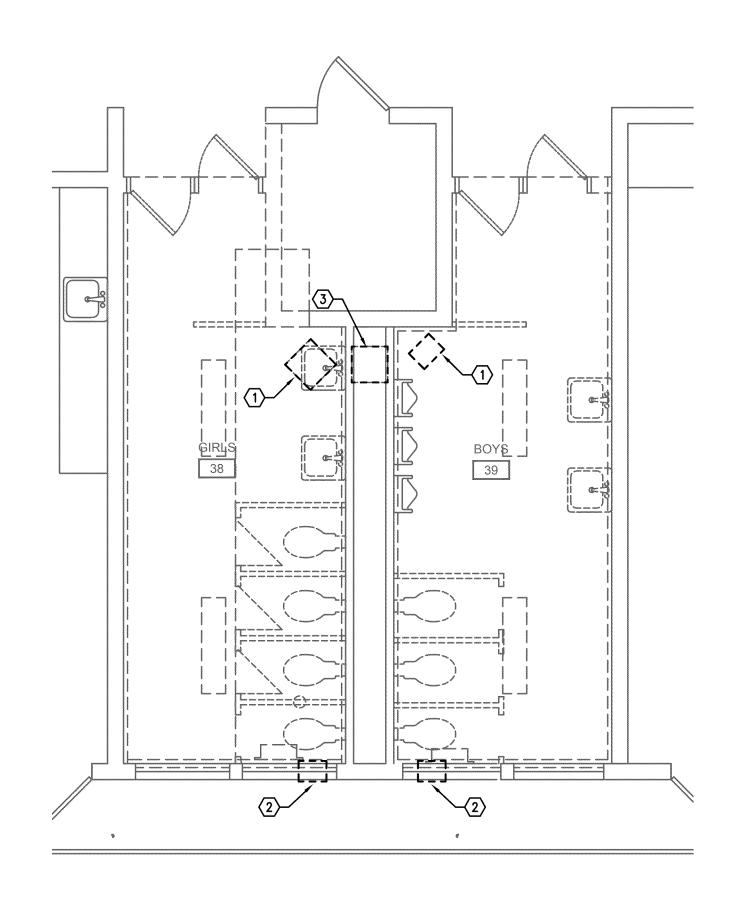
EXPIRES 12-31-2019 KEY PLAN


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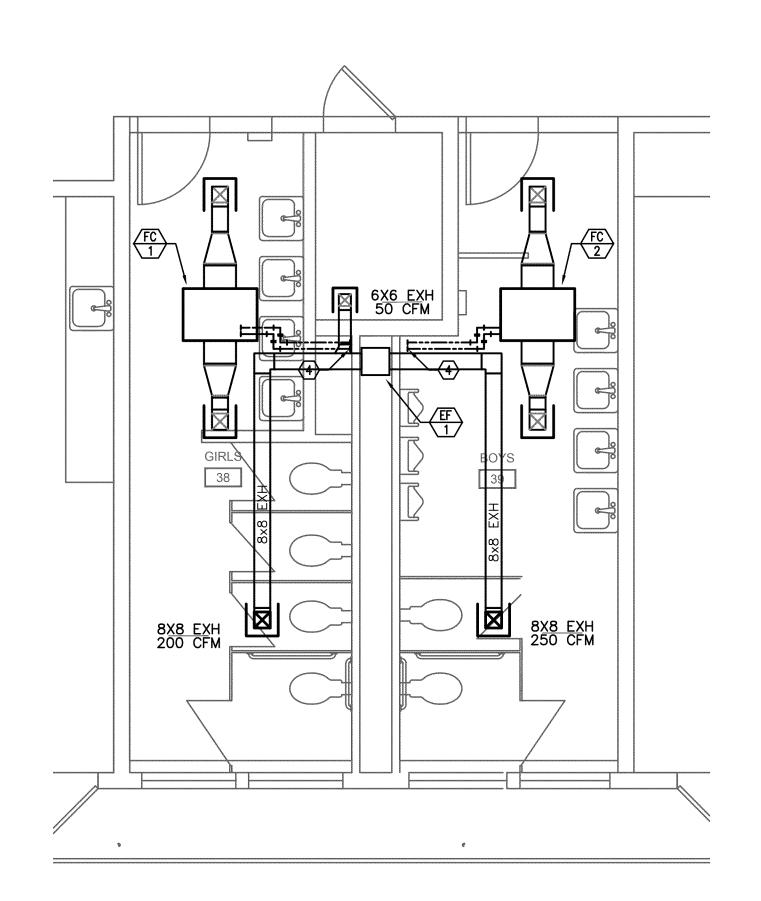
Bor PE **EF** 019 <u>B</u>

SHEET TITLE **ELECTRICAL FLOOR** PLAN

DRAWN SHEET JOB NO.





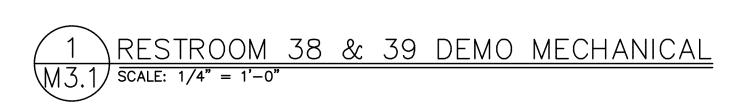

2 RESTROOM 38 & 39 MECHANICAL PLAN M3.1 SCALE: 1/4" = 1'-0"

## GENERAL NOTES

- VERIFY ALL EXISTING CONDITIONS RELATIVE TO THE SCOPE OF WORK.
- 2. COORDINATE INSTALLATION WITH OTHER TRADES

#### **KEYED NOTES:**

- 1 REMOVE EXISTING UNIT HEATER. EXISTING CONTROL VALVE AND THERMOSTAT TO REMAIN.
- 2 REMOVE EXISTING EXHAUST FAN AND PATCH WALL
- REMOVE EXISTING ROOFTOP EXHAUST FAN AND PROVIDE NEW ROOFTOP EXHAUST FAN.
- EXTEND HOT WATER SUPPLY AND RETURN PIPING TO NEW FAN COIL UNIT ABOVE CEILING. PROVIDE ACCESS PANEL AT CONTROL VALVES. RECONNECT EXISTING THERMOSTAT TO NEW FAN COIL UNIT.

EXHAUST FANS	
MARK NUMBER	EF 1
TYPE	ROOFTOP DIRECT DRIVE
SYSTEM	RESTROOMS
CFM	1000
TOTAL SP. (IN H20)	0.50
RPM	1592
TIP SPEED (FPM)	
MOTOR WATTS OR HP	1/4 HP
CONTROLLED BY	CONTINUOUS
INTERLOCK WITH	
FAN SPEED CONTROLLER	YES
WHEEL TYPE	BI
BACK DRAFT DAMPER	MOTORIZED
ISOLATION	NONE
DESIGN WEIGHT (LBS)	65
MAX. SONES	8.7
POWER (VOLTS/PHASE/HZ)	120/1/60
BASIS OF DESIGN:	GREENHECK
	G-103-VG

H	OT WATER	FAN	COIL	
MAF NUN	RK MBER	FC 1	FC 2	
SYS	TEM	GIRLS 38	BOYS 39	
CFM	1.	200 200		
HP		1/30	1/30	
ELE	CTRIC HEAT	NONE	NONE	
=	мвн	6.0	6.0	
ၓ	COIL ROWS	3	3	
	ENT HW (°F)	_		
HEATING COIL	LVG HW (*F)	_	_	
	PRESS LOSS (FT)	_	_	
DES	SIGN WEIGHT (LBS)	120	120	
BAS	SIS OF DESIGN:	CARRIER		
		42CK		




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KEY PLAN

SHEET TITLE

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JEL
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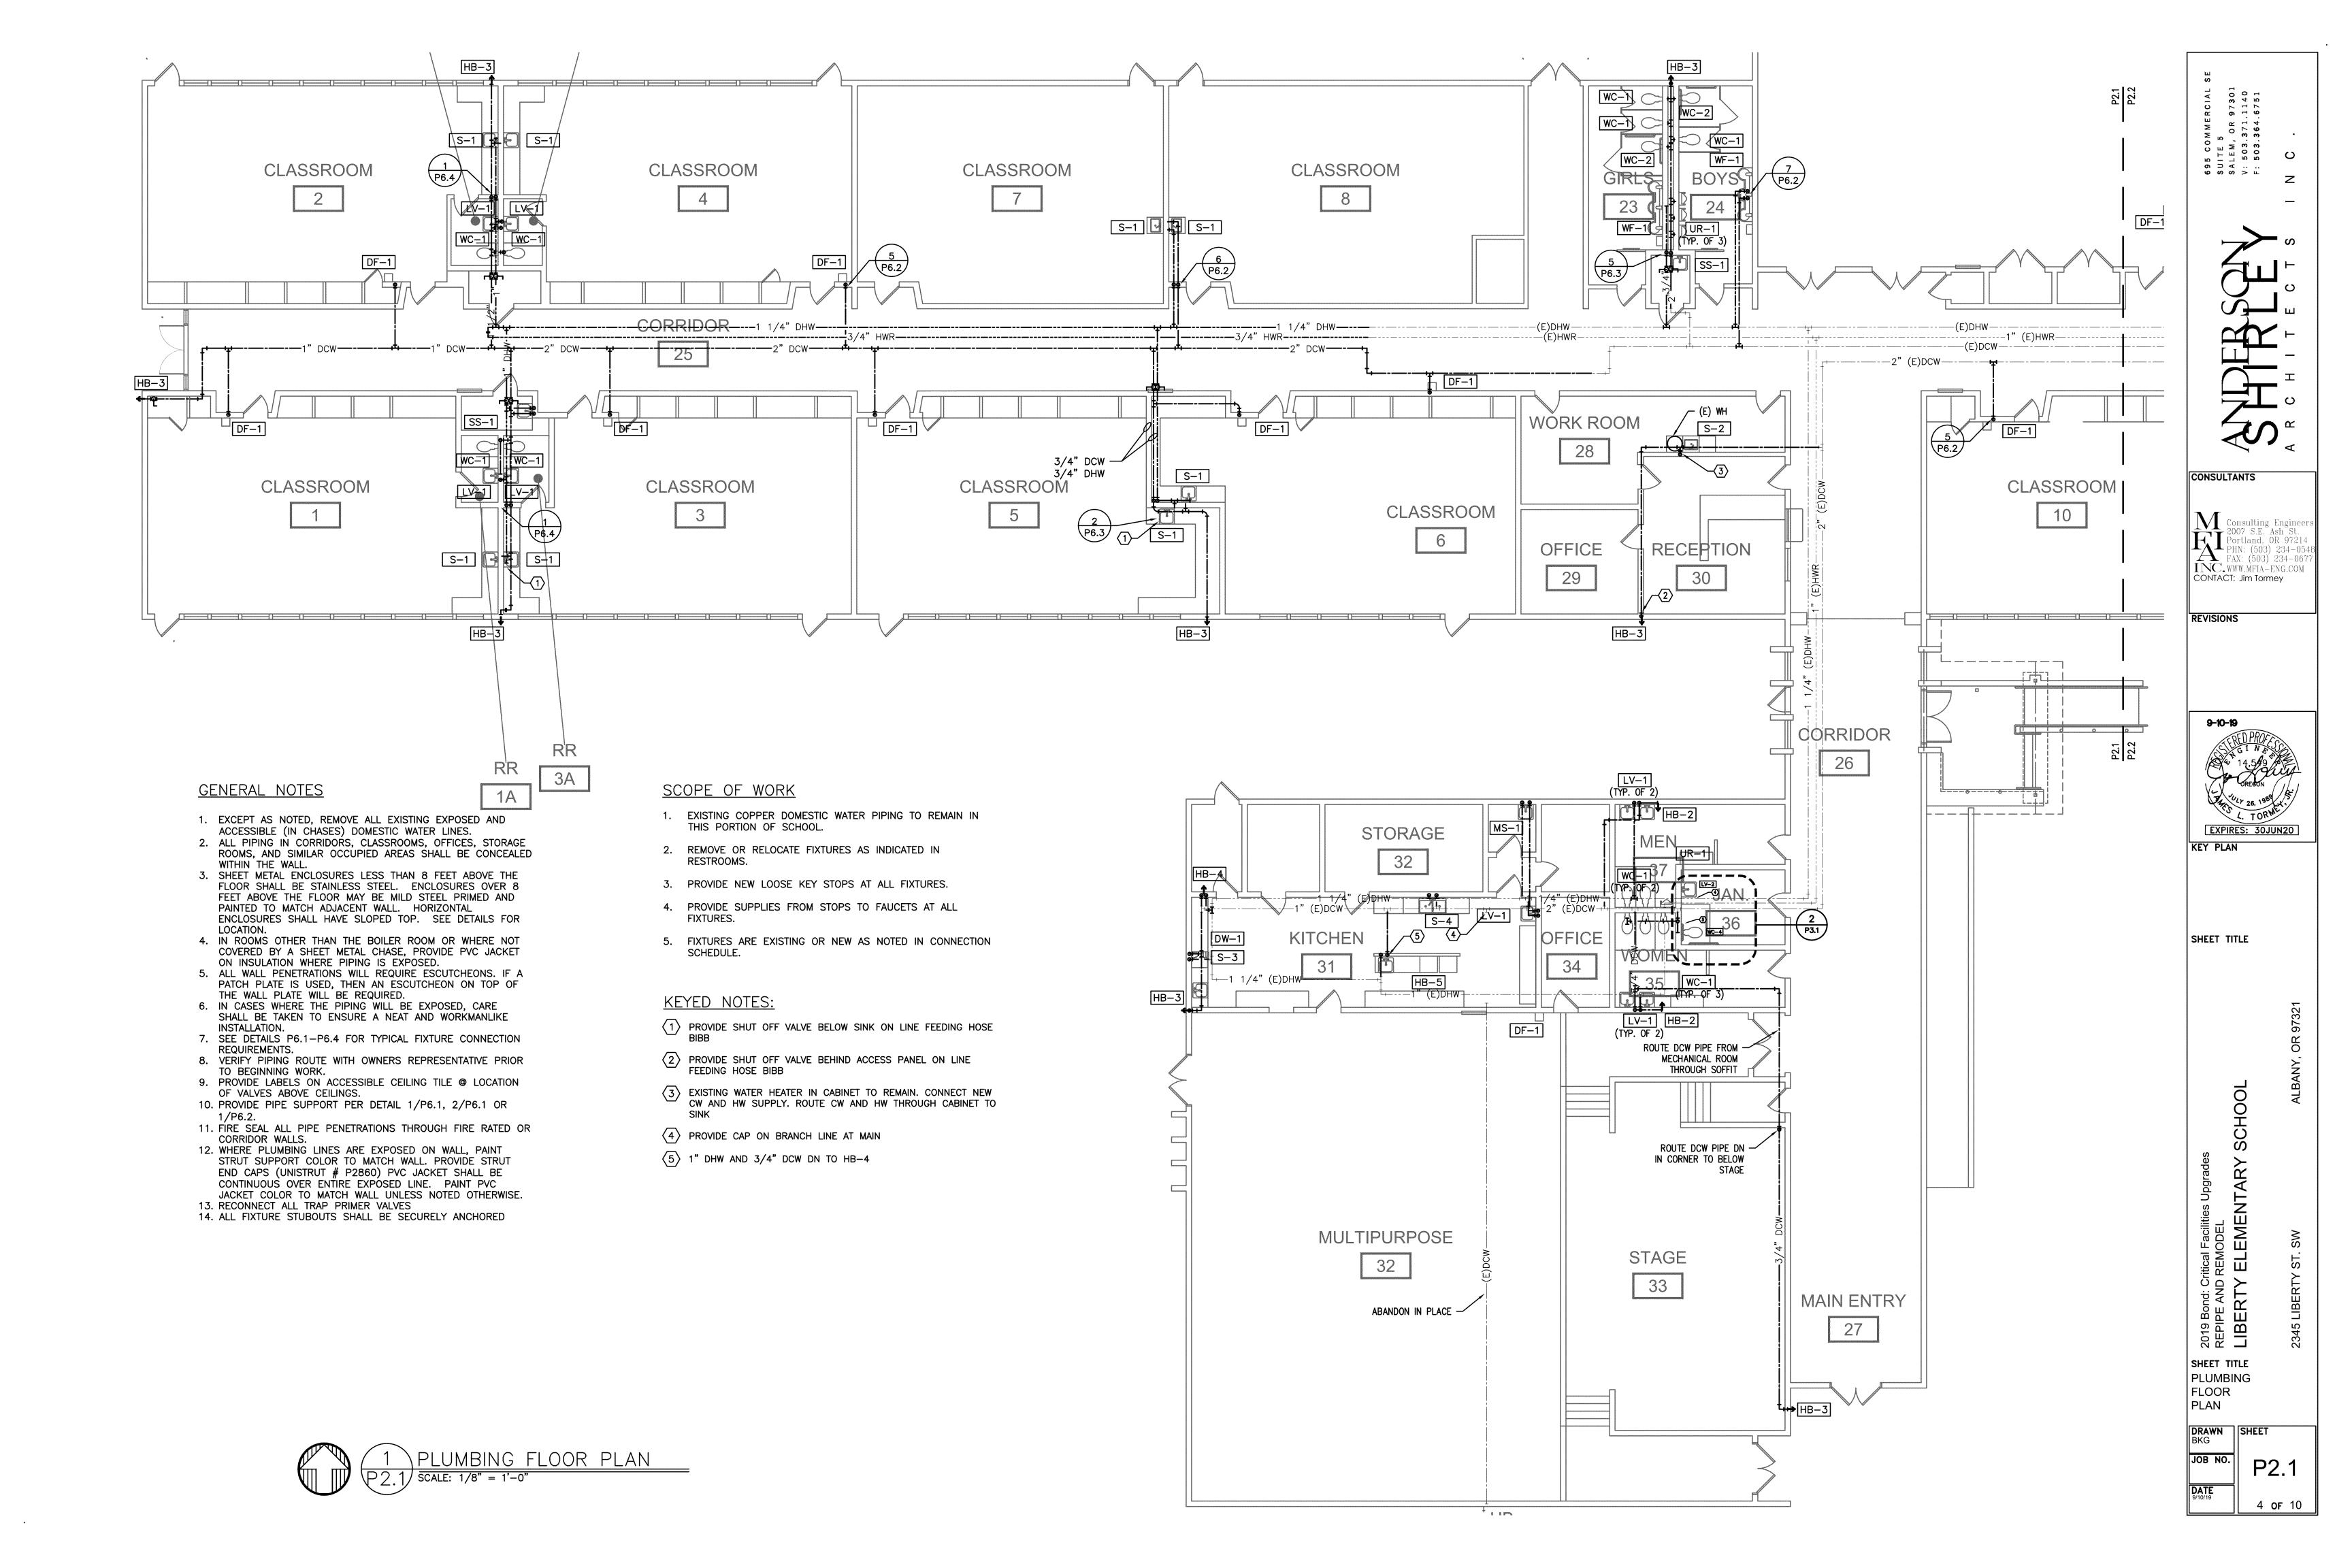
SHEET TITLE
ENLARGED
MECHANICAL
FLOOR PLAN


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JOB NO.

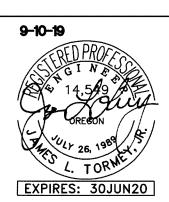DATE
9/10/19

1 OF 1



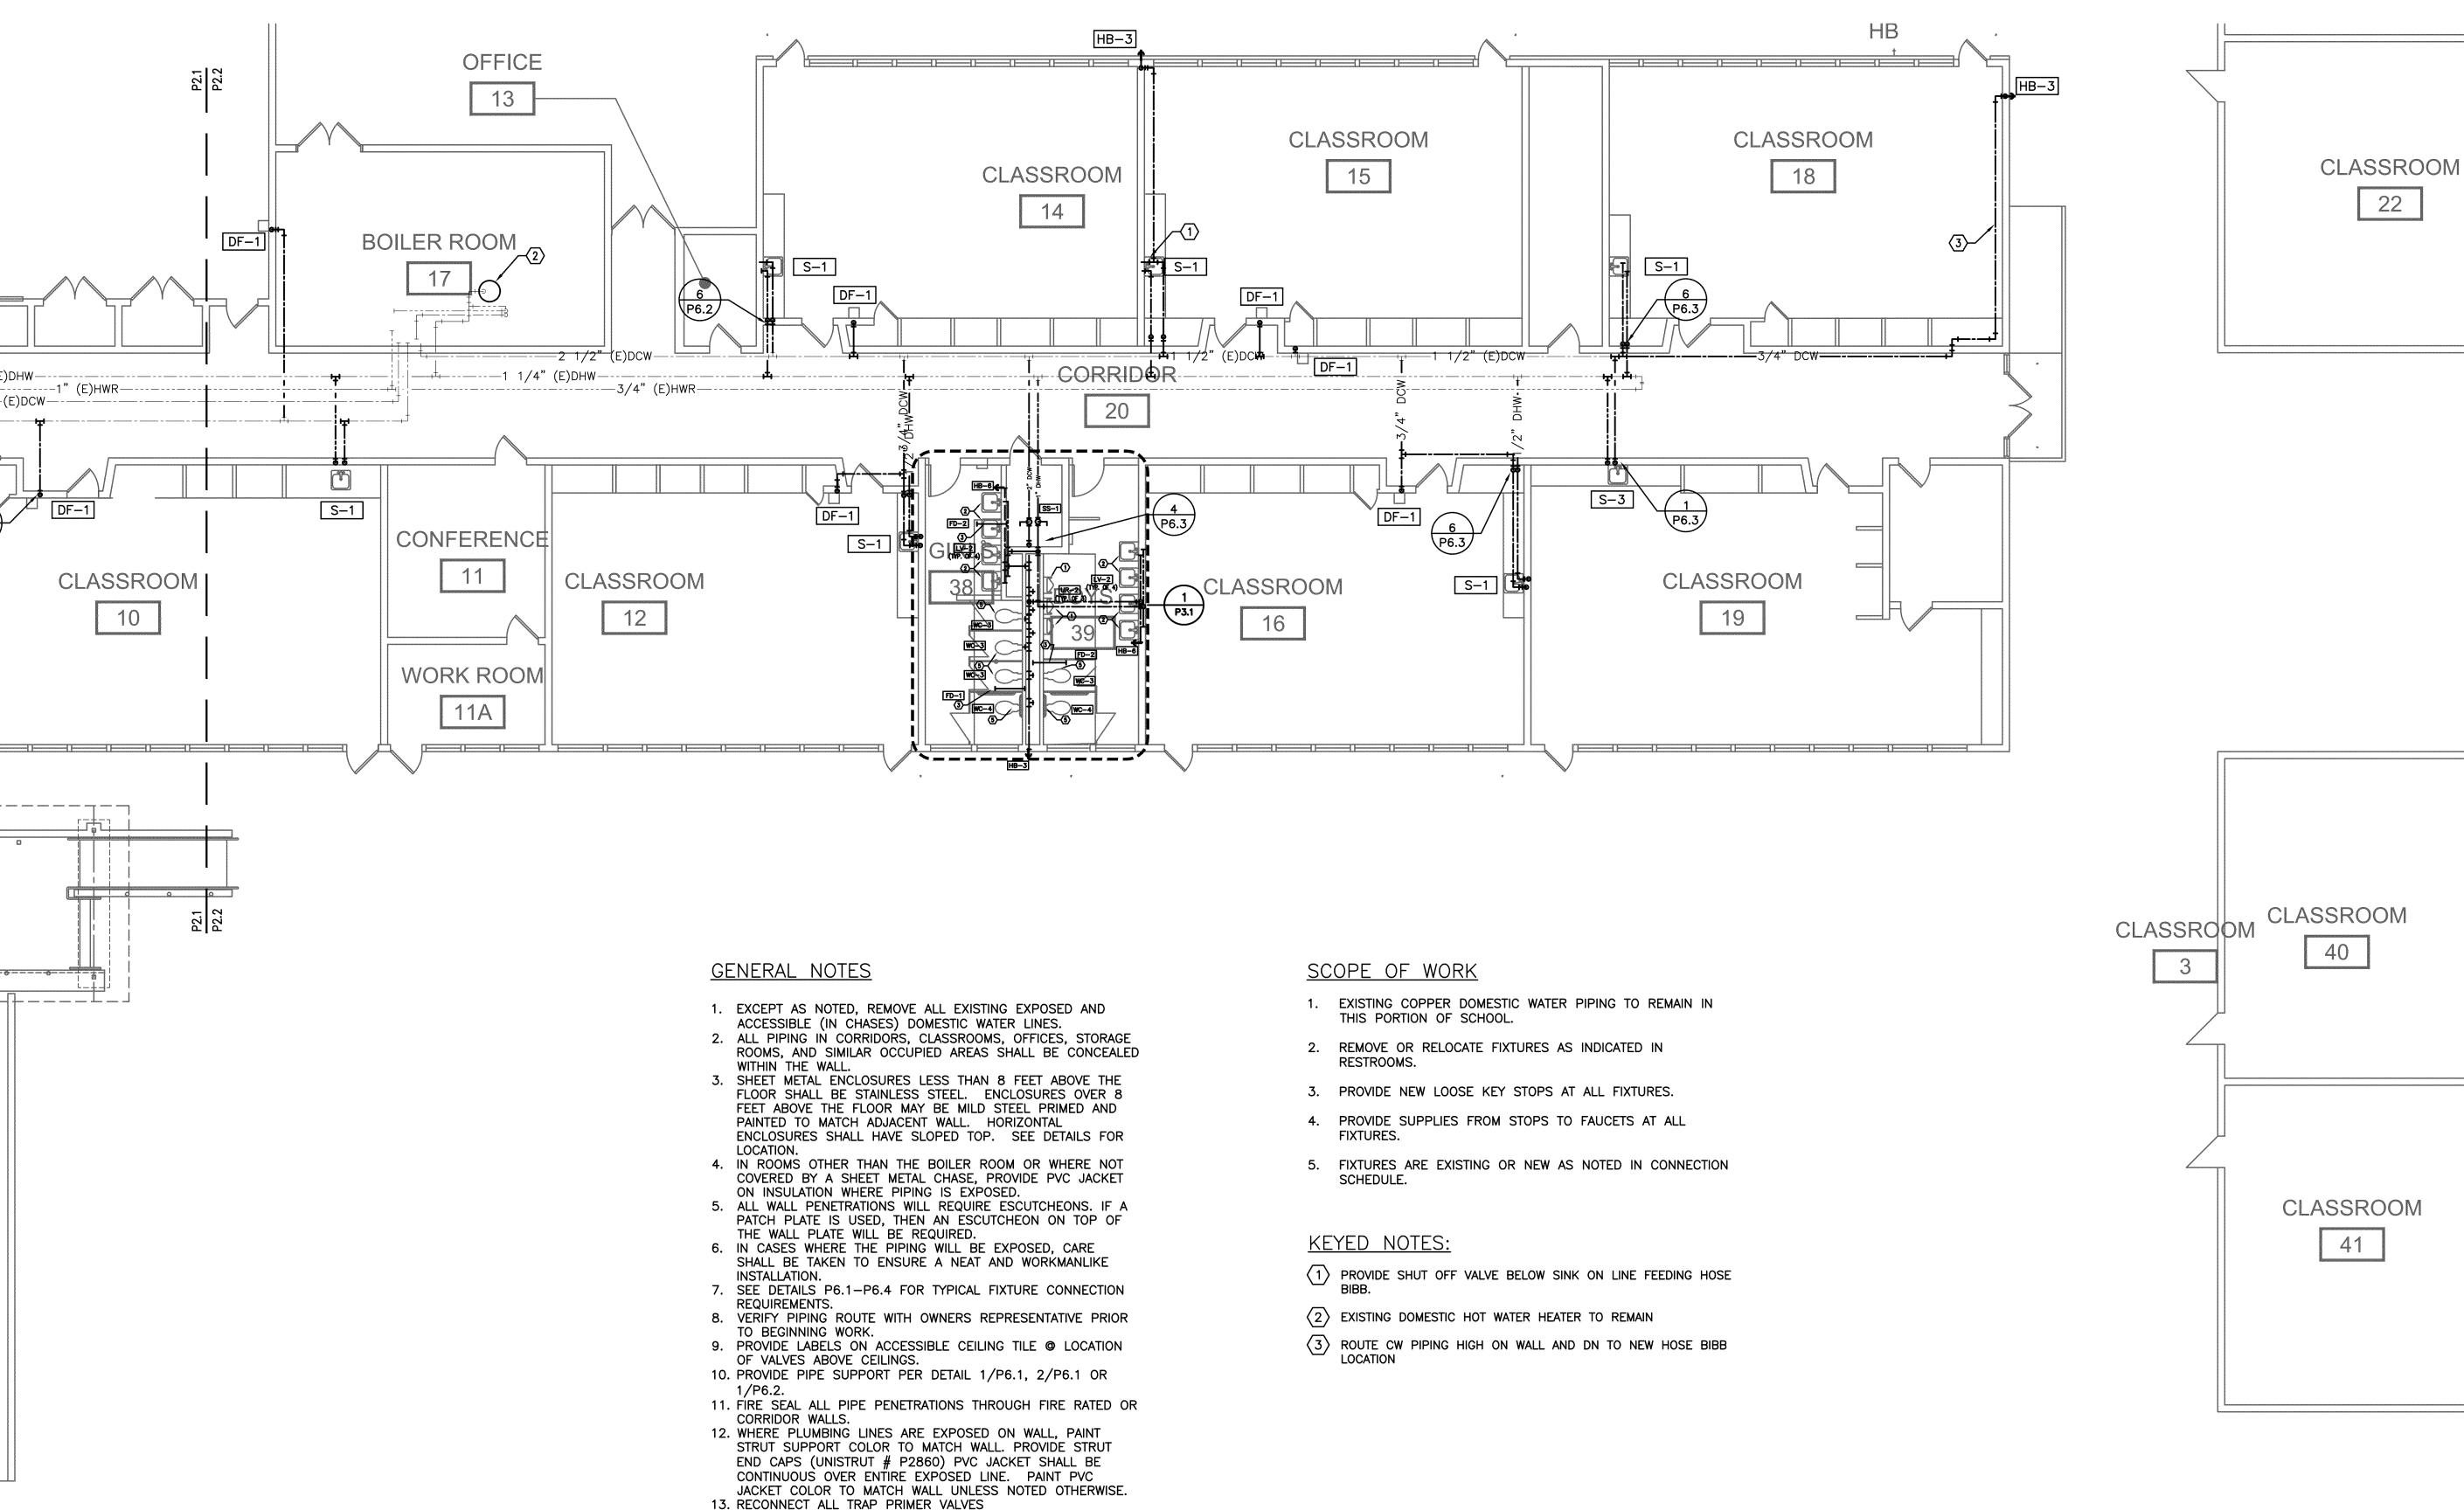

14. ALL FIXTURE STUBOUTS SHALL BE SECURELY ANCHORED

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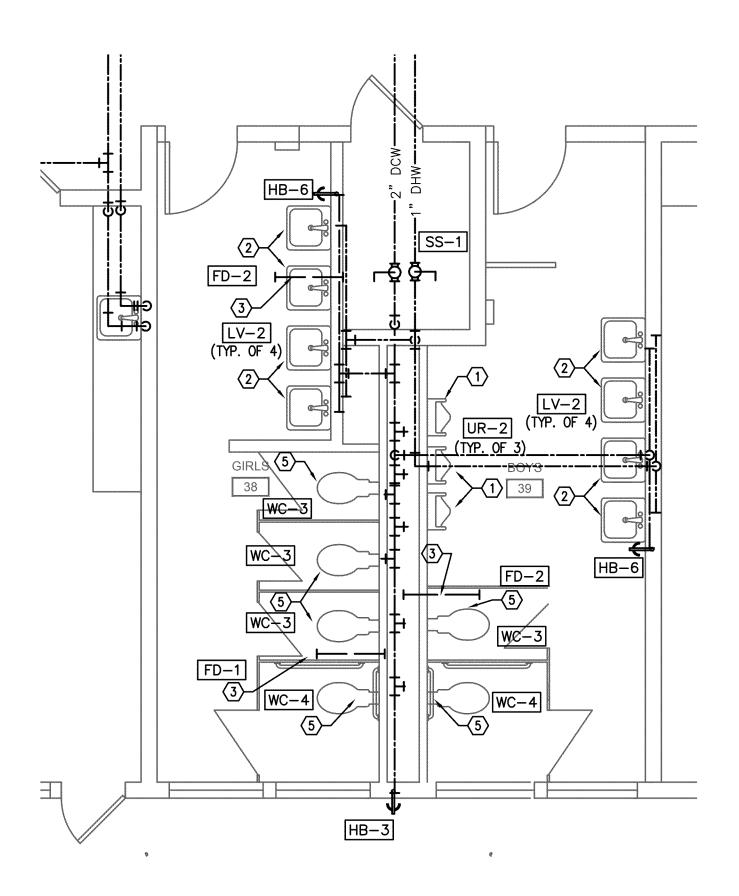
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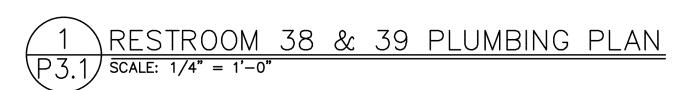
~ 100° EXPIRES: 30JUN20 KEY PLAN


SHEET TITLE

Bor PE **EF** 2019 REPIF SHEET TITLE PLUMBING

FLOOR PLAN DRAWN SHEET JOB NO. 5 **or** 10





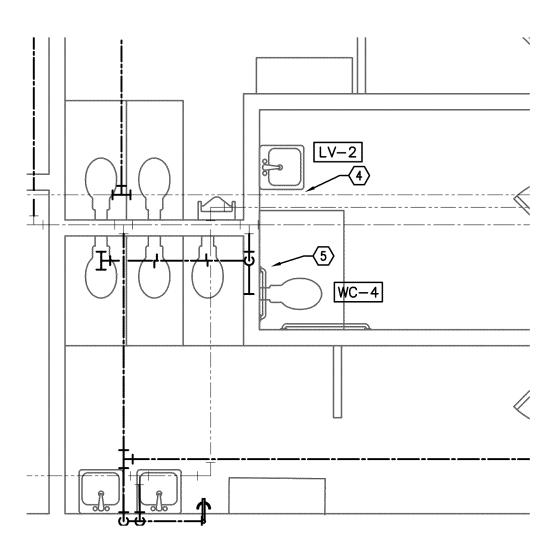

2 JANITOR 36 PLUMBING PLAN P3.1 SCALE: 1/4" = 1'-0"

### GENERAL NOTES

- 1. EXCEPT AS NOTED, REMOVE ALL EXISTING EXPOSED AND ACCESSIBLE (IN CHASES) DOMESTIC WATER LINES.
- 2. ALL PIPING IN CORRIDORS, CLASSROOMS, OFFICES, STORAGE ROOMS, AND SIMILAR OCCUPIED AREAS SHALL BE CONCEALED WITHIN THE WALL.
- 3. SHEET METAL ENCLOSURES LESS THAN 8 FEET ABOVE THE FLOOR SHALL BE STAINLESS STEEL. ENCLOSURES OVER 8 FEET ABOVE THE FLOOR MAY BE MILD STEEL PRIMED AND PAINTED TO MATCH ADJACENT WALL. HORIZONTAL ENCLOSURES SHALL HAVE SLOPED TOP.
- 4. IN ROOMS OTHER THAN THE BOILER ROOM OR WHERE NOT COVERED BY A SHEET METAL CHASE, PROVIDE PVC JACKET ON INSULATION WHERE PIPING IS EXPOSED.
   5. ALL WALL PENETRATIONS WILL REQUIRE ESCUTCHEONS. IF A
- PATCH PLATE IS USED, THEN AN ESCUTCHEON ON TOP OF THE WALL PLATE WILL BE REQUIRED.

  6. IN CASES WHERE THE PIPING WILL BE EXPOSED, CARE SHALL
- 6. IN CASES WHERE THE PIPING WILL BE EXPOSED, CARE SHALL BE TAKEN TO ENSURE A NEAT AND WORKMANLIKE INSTALLATION.
- SEE DETAILS P6.2—P6.3 FOR TYPICAL FIXTURE CONNECTION REQUIREMENTS.
   VERIFY PIPING ROUTE WITH OWNERS REPRESENTATIVE PRIOR TO
- BEGINNING WORK.
- PROVIDE LABELS ON ACCESSIBLE CEILING TILE @ LOCATION OF VALVES ABOVE CEILINGS.
   PROVIDE PIPE SUPPORT PER DETAIL 1/P6.1, 2/P6.1 OR
- 1/P6.2.

  11. FIRE SEAL ALL PIPE PENETRATIONS THROUGH FIRE RATED OR CORRIDOR WALLS.
- 12. WHERE PLUMBING LINES ARE EXPOSED ON WALL, PAINT STRUT SUPPORT COLOR TO MATCH WALL. PROVIDE STRUT END CAPS (UNISTRUT # P2860) PVC JACKET SHALL BE CONTINUOUS OVER ENTIRE EXPOSED LINE. PAINT PVC JACKET COLOR TO MATCH WALL UNLESS NOTED OTHERWISE.
- 13. RECONNECT ALL TRAP PRIMER VALVES
- 14. ALL FIXTURE STUBOUTS SHALL BE SECURELY ANCHORED

#### KEYED NOTES:

- 1) CONNECT NEW URINAL AT EXISTING LOCATIONS
- 2 EXTEND WASTE, VENT, AND SUPPLY LINES IN WALL TO NEW LAVATORIES.
- (3) CONNECT NEW FLOOR DRAIN TO EXISTING WASTE LINE
- PROVIDE NEW LAVATORY AT NEW LOCATION. EXTEND WASTE, VENT, AND SUPPLY LINES IN WALL TO NEW LOCATION
- PROVIDE NEW WATER CLOSET AT NEW LOCATION. RECONNECT TO EXISTING WASTE AND SUPPLY


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695 COMMERSUITE 5 SALEM, OR 9 V: 503.371. F: 503.364.

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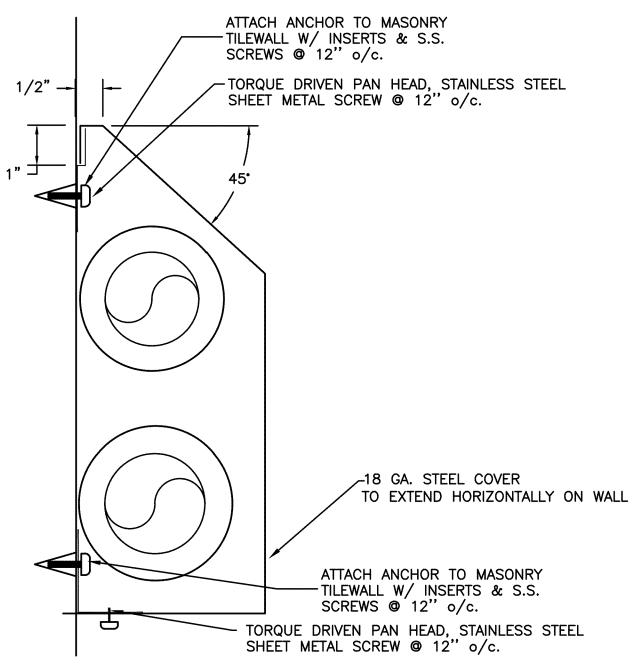
JOB NO.

P3.1

DATE
9/10/19

6 of 10

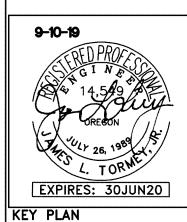ANCHOR DETAIL



SEE 4/P6.1 FOR PIPE SUPPORT


PIPE COVER HORIZONTAL SECTION SCALE: DETAIL

PLUMBING CONNECTION SCHEDULE						
MARK	FIXTURE	W	>	CW	HW	REMARKS
DF-1	(E) DRINKING FOUNTAIN			1/2"		FROM ABOVE
DF-2	(N) DRINKING FOUNTAIN			1/2"		NOT USED
LV-1	(E) LAVATORY			1/2"	1/2"	SINGLE WALL MOUNT
LV-2	(N) LAVATORY	1-1/2"	1-1/2"	1/2"	1/2"	SINGLE WALL MOUNT
S-1	(E) SINK			1/2"	1/2"	CLASSROOM
S-2	(E) SINK			1/2"	1/2"	OFFICE/STAFF
S-3	(E) SINK			1/2"	1/2"	KITCHEN PRERINSE
S-4	(E) SINK			1/2"	1/2"	KITCHEN
S-5	(E) SINK			1/2"	1/2"	KITCHEN
DW-1	(E) DISHWASHER				3/4"	
SS-1	(E) SERVICE SINK			1/2"	1/2"	
MS-1	(E) MOP SINK			1/2"	1/2'	
WF-1	(E) WASH FOUNTAIN			3/4"	3/4"	
HB-1	(E) HOSE BIBB			3/4"		EXTERIOR
HB-2	(E) HOSE BIBB			3/4"		RECESSED
HB-3	(N) HOSE BIBB			3/4"		NON-FREEZE WITH VACUUM BREAKER
HB-4	(E) HOSE BIBB			1/2"	1/2"	
HB-5	(E) HOSE BIBB			1/2"	1/2"	
HB-6	(N) HOSE BIBB			3/4"		RECESSED
WC-1	(E) WATER CLOSET			1"		FLUSH VALVE
WC-2	(E) WATER CLOSET			1"		FLUSH VALVE, ADA
WC-3	(N) WATER CLOSET	3"	2"	1"		FLOOR MOUNT, ELECTRIC FLUSH VALVE
WC-4	(N) WATER CLOSET	3"	2"	1"		FLOOR MOUNT, ELECTRIC FLUSH VALVE, ADA
UR-1	(E) URINAL			1"		WALL HUNG, FLUSH VALVE
UR-2	(N) URINAL	2"	2"	1"		WALL HUNG, ELECTRIC FLUSH VALVE
FD-1	(E) FLOOR DRAIN					
== -	(11) =1 000 00111	>>				

3" | V.L. | -- | --


V.L. - VENTED LINE EXISTING FIXTURES TO REMAIN. PROVIDE NEW STOPS AT ALL FIXTURES.


FD-2 (N) FLOOR DRAIN

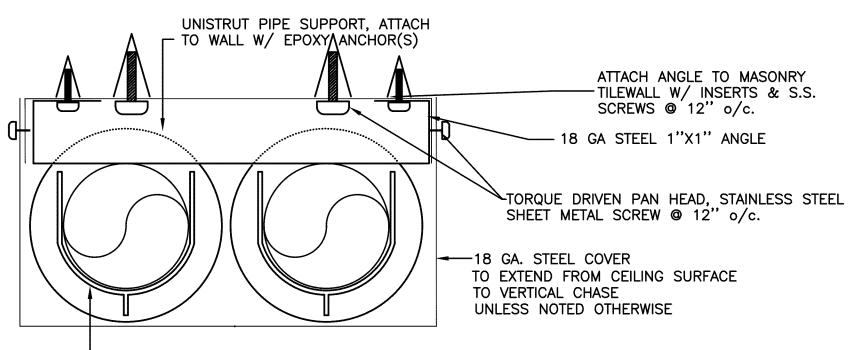


PIPE CLAMP. UNISTRUT CUSH-A-CLAMP OR APPROVED EQUAL OMIT INSULATION @ CLAMP ONLY. PROVIDE GALV. PROTECTION @ CONNECTION



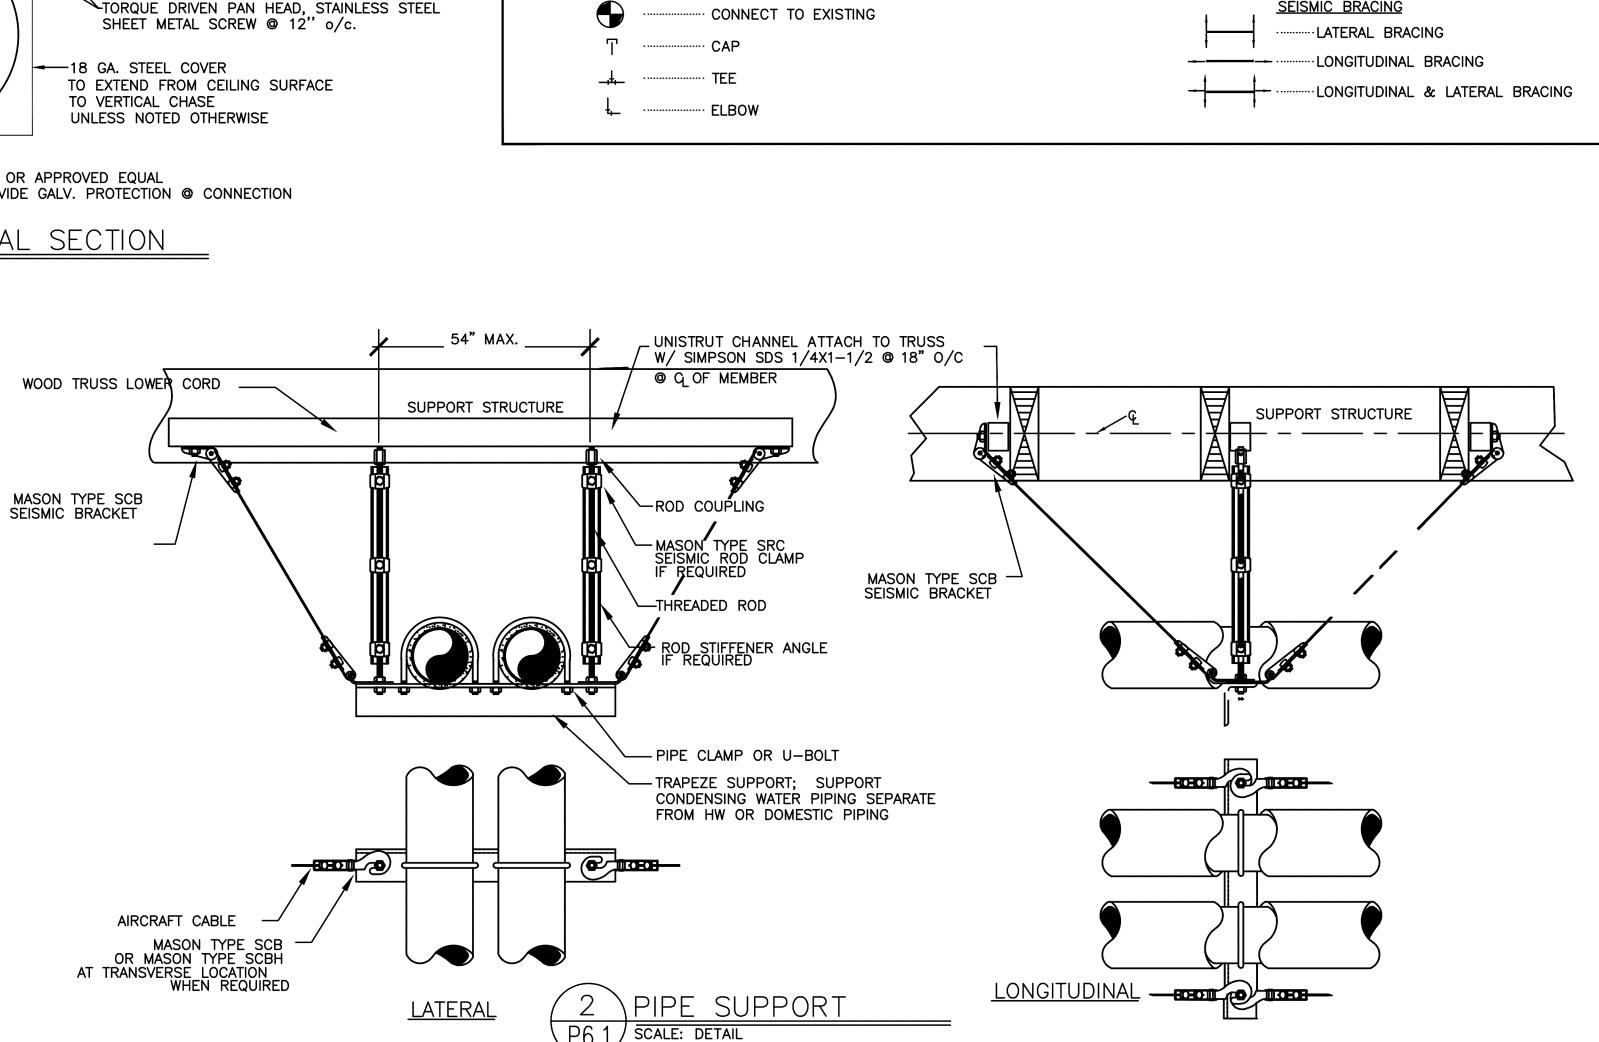


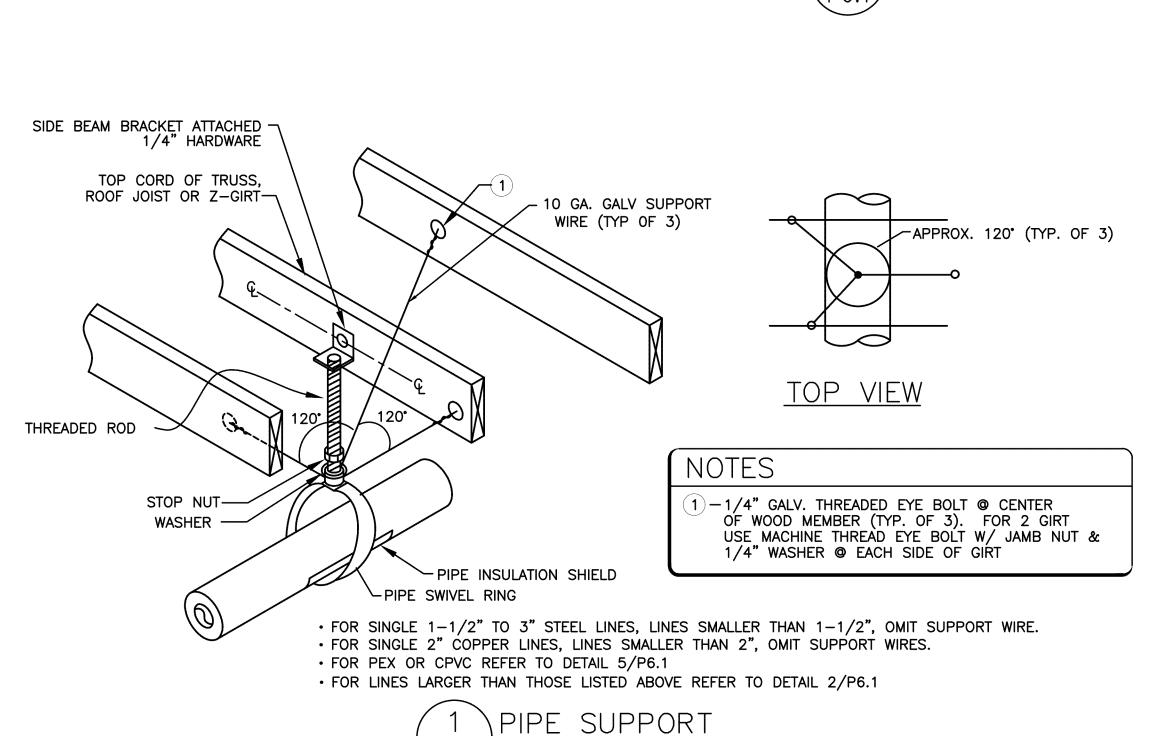

P6.1 | SCALE: DETAIL

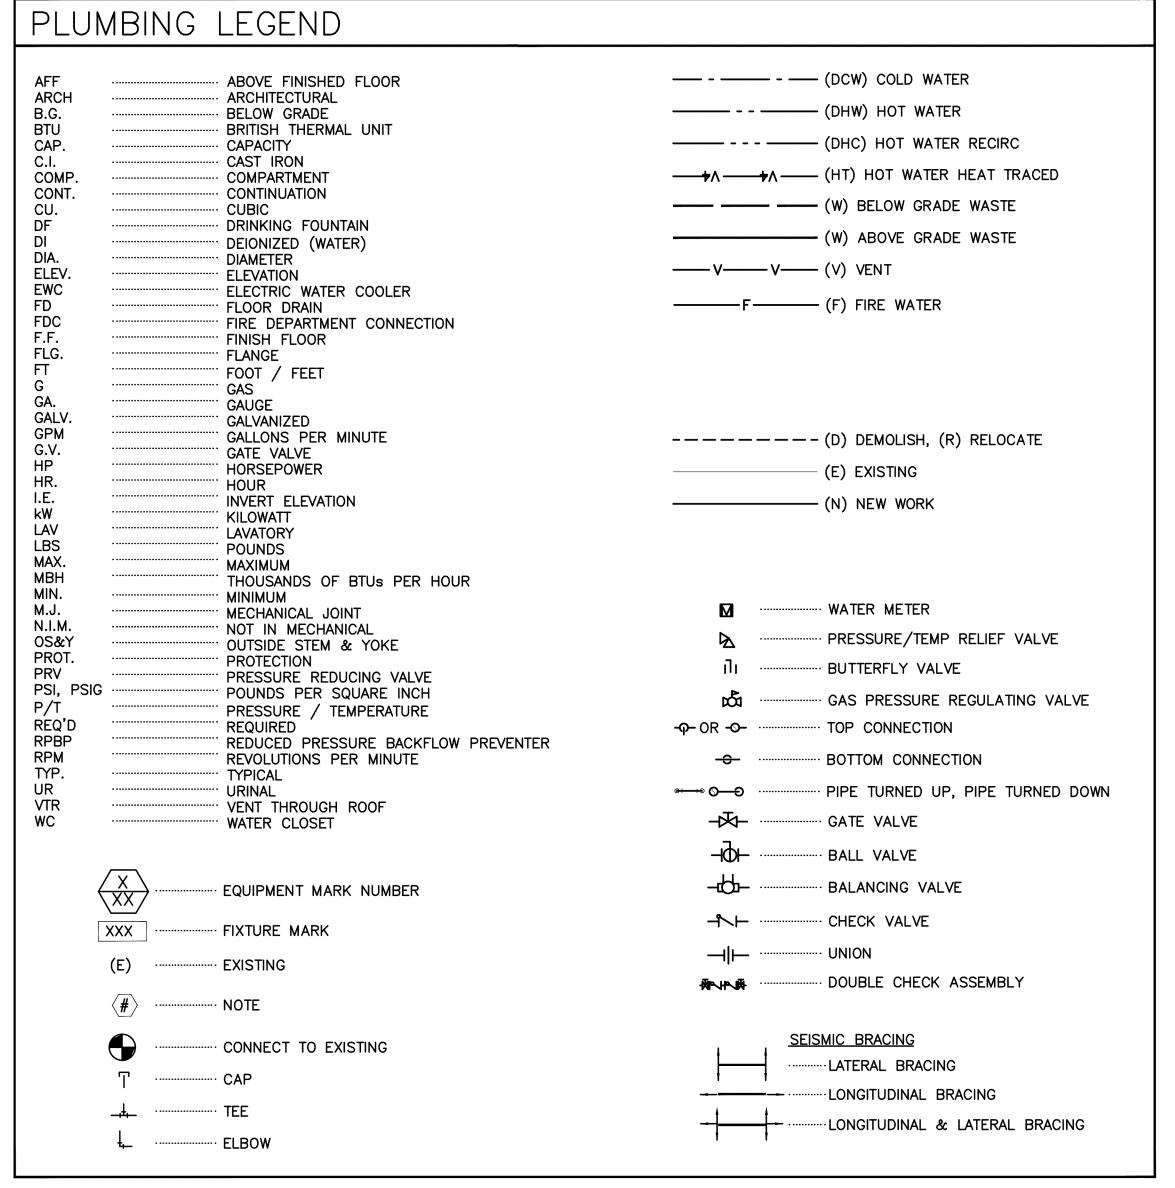



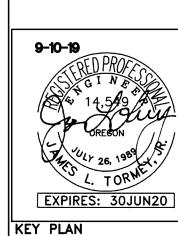


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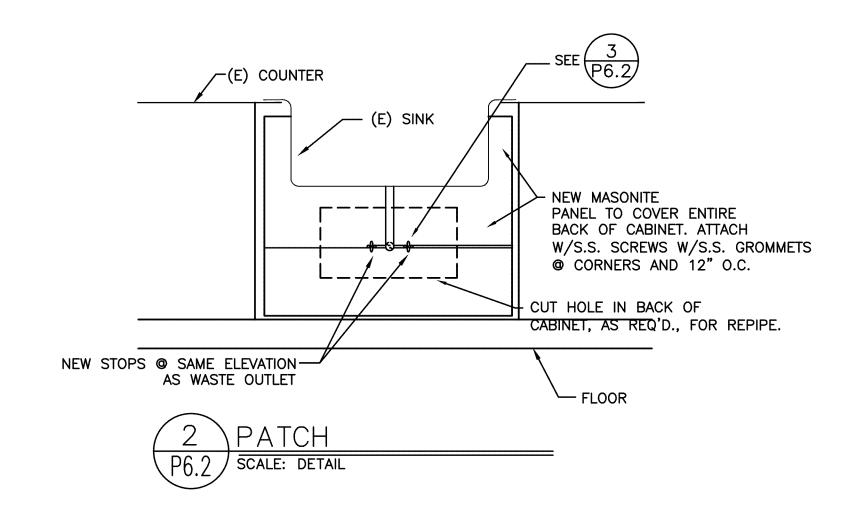
2019 Bond: Cri REPIPE AND F LIBERTY


SHEET TITLE PLUMBING SCHEDULES AND DETAILS

DRAWN SHEET JOB NO. P6.1 **7 OF** 10

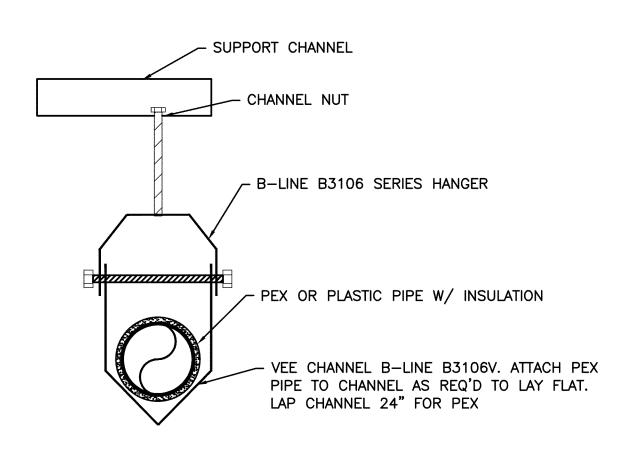


# PEX/CPVC SUPPORT DETAIL P6.2 SCALE: DETAIL




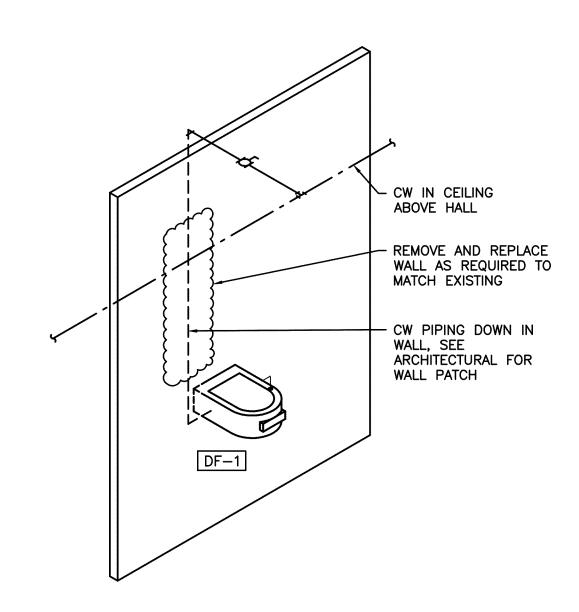


DRINKING FOUNTAIN PIPING
P6.2 SCALE: DETAIL

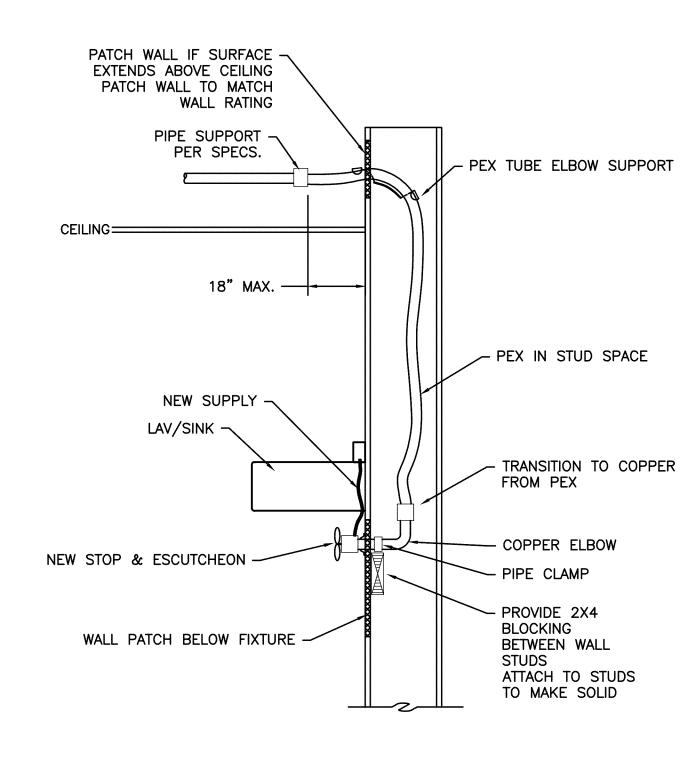




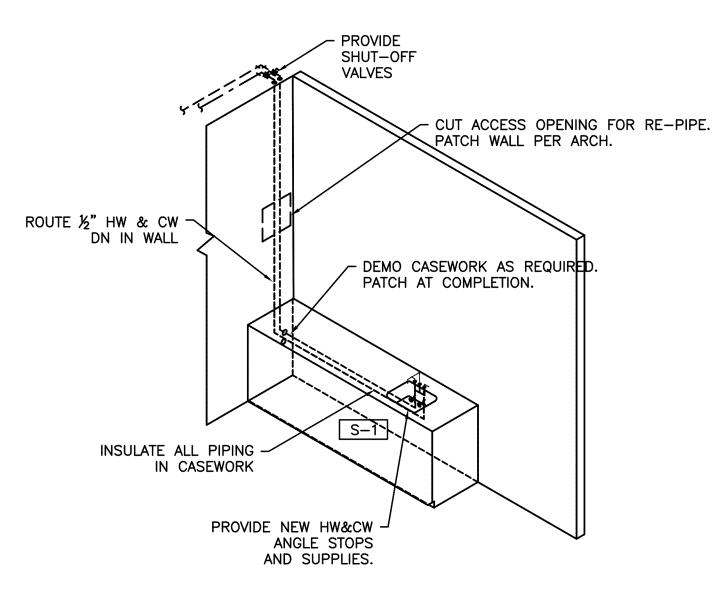

6 SINK 'S-1' PIPING
P6.2 SCALE: DETAIL

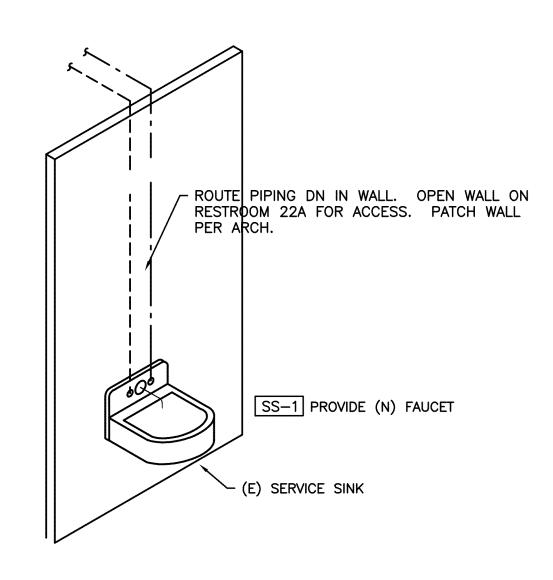

4 SERVICE SINK 'SS-1' PIPING P6.2 SCALE: DETAIL

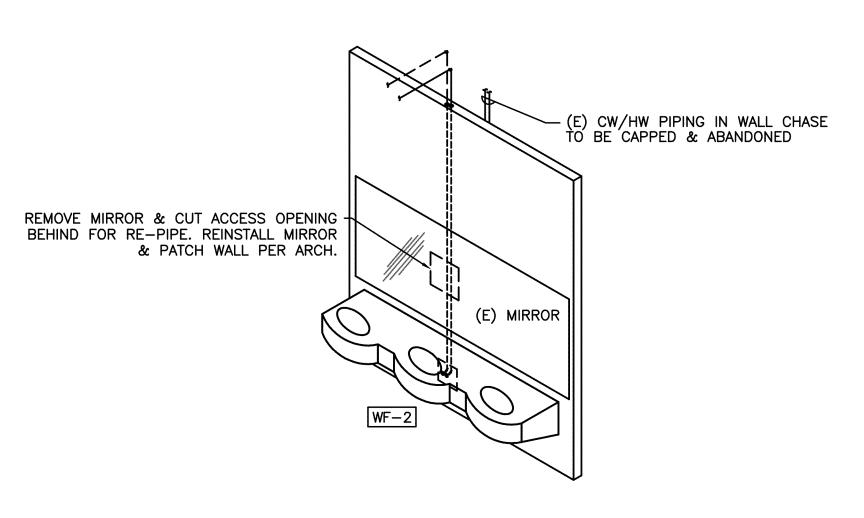

7 WASH FOUNTAIN
P6.2 SCALE: DETAIL

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SHEET TITLE


2019 Bond: Crit REPIPE AND F LIBERTY

SHEET TITLE PLUMBING DETAILS


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P6.2

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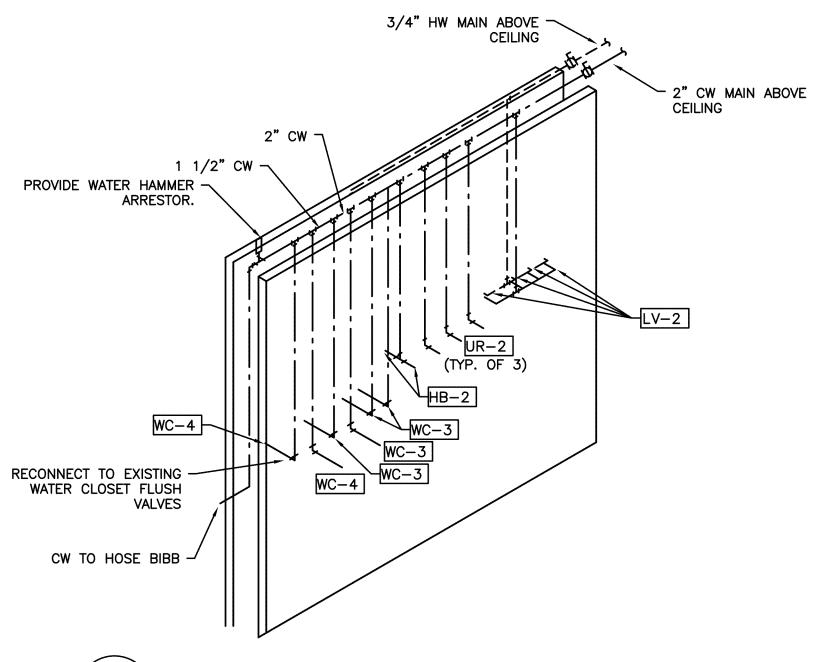




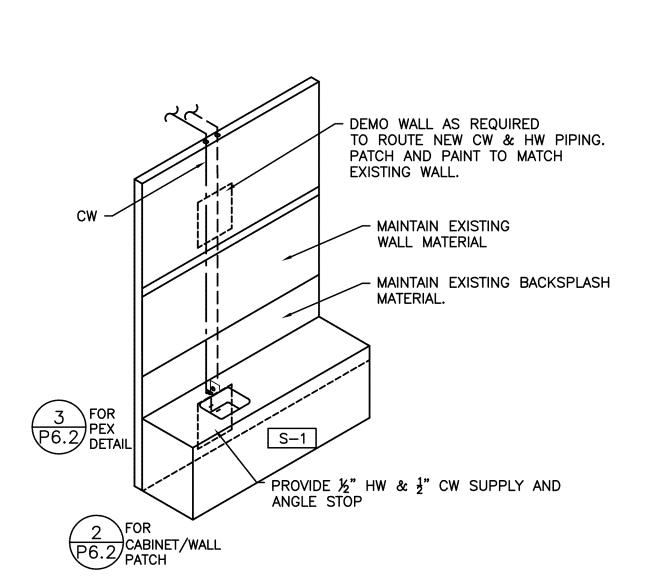


2 SINK AND HOSE BIBB P6.3 SCALE: DETAIL

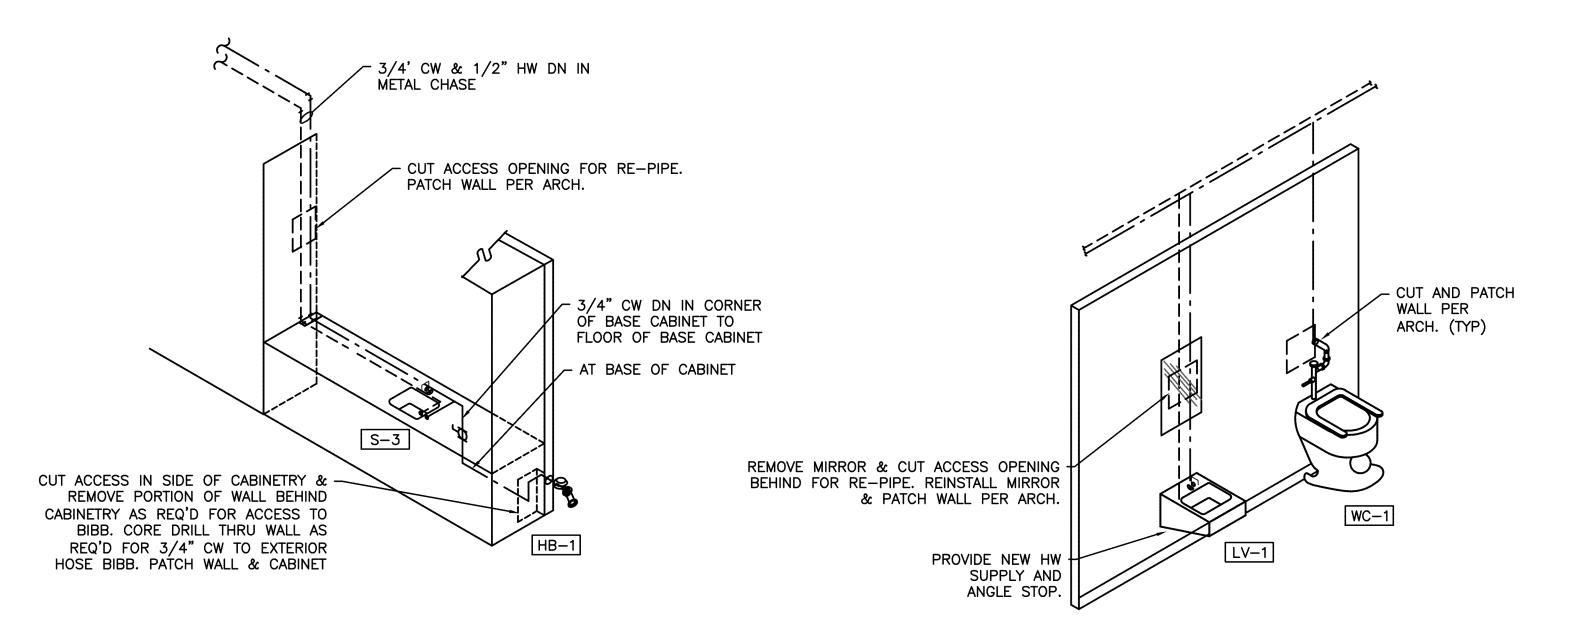






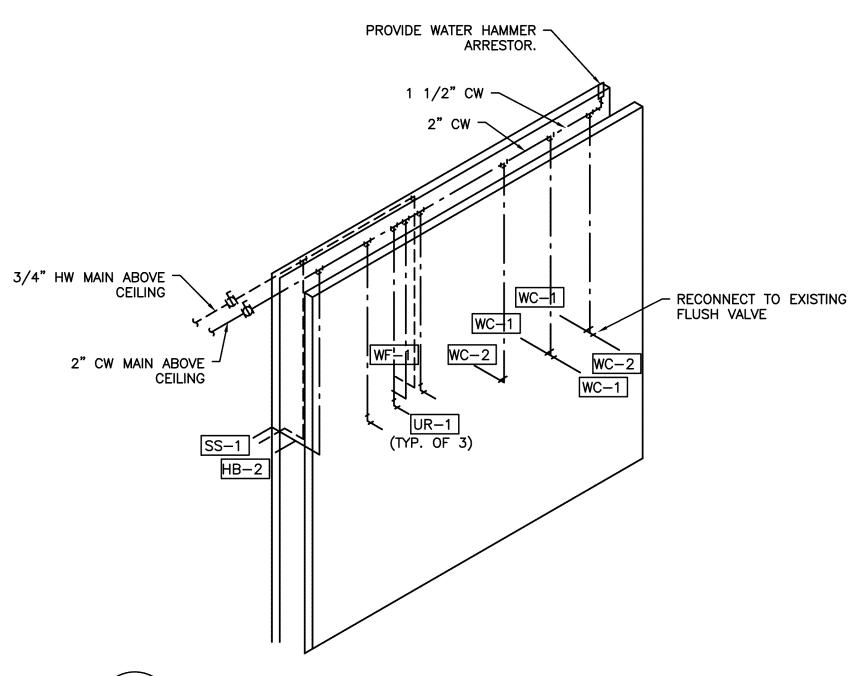

P6.3 RESTROOM 23&24 DISTRIBUTION PIPING

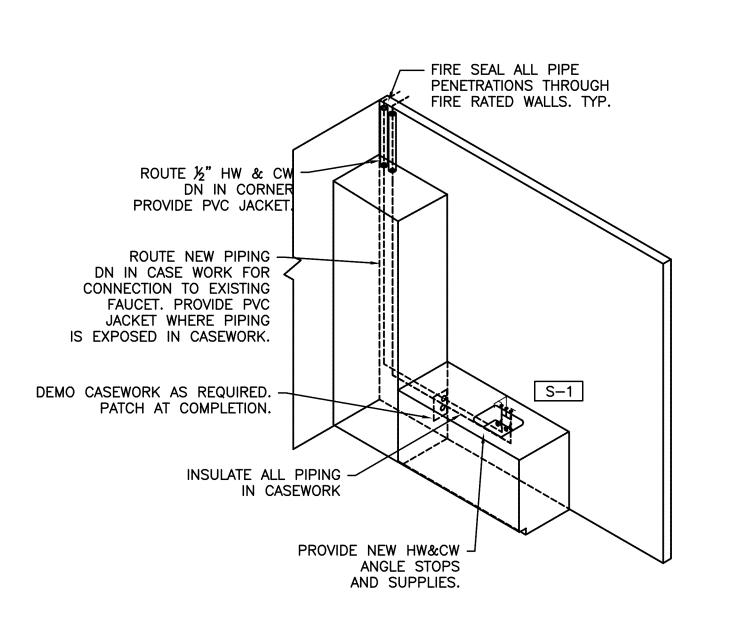

6 SINK 'S-1'
P6.3 SCALE: DETAIL

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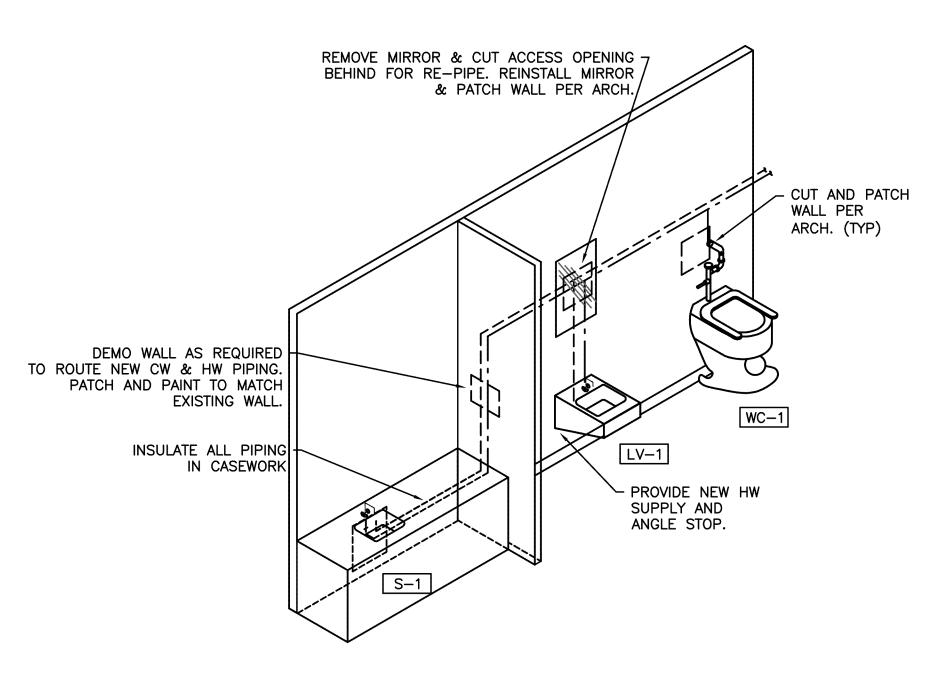
2019 Bond: Critical Facilities Upgrades REPIPE AND REMODEL LIBERTY ELEMENTARY SC

SHEET TITLE
PLUMBING DETAILS

JOB NO.

DATE
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1 SINK / RESTROOM PIPING P6.4 SCALE: DETAIL

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SUITE 5
SALEM, OR 97301
V: 503.371.1140
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