




SIGN SECTION

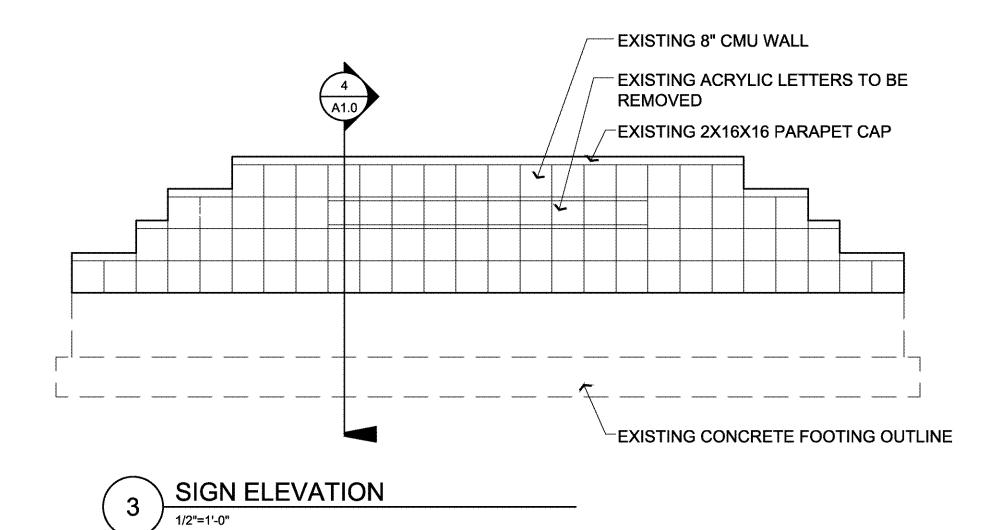

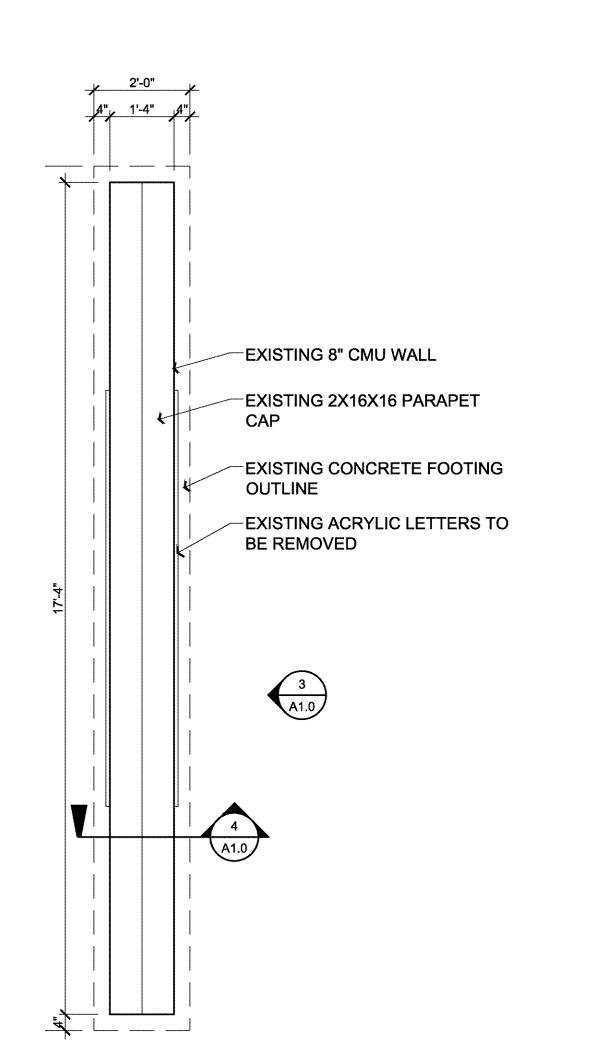

2 SIGN PLAN
1/2"=1'-0"

SITE PLAN
1/32"=1'-0"

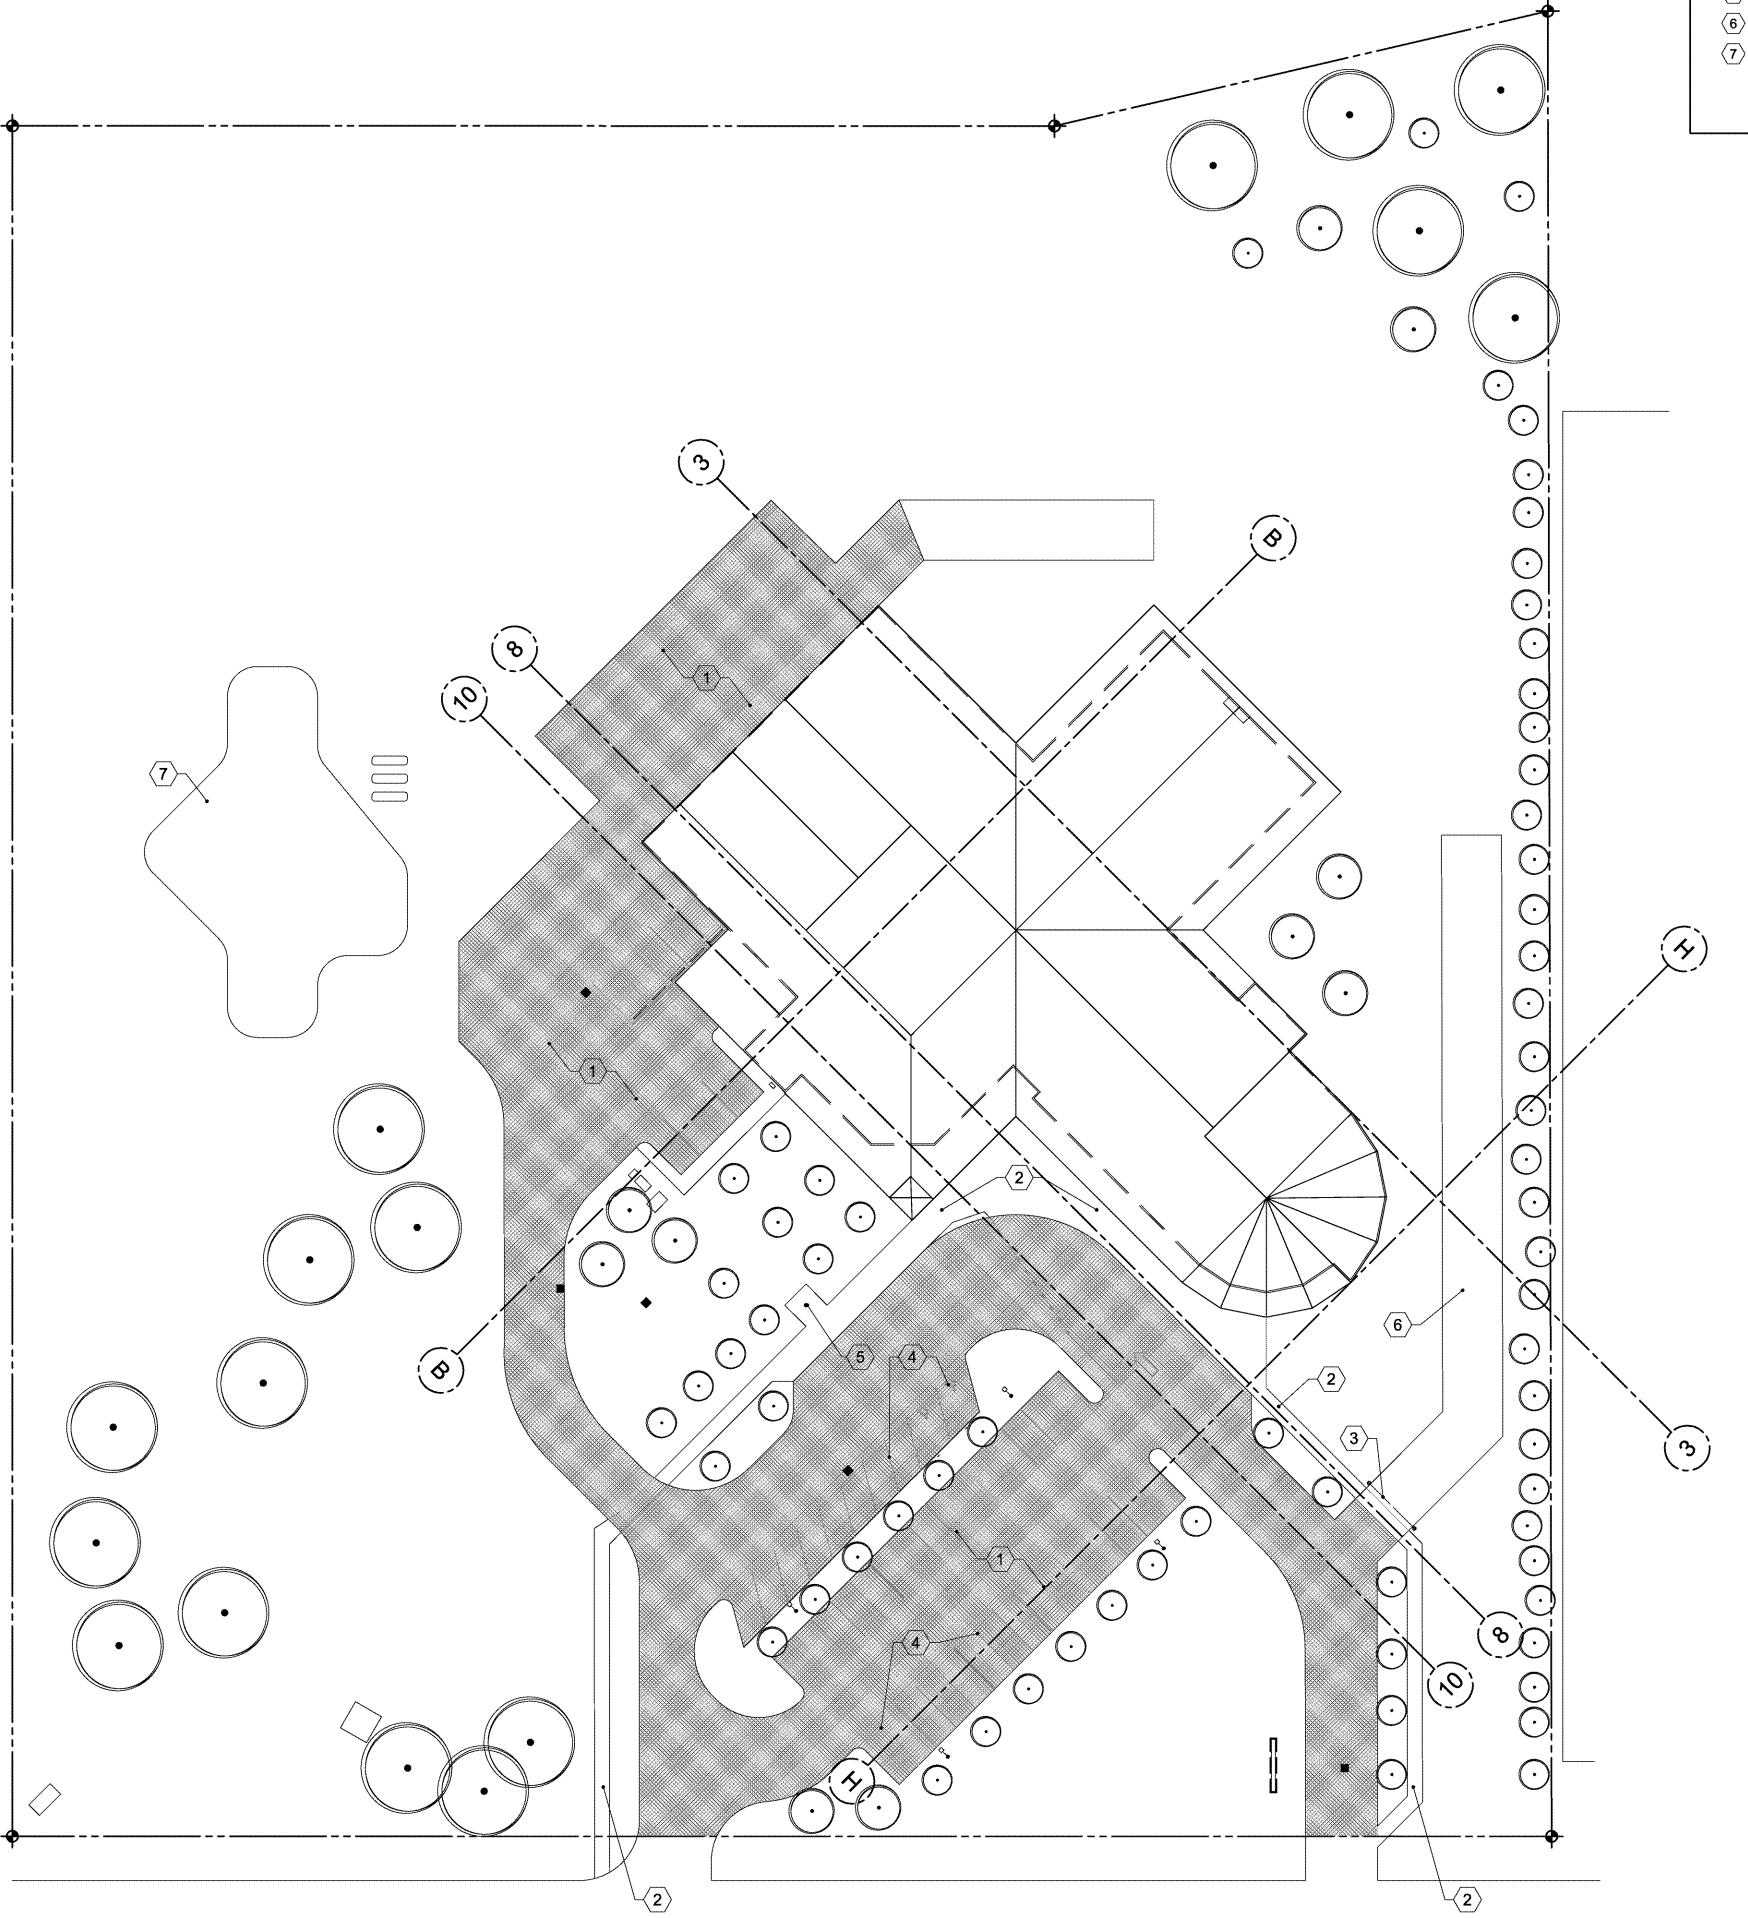

GENERAL NOTES:

- 1. GENERAL NOTES APPLY TO ALL DRAWINGS
- 2. DIMENSIONS ARE TO FACE OF STUDS, FACE OF MASONRY AND FACE OF CONCRETE, UNLESS OTHERWISE NOTED. ("CLEAR" DIMENSION IS TO FACE OF FINISHED SURFACE).
- 3. DRAWINGS ARE DIAGRAMMATIC ONLY AND SHOULD NOT BE SCALED. NOTIFY ARCHITECT OF ANY DISCREPANCIES OR QUESTIONABLE DIMENSIONS FOR CLARIFICATION PRIOR TO PROCEEDING WITH AREA OF REQUIRED WORK.
- 4. THE CONTRACTOR SHALL DETERMINE THE EXACT LOCATION OF ALL EXISTING UTILITIES BEFORE COMMENCING WORK AND AGREES TO BE FULLY RESPONSIBLE FOR ANY AND ALL DAMAGES WHICH MIGHT BE OCCASIONED BY THE CONTRACTOR'S FAILURE TO EXACTLY LOCATE AND PRESERVE ANY AND ALL UNDERGROUND UTILITIES.

KEY NOTES:

SYM. DESCRIPTION 1 EXISTING ASPHALT PAVING TO REMAIN

- EXISTING CONCRETE SIDEWALK TO REMAIN
- EXISTING GATE TO REMAIN
- EXISTING PARKING, CROSSWALK AND HANDICAP STRIPS TO REMAIN
- EXISTING FLAG POLE TO REMAIN
- EXISTING FIRE TRUCK ACCESS ROAD PER MARION COUNTY STANDARDS
- (7) EXISTING PLAYGROUND TO REMAIN, NO WORK THIS AREA

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SCOTT EDWARDS ARCHITECTURE LLP

2525 E. Burnside St., Portland, OR 97214 phone:(503) 226-3617 www.seallp.com

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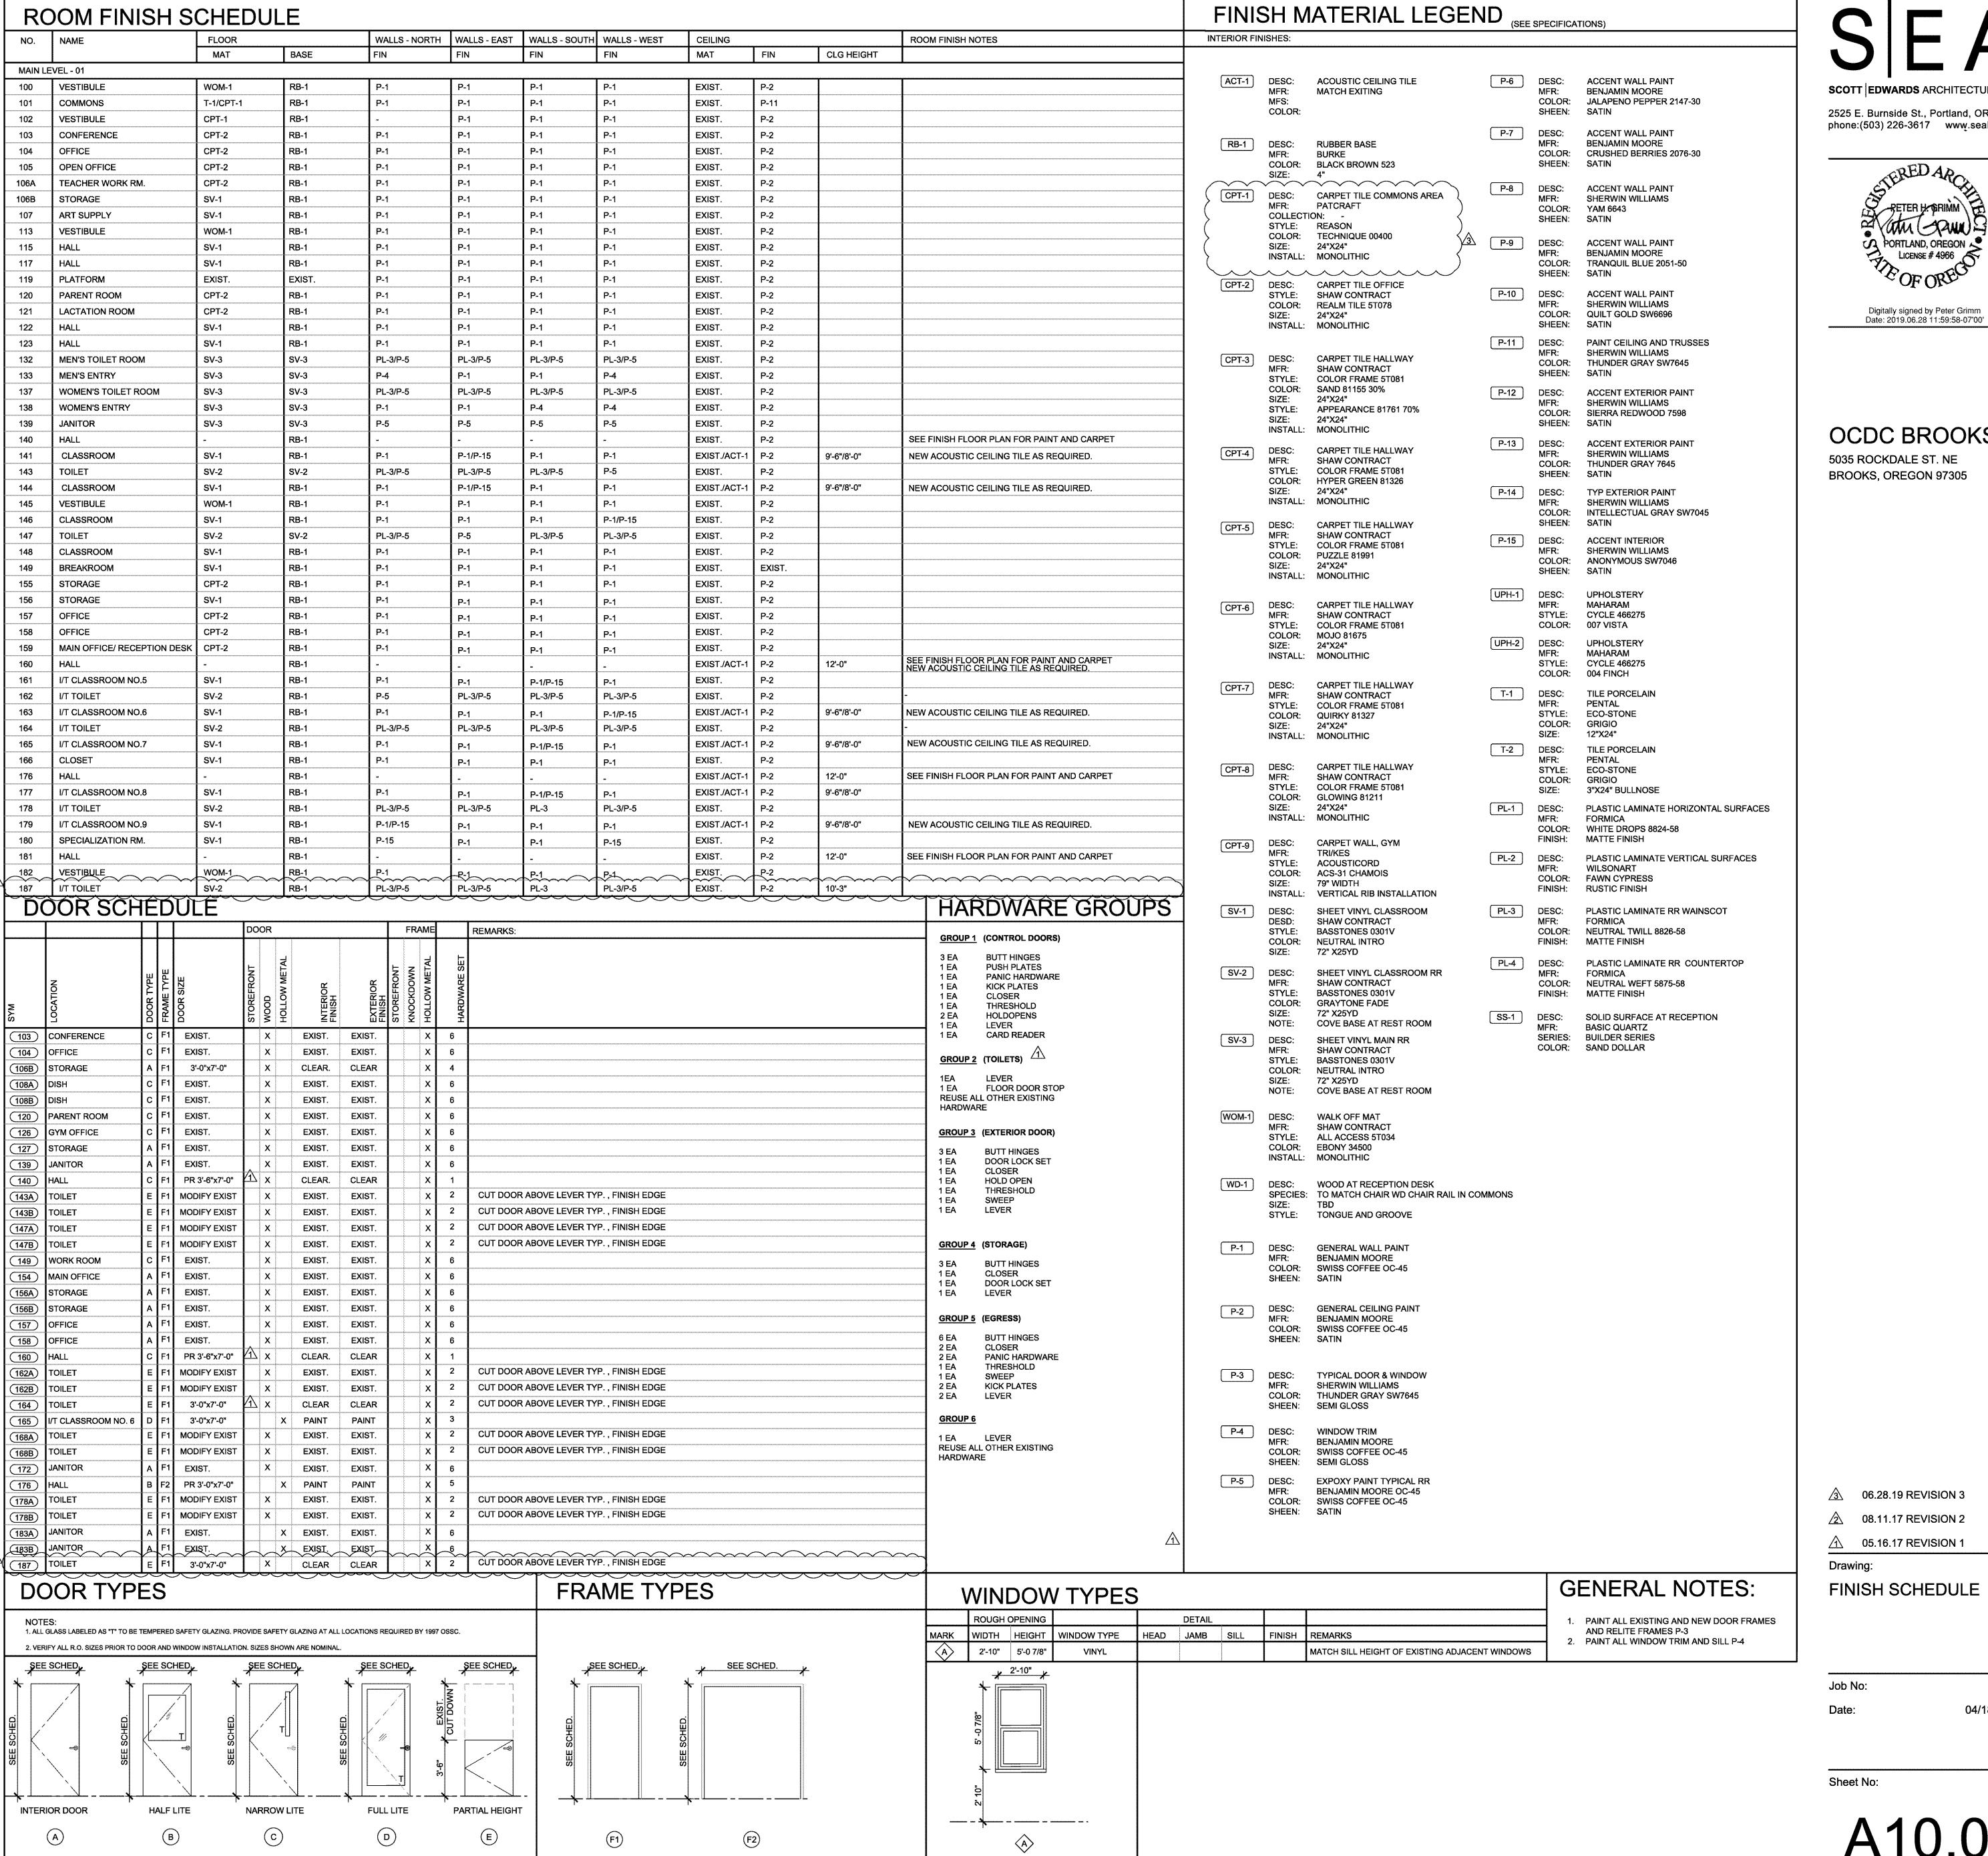
2 08.11.17 REVISION 2

△ 05.16.17 REVISION 1

SITE PLAN

04/18/2017

17016



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OCDC BROOKS 5035 ROCKDALE ST. NE

3 06.28.19 REVISION 3


2 08.11.17 REVISION 2

FINISH SCHEDULE

04/18/2017

Sheet No:

17016

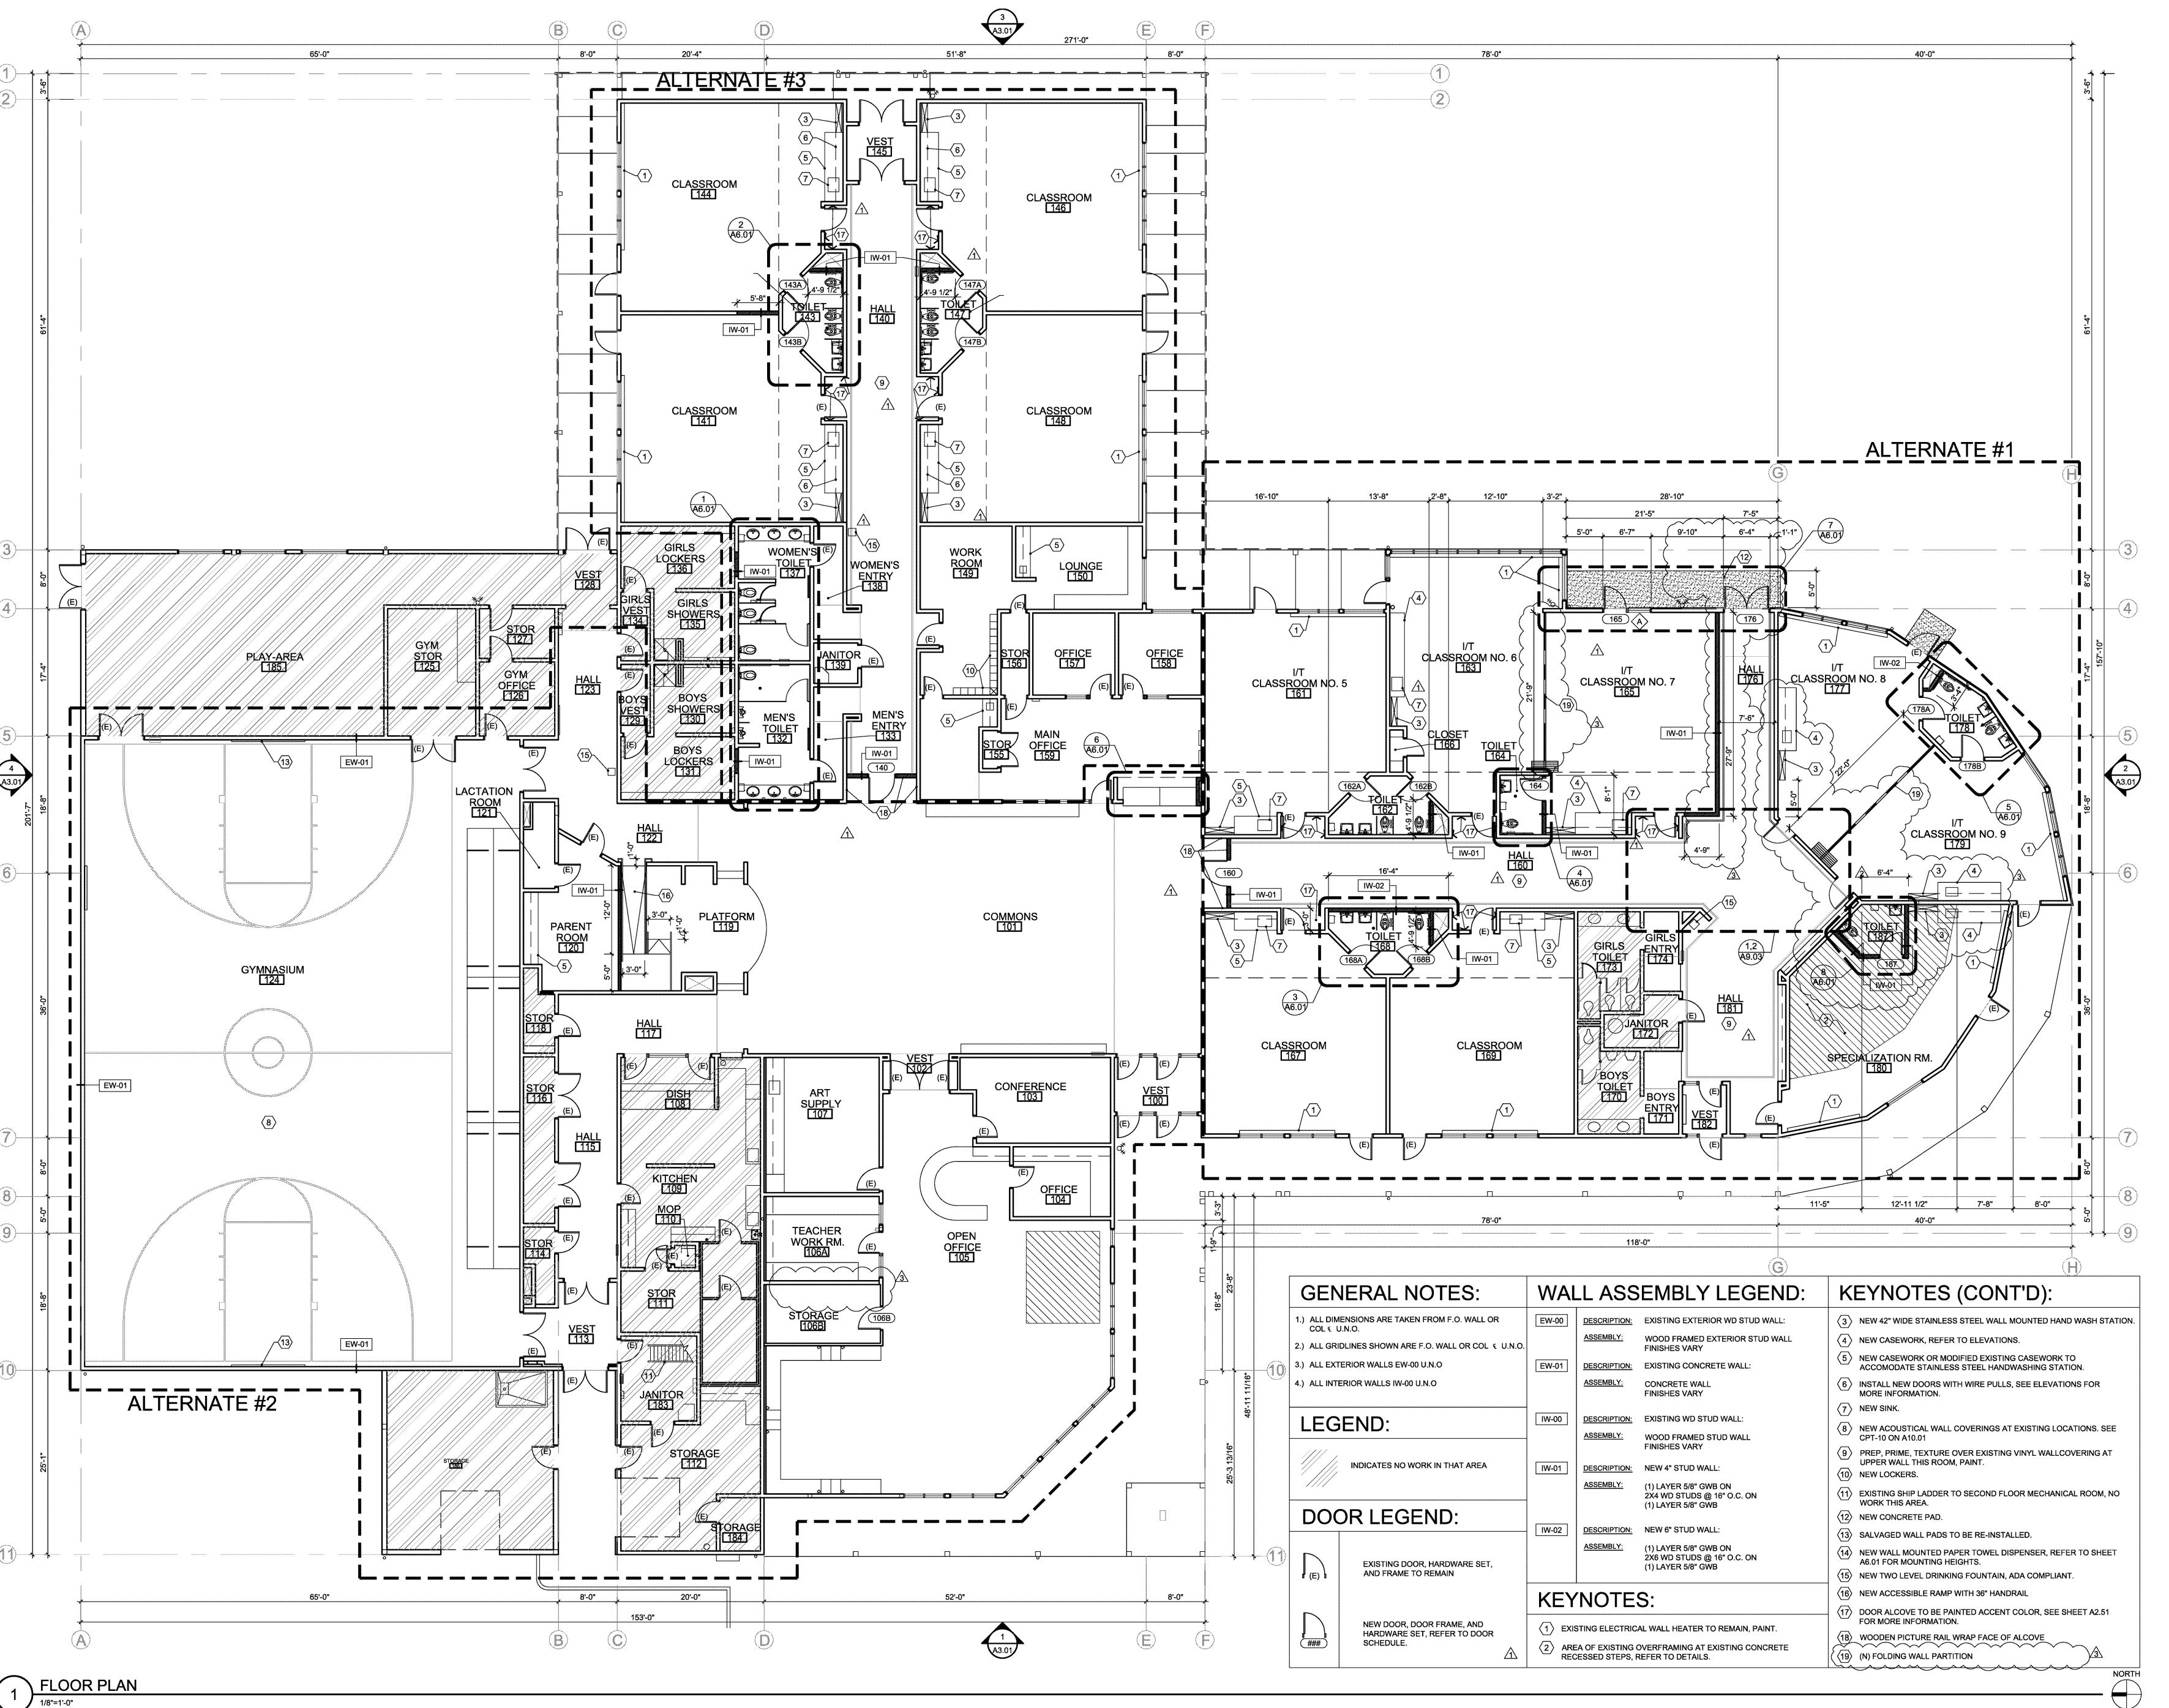

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5035 ROCKDALE ST. NE BROOKS, OREGON 97305

3 06.28.19 REVISION 32 08.11.17 REVISION 2

05.16.17 REVISION 2


Drawing:
FLOOR PLAN

Job No:

te: 04/18/2017

Sheet No:

A2.11

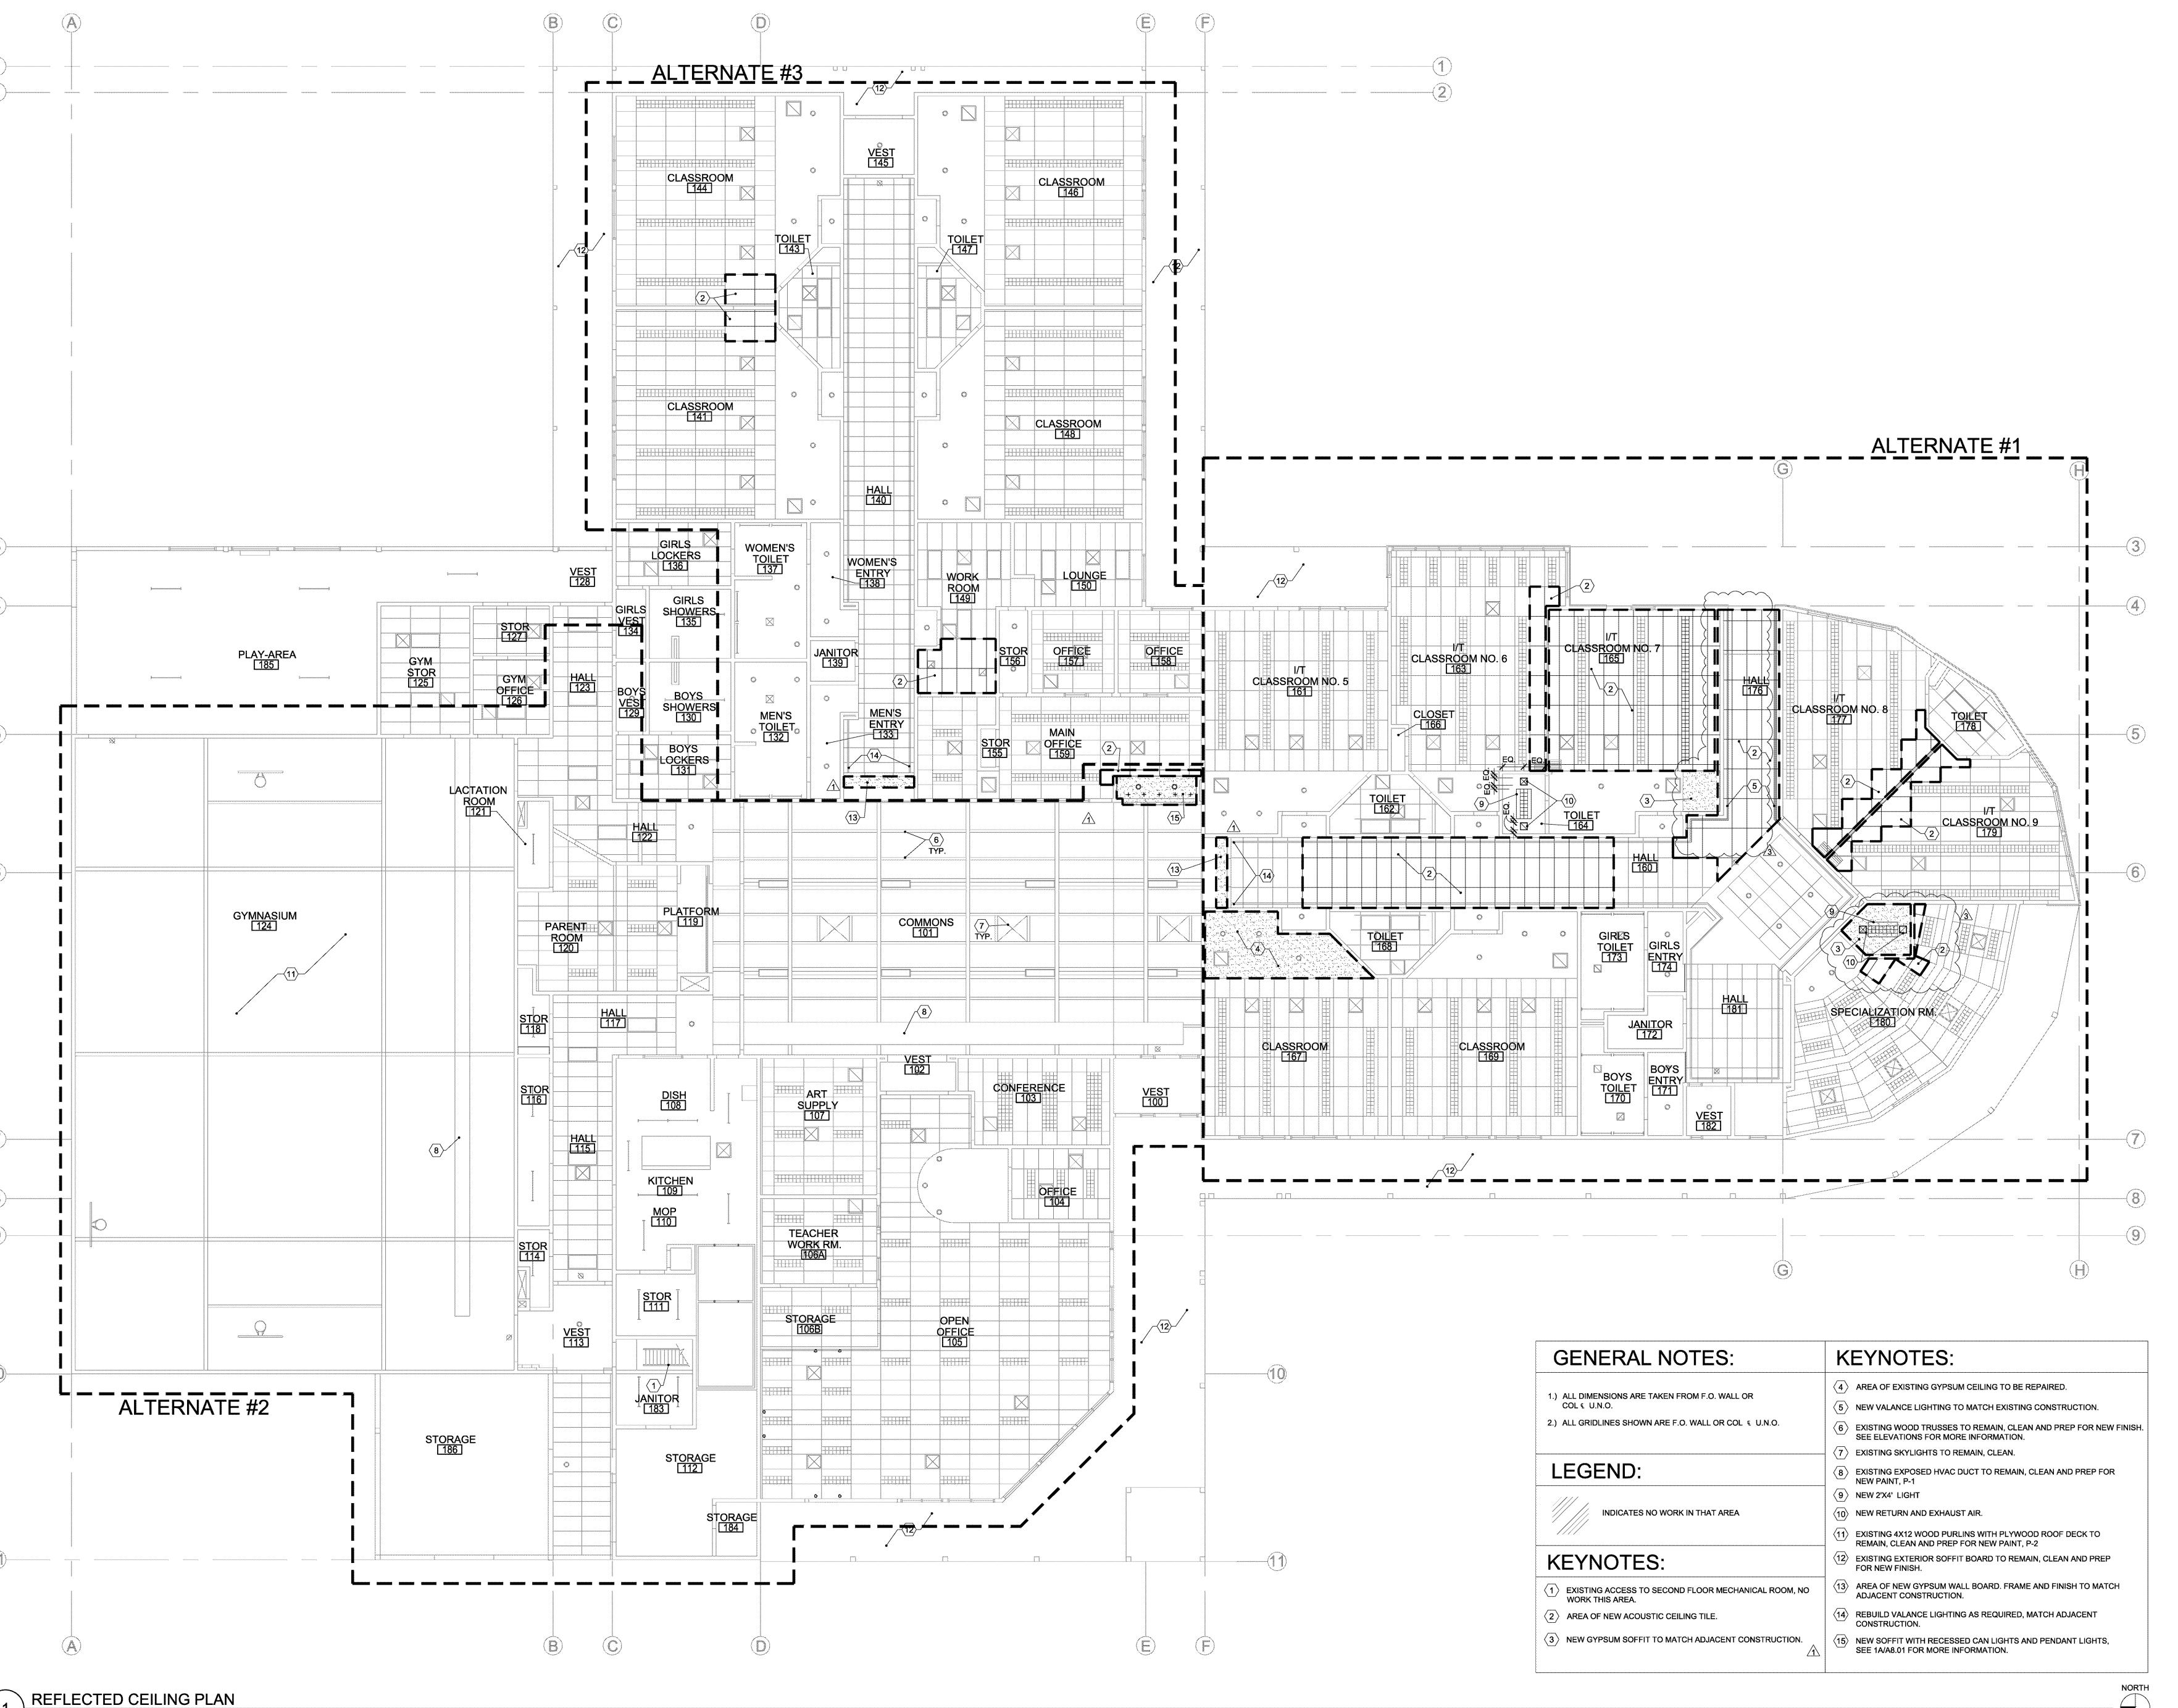

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5035 ROCKDALE ST. NE BROOKS, OREGON 97305

3 06.28.19 REVISION 3

08.11.17 REVISION 2

05.16.17 REVISION 1

Drawing:
REFLECTED CEILING


PLAN

Job No:

Sheet No:

A2.31

17016

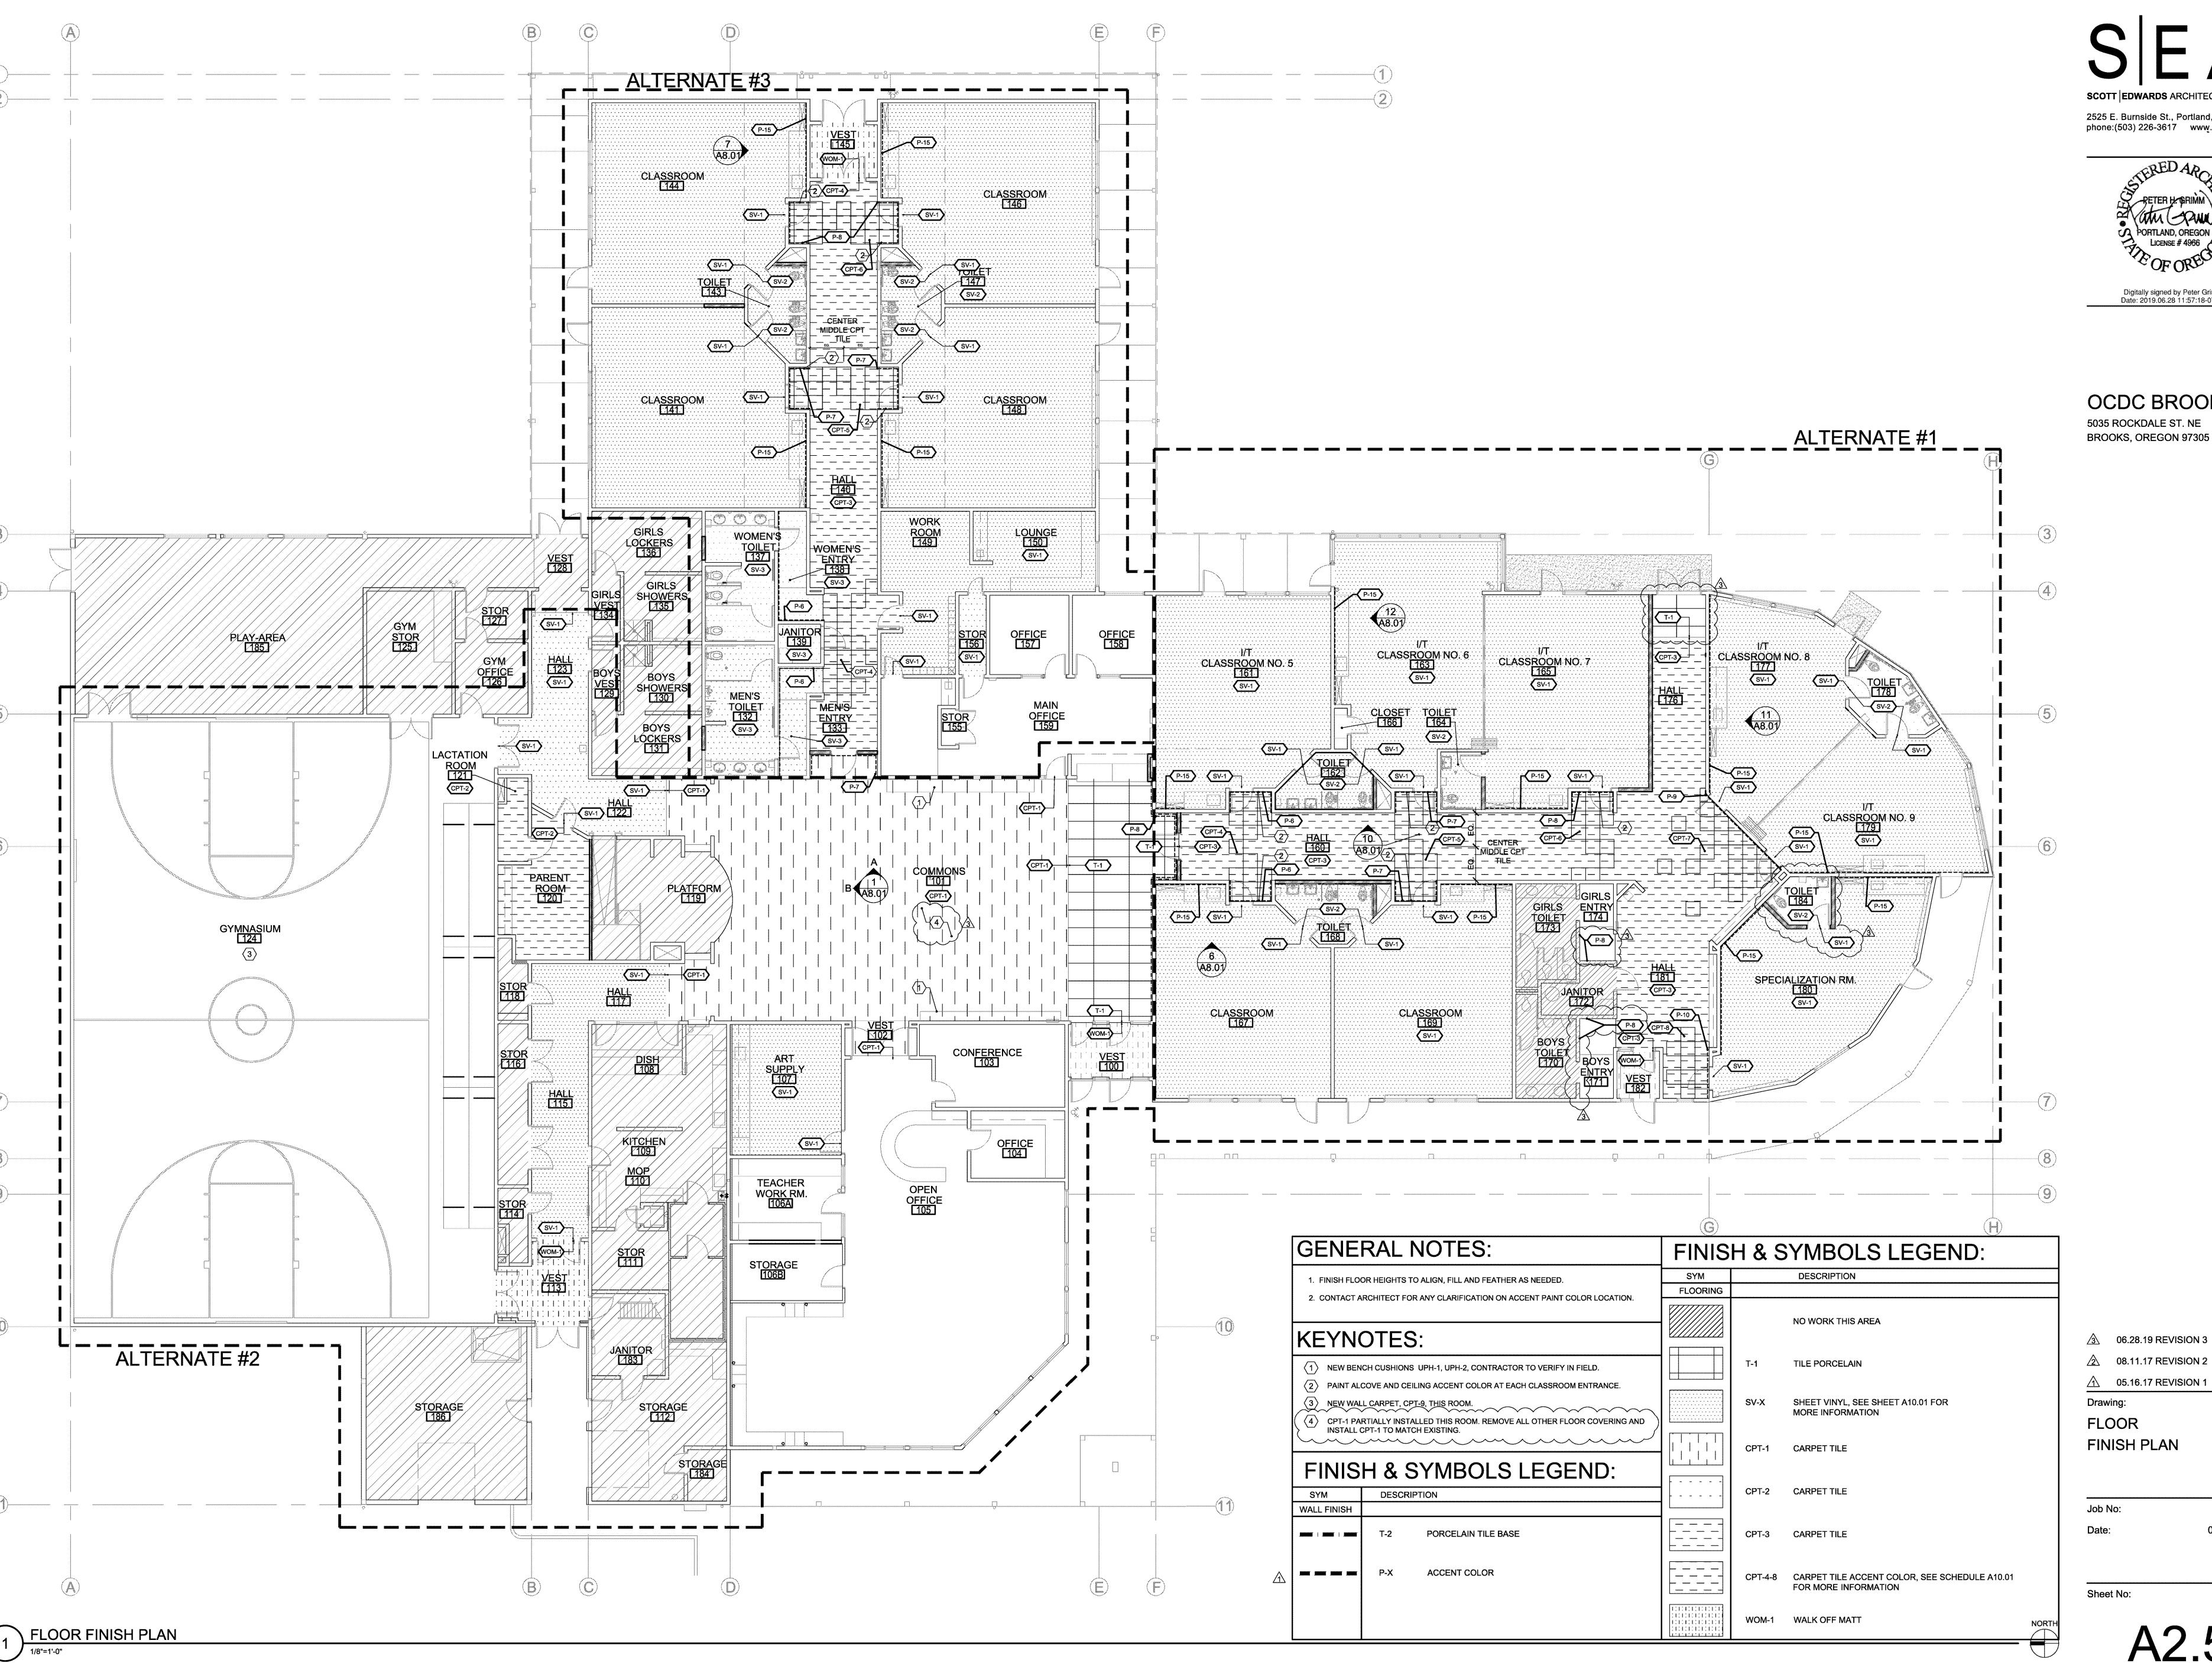

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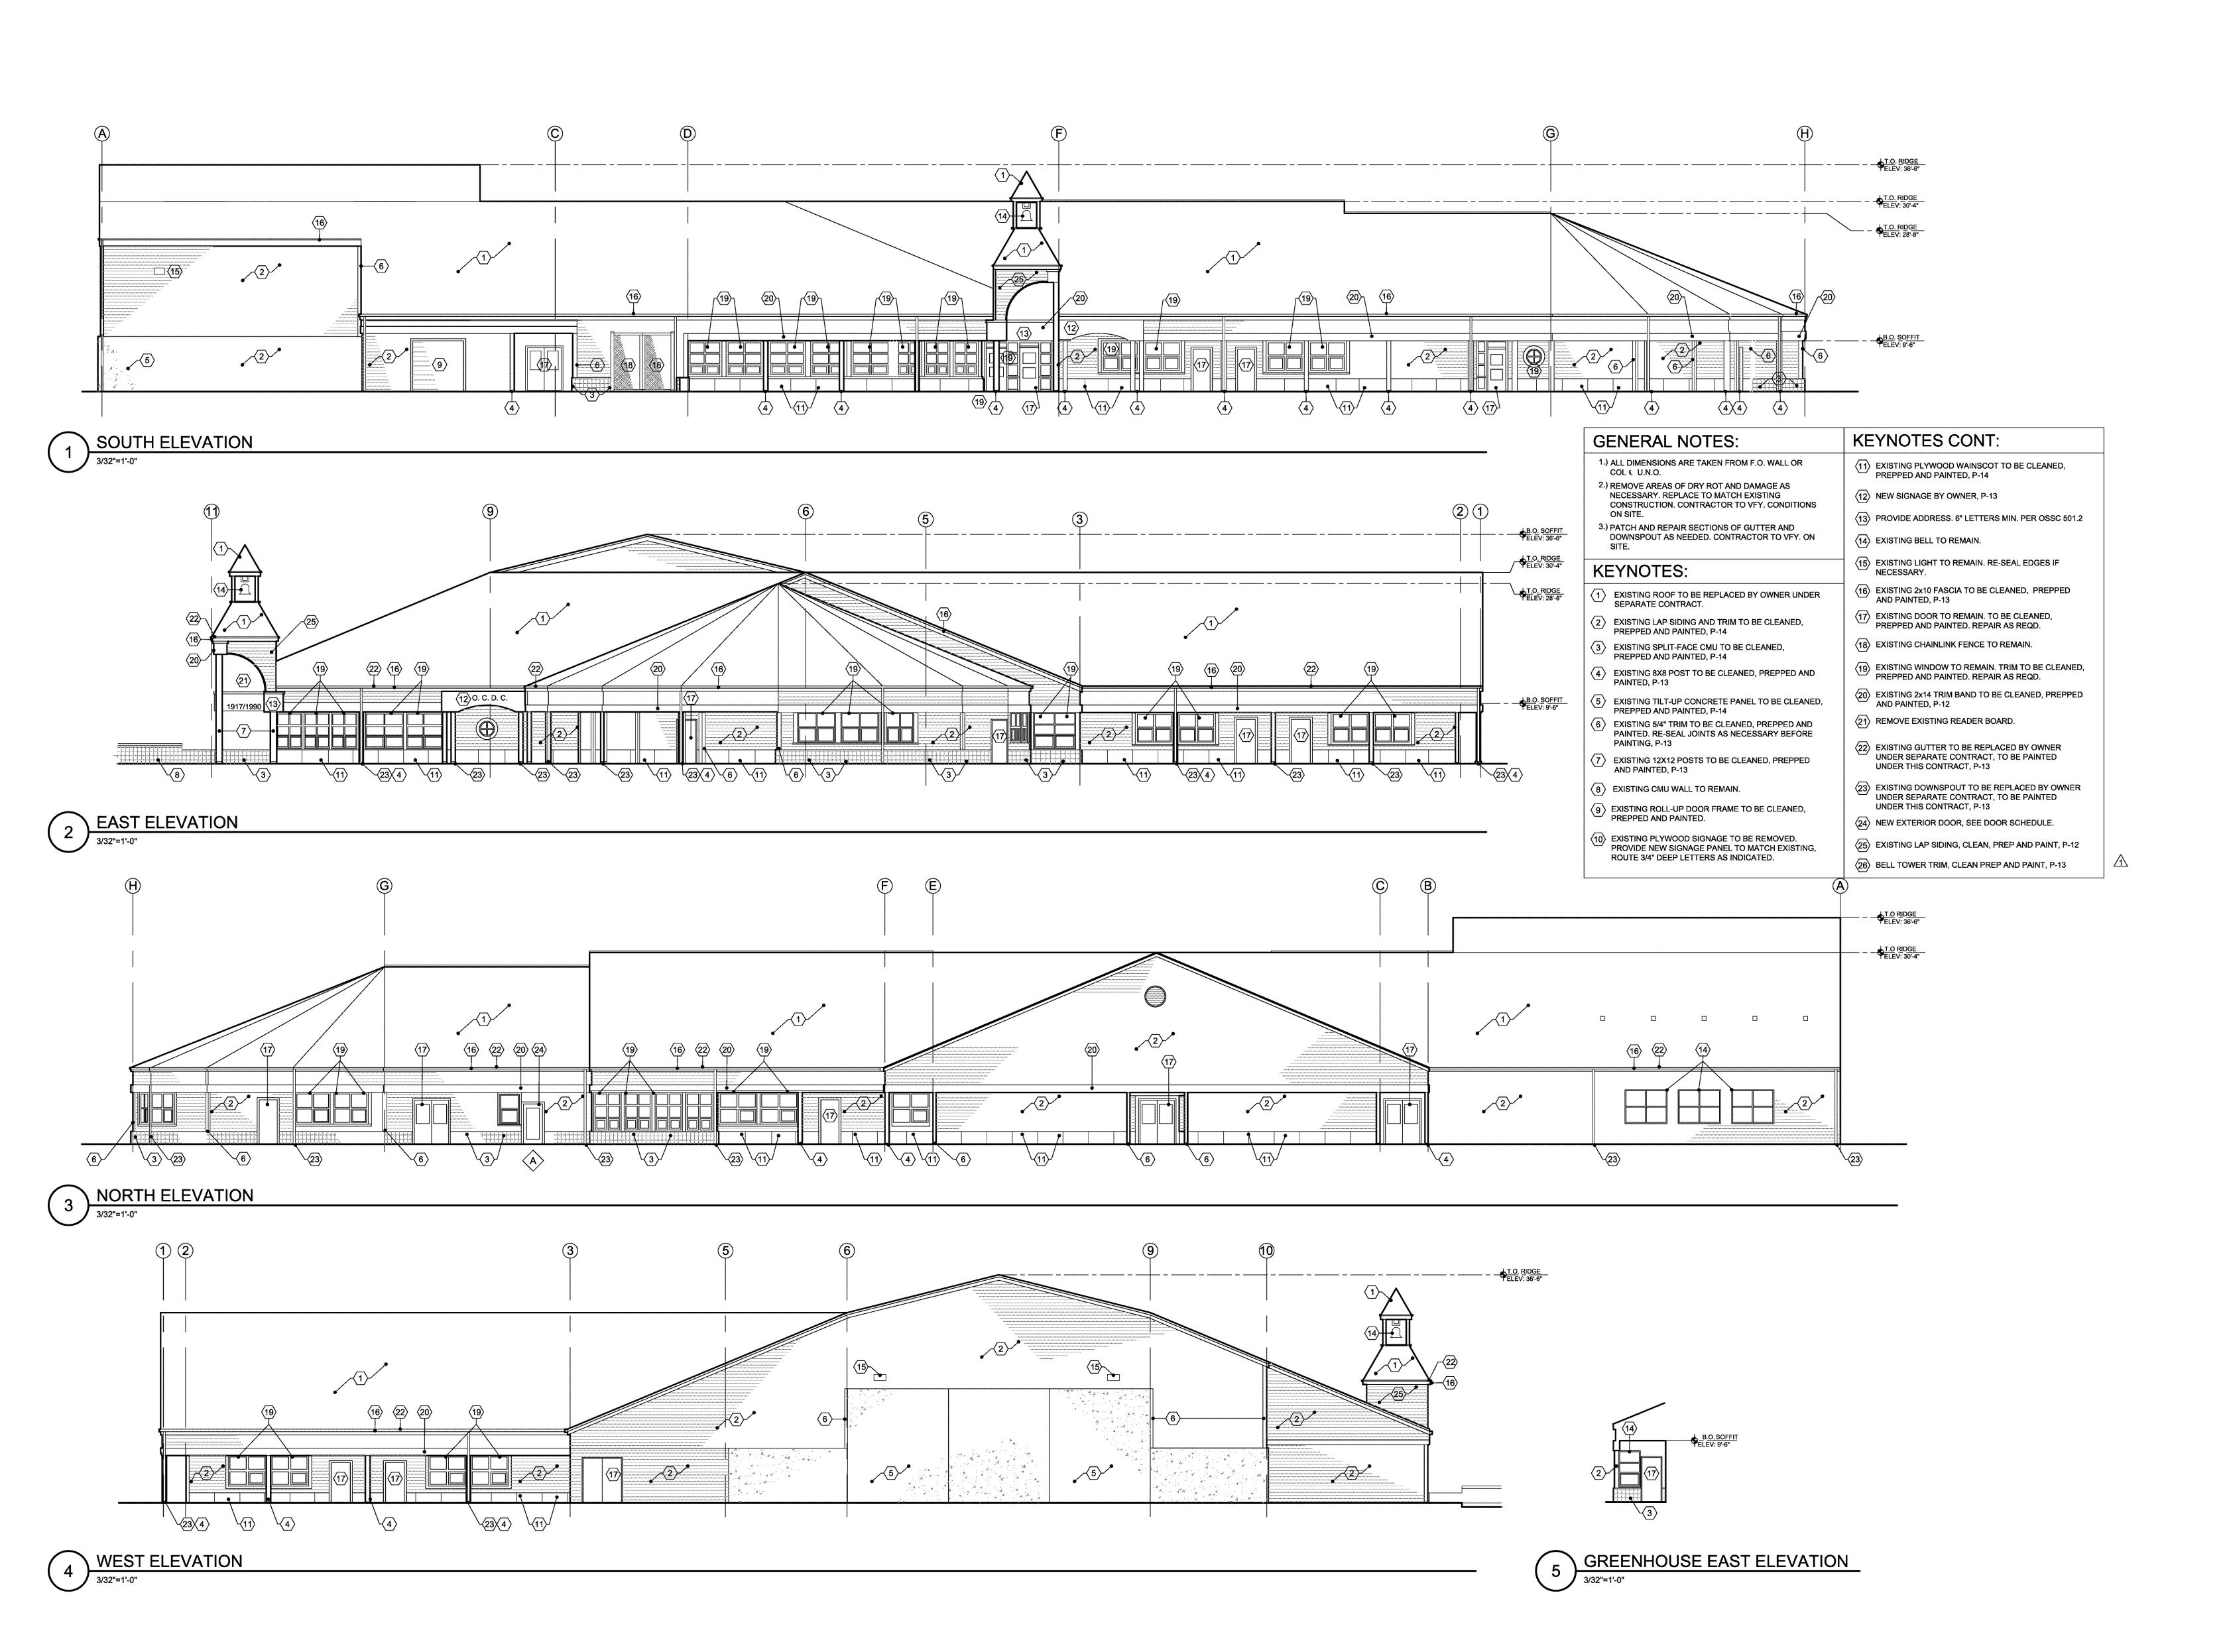
OCDC BROOKS 5035 ROCKDALE ST. NE

2 08.11.17 REVISION 2

FLOOR FINISH PLAN

Sheet No:

17016





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3 06.28.19 REVISION 32 08.11.17 REVISION 2

25 08.11.17 REVISION

<u>↑ 05.16.17 REVISION 1</u>


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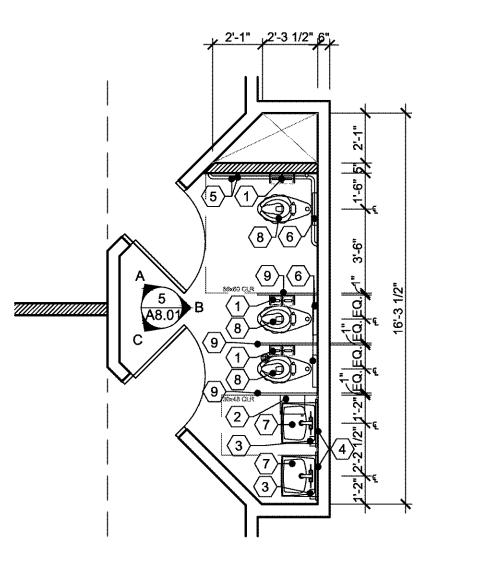
BUILDING ELEVATIONS

Job No: 17016


Date: 04/18/2017

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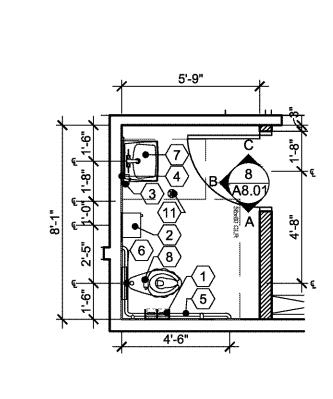


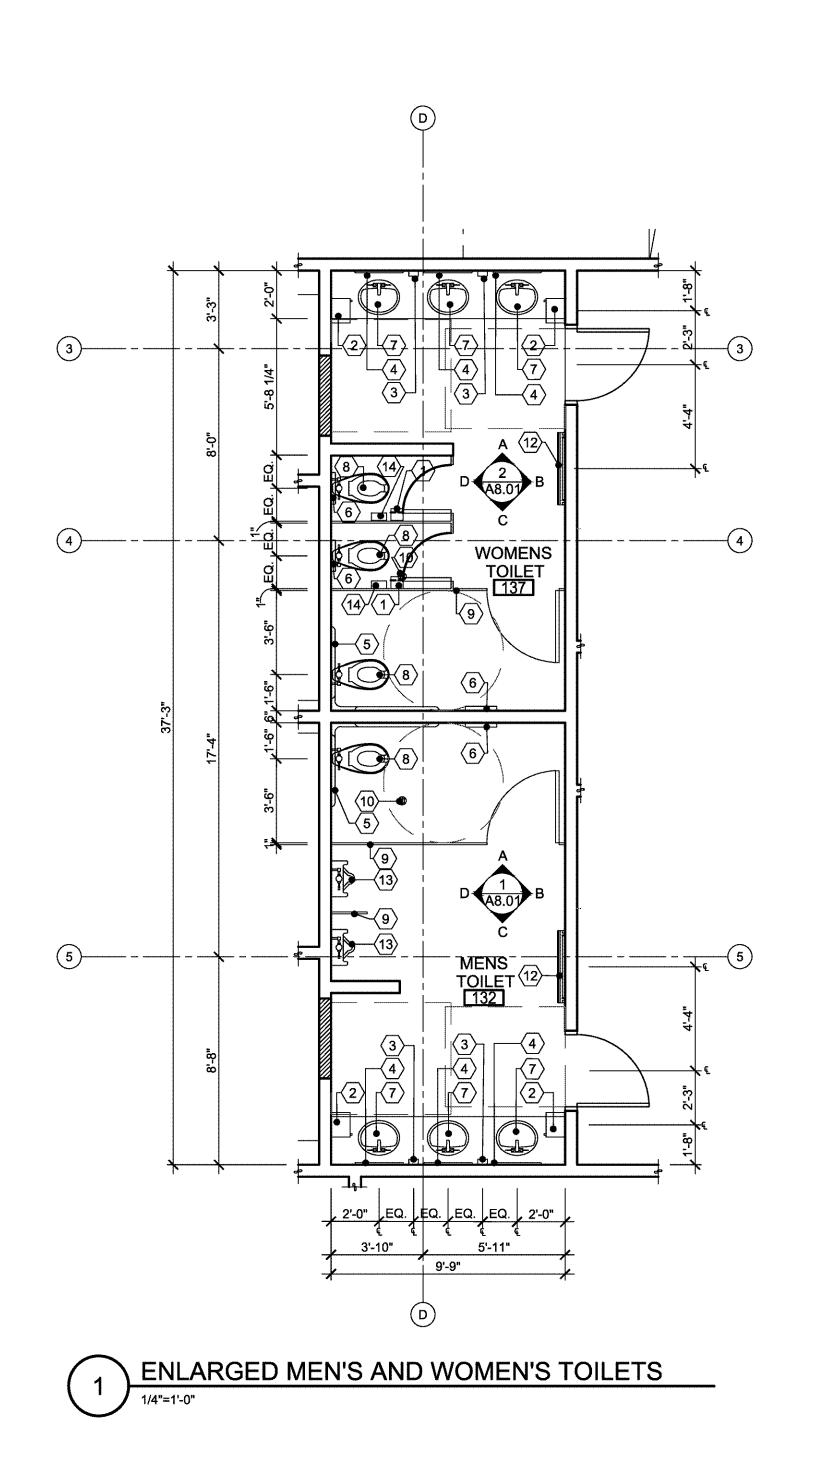


\ ENLARGED TYPICAL PRESCHOOL RESTROOM

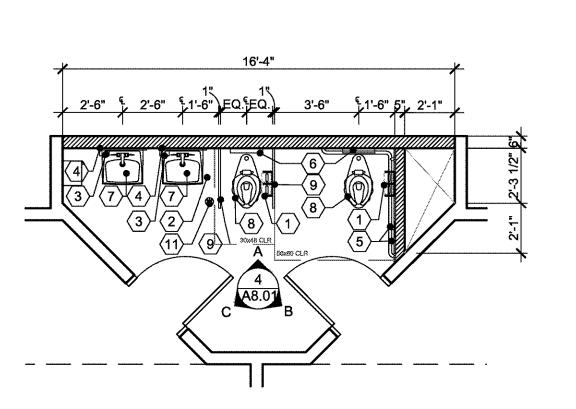


\ ENLARGED TYPICAL TODDLER RESTROOM



4 ENLARGED TOILET - ROOM 164

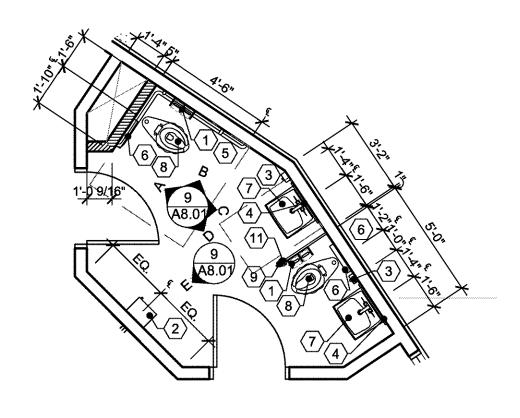


5 ENLARGED TOILET - ROOM 178

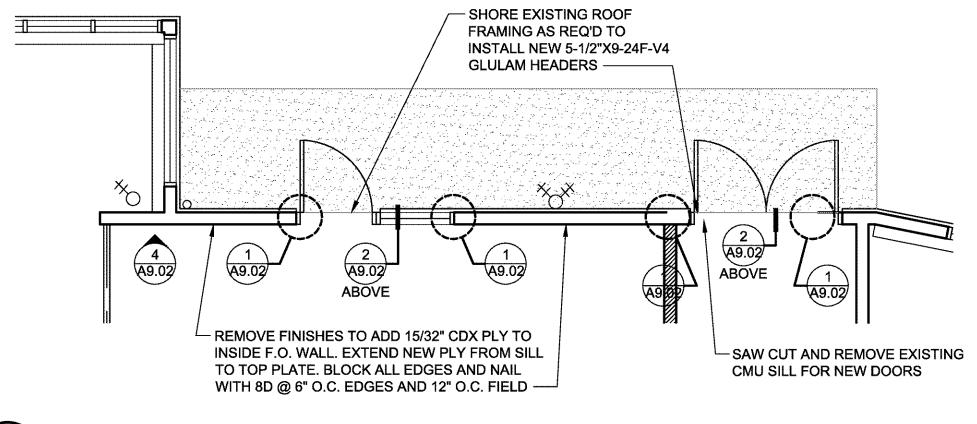


7 NEW EXTERIOR DOORS AND WINDOW

1/4"=1'-0"

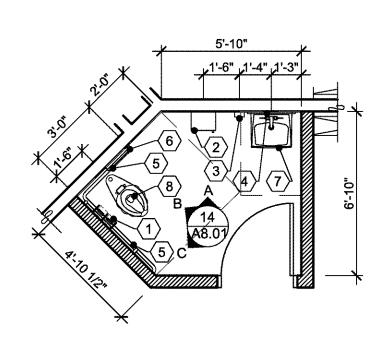

8 ENLARGED TOILET - ROOM 187

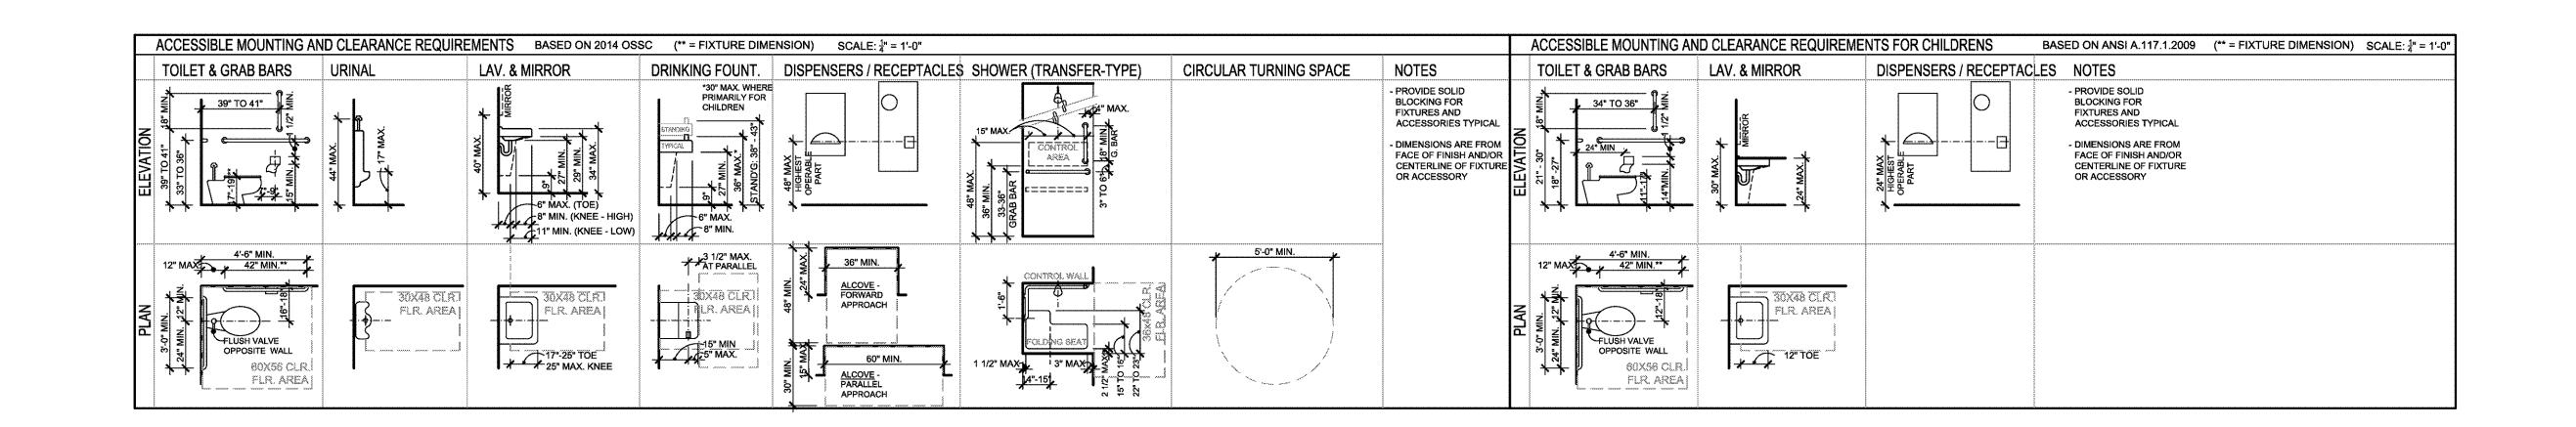


GENERAL NOTES:


- 1. REFER TO ROOM FINISH SCHEDULE AND SPECIFICATIONS FOR WALL AND FLOORING FINISHES REFER TO MOUNTAIN HEIGHT DIAGRAM THIS SHEET, FOR TYPICAL HEIGHT AND DIMENSIONS FOR TOILET ACCESSORIES AND FIXTURE FOR CHILDREN
- 3. ALL EXPOSED HOT WATER AND WASTE LINES TO BE INSULATED

CAU ADOED DI ANIZEVAIOTEO

ENLARGED PLAN KEYNOTES:				
SYM	DESCRIPTION			
1	NEW TOILET PAPER HOLDER			
(2)	NEW PAPER TOWEL DISPENSER			
3	NEW SOAP DISPENSER			
4	NEW STEEL FRAME MIRROR			
(5)	NEW ACCESSIBLE GRAB BARS			
6	NEW TOILET SEAT COVER DISPENSER			
7	NEW LAVATORY			
8	NEW WATER CLOSET			
9	NEW BRADLEY POWDER COATED METAL TOILET PARTITION IN COLOR TOFFEE 8517			
(10)	EXISTING FLOOR DRAIN TO REMAIN, REFER TO PLUMBING DWG			
(11)	NEW FLOOR DRAIN, REFER TO PLUMBING DWG			
(12)	NEW BABY CHANGING STATION			
(13)	NEW URINAL			
(14)	NEW SANITARY NAPKIN DISPOSAL			
(15)	RECEPTION DESK			
(16)	RECEPTION DESK ACCESSIBLE COUNTER			

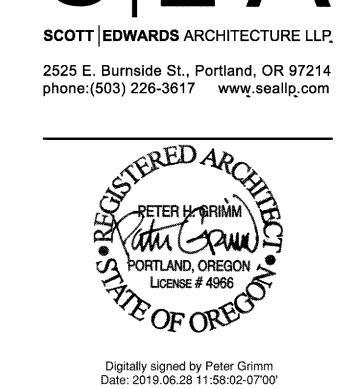

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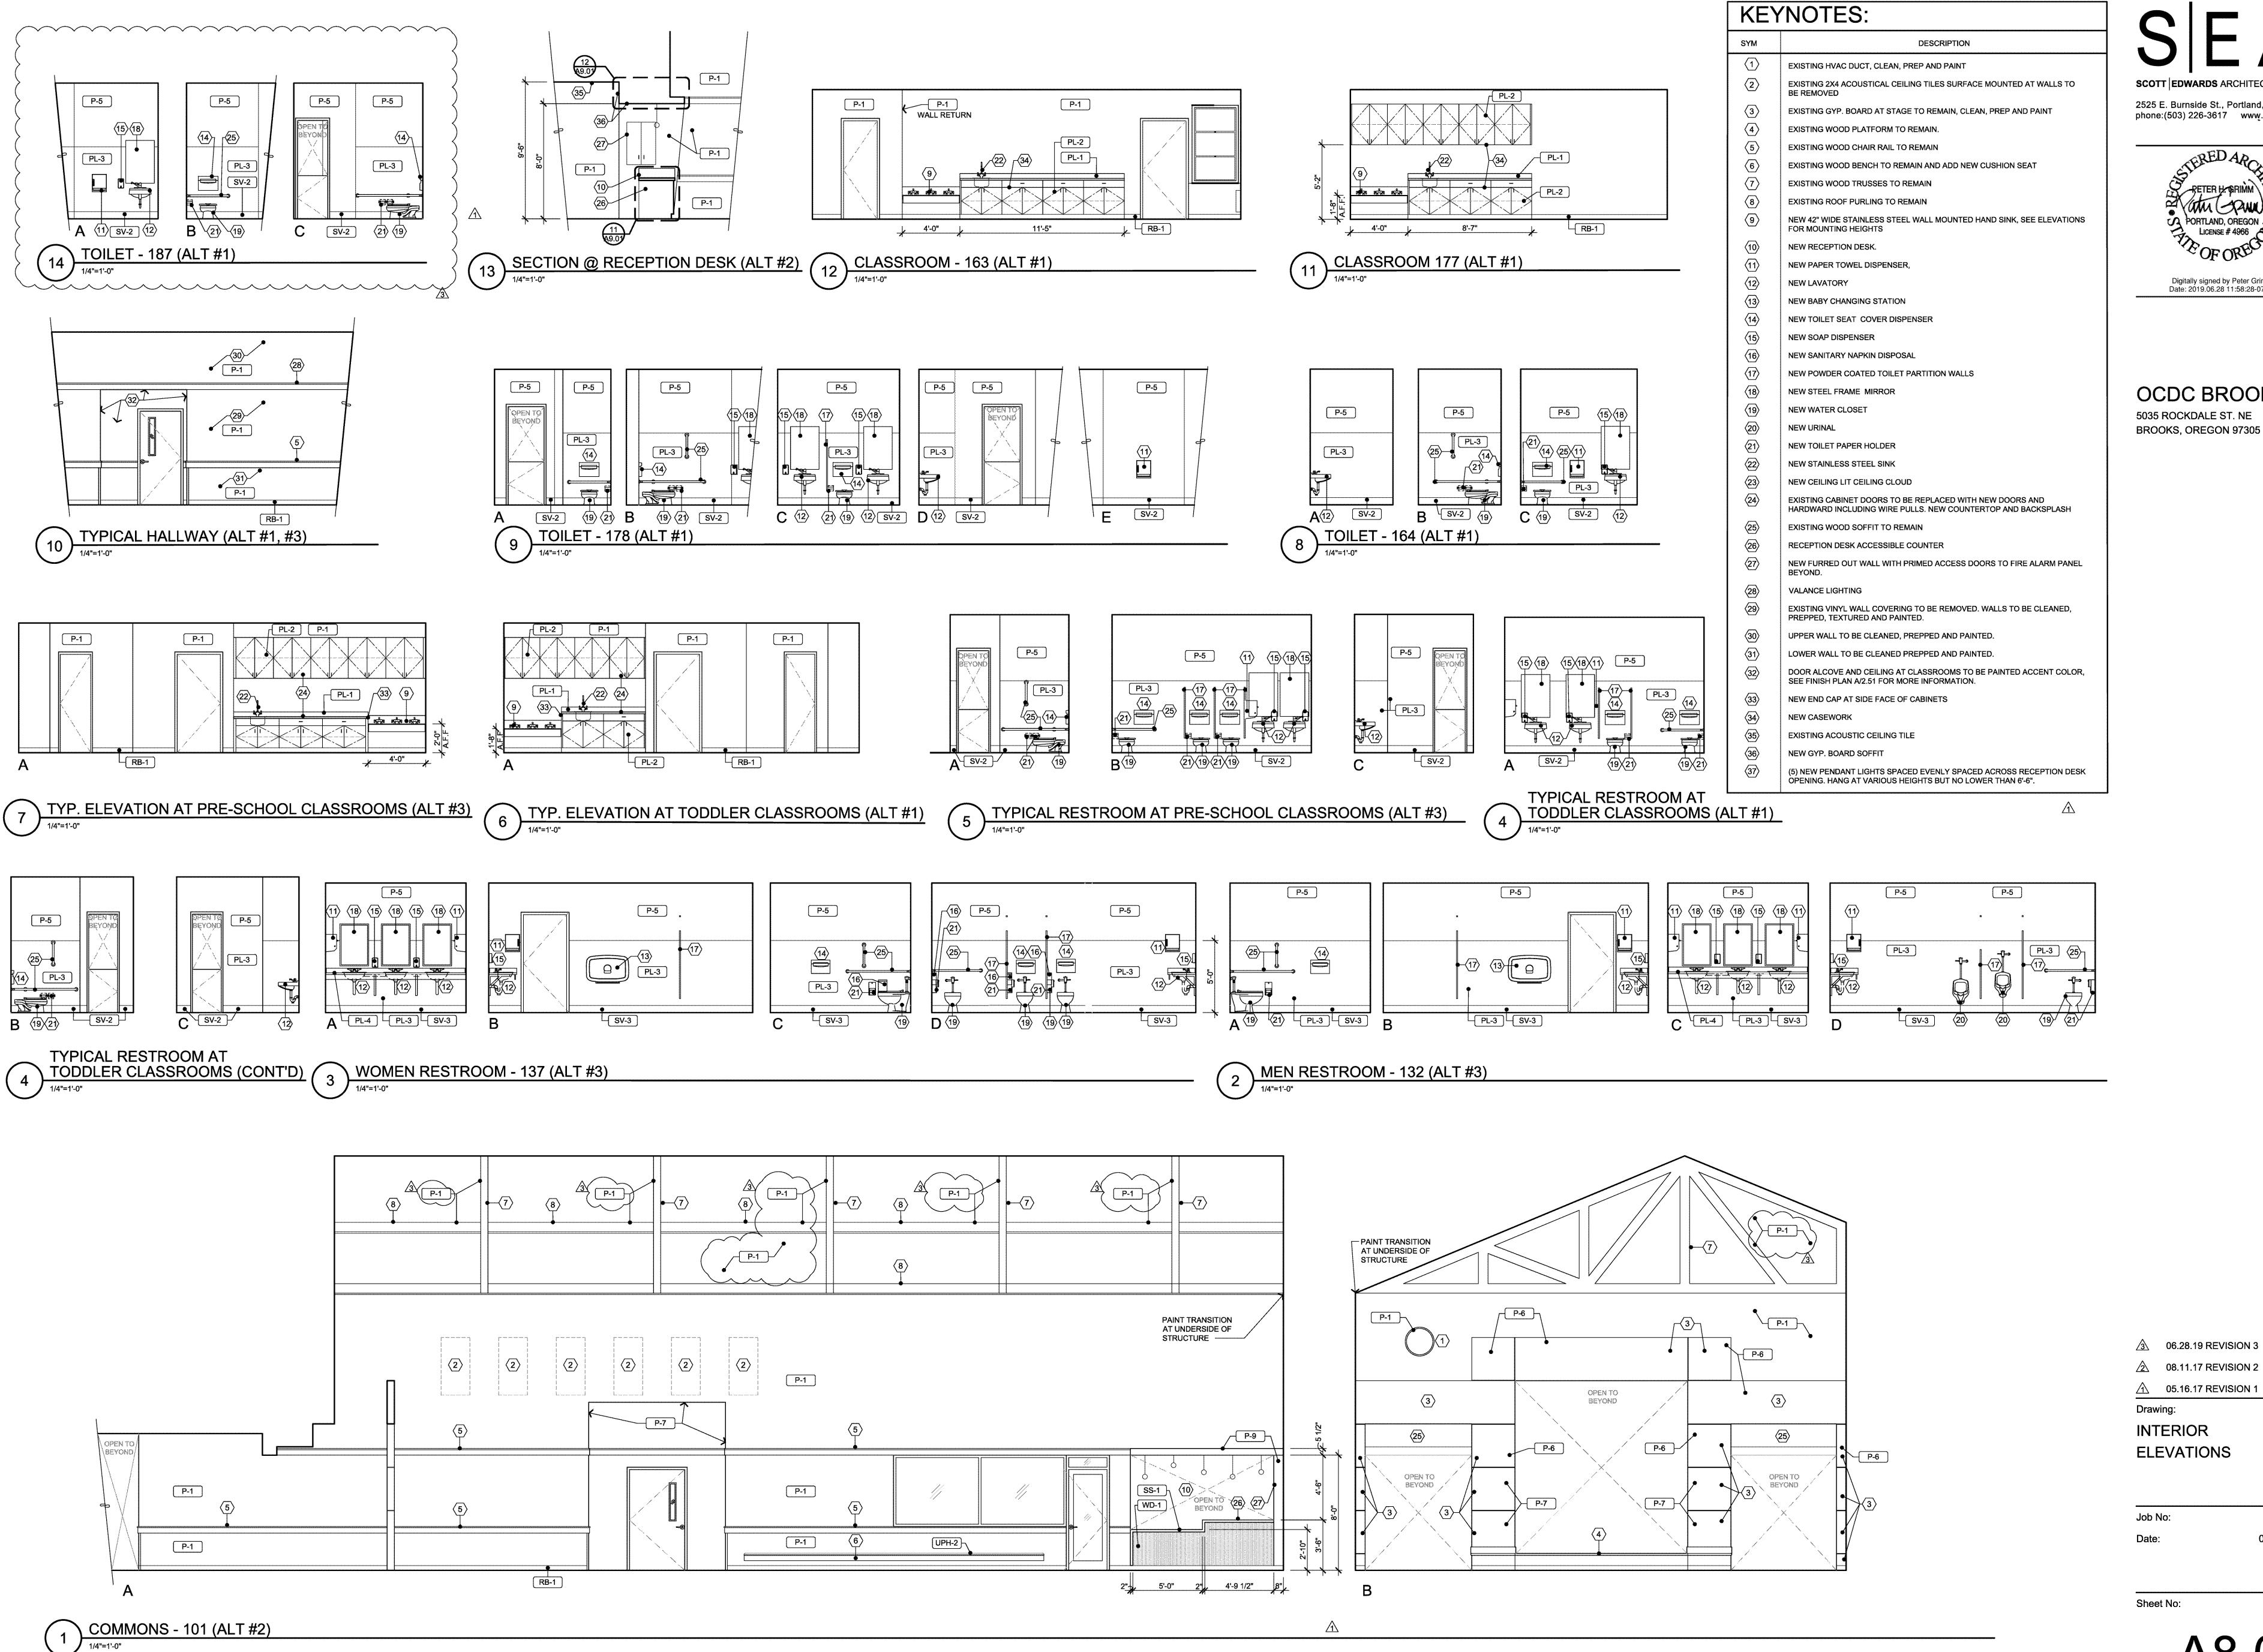


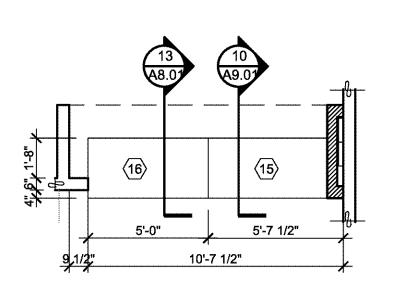6 ENLARGED RECEPTION DESK PLAN - ROOM 159

- 2 08.11.17 REVISION 2
- △ 05.16.17 REVISION 1

Drawing:

ENLARGED FLOOR **PLANS**





OCDC BROOKS 5035 ROCKDALE ST. NE


△ 05.16.17 REVISION 1


08.11.17 REVISION 2


INTERIOR **ELEVATIONS**

17016 04/18/2017

Sheet No:

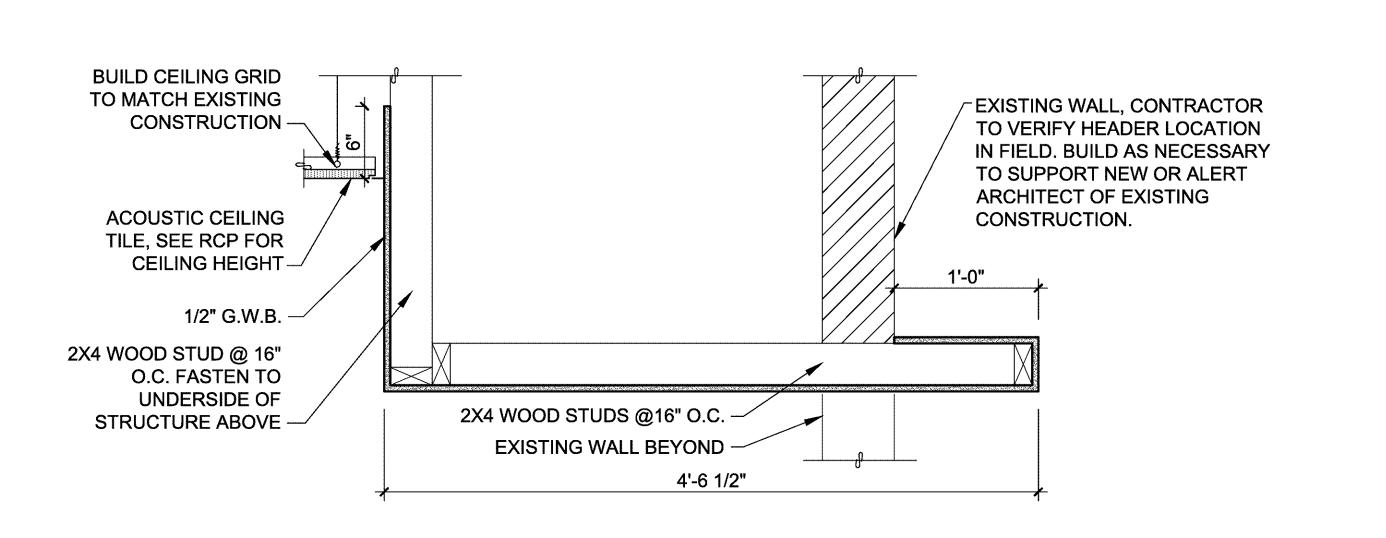

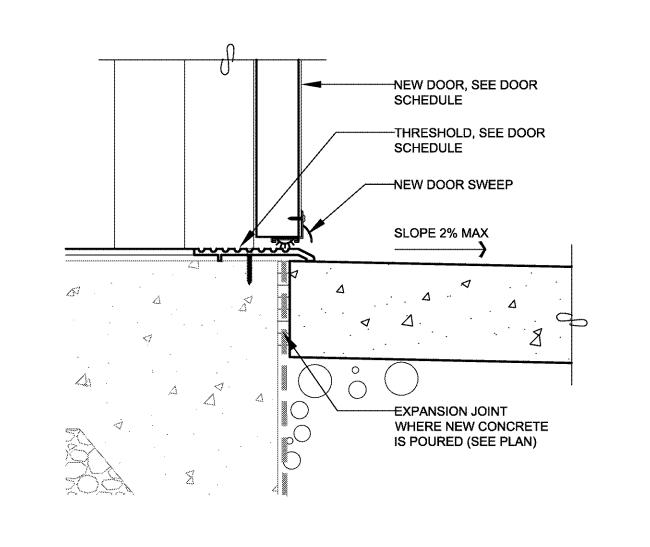

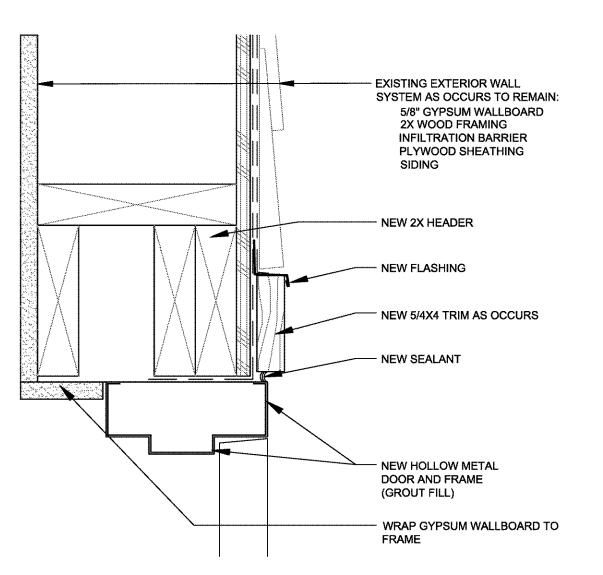




Date: 2019.06.28 11:58:45-07'00'

NEW EXTERIOR DOOR THRESHOLD


3"=1'-0"

8 EXTERIOR DOOR HEAD JAMB


OCDC BROOKS
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BROOKS, OREGON 97305

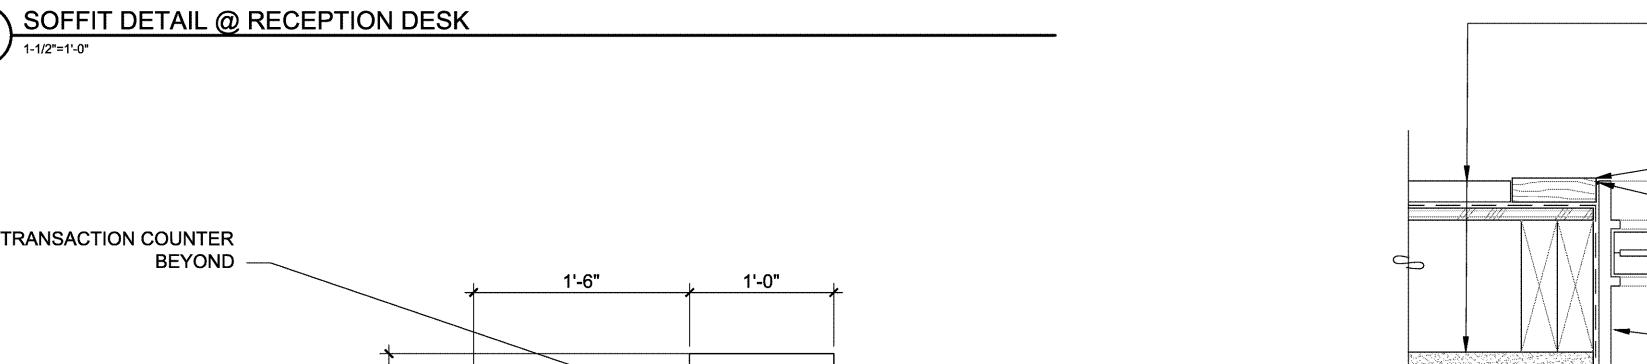



6" 3"

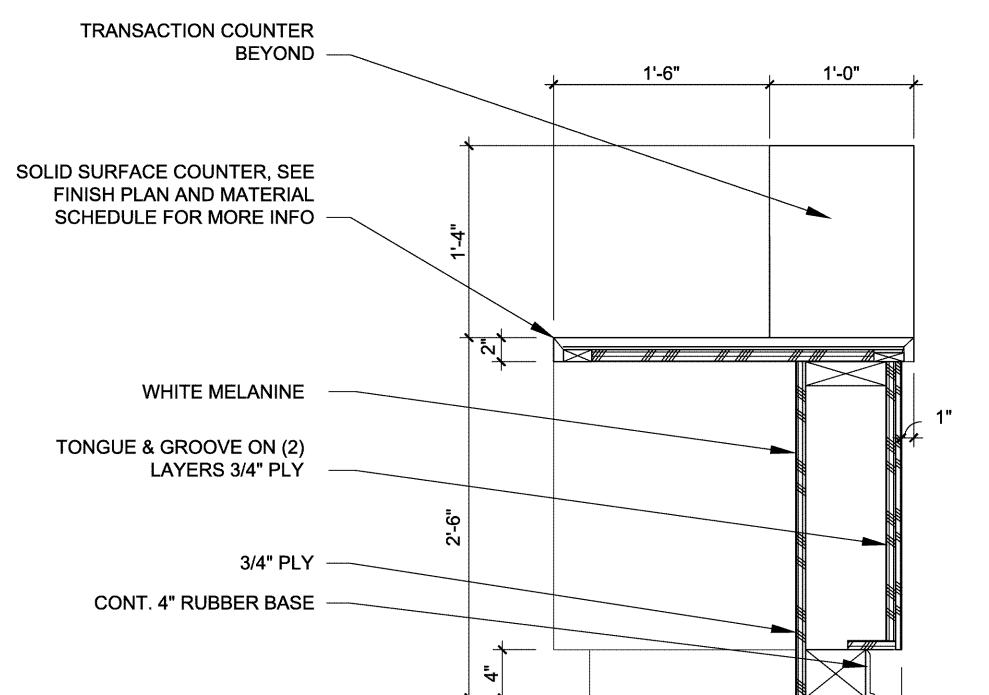

RECEPTION DESK DETAIL @ADA COUNTER

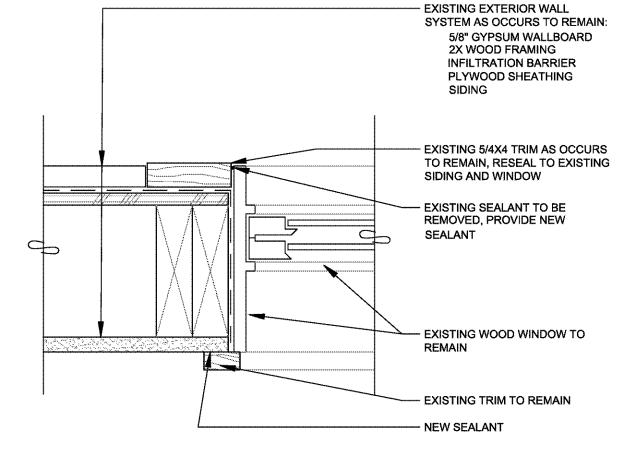

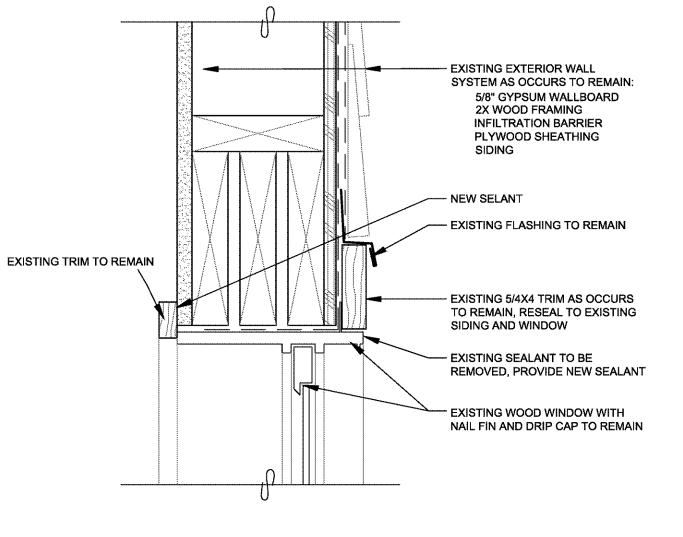


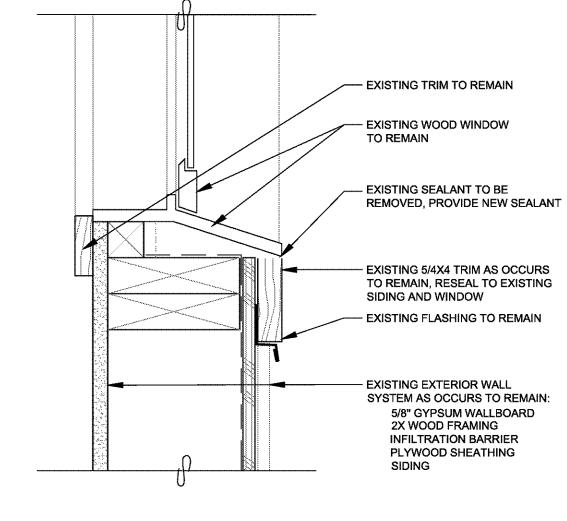



7 EXTERIOR WINDOW JAMB
3"=1'-0"

6 EXTERIOR WINDOW HEAD DETAIL
3"=1'-0"

5 EXTERIOR WINDOW SILL DETAIL
3"=1'-0"

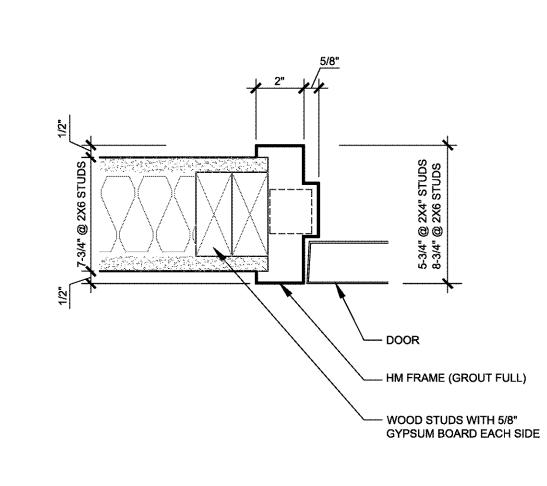

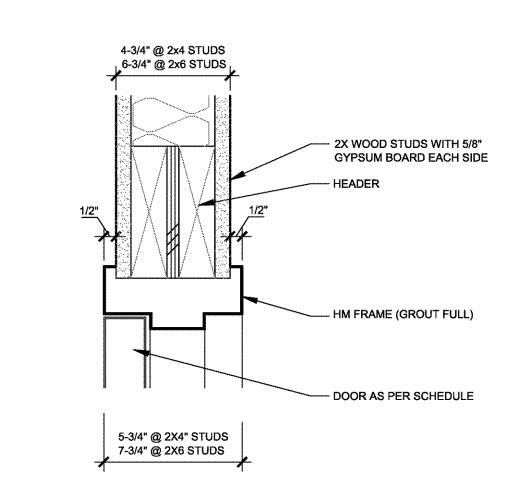

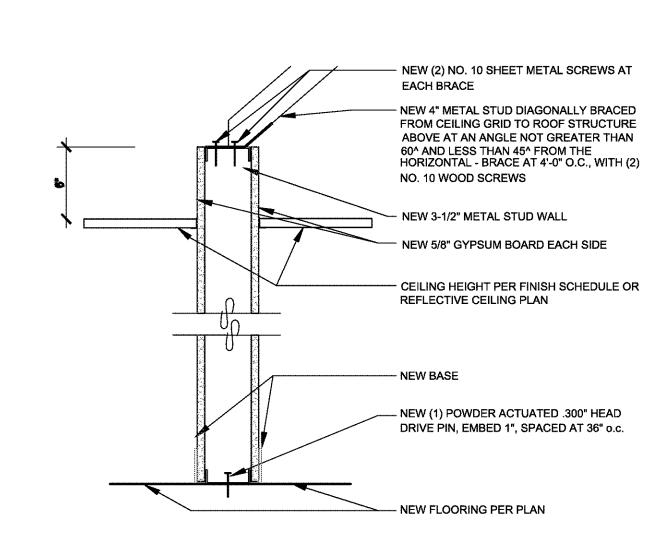

4 TYPICAL HOLLOW METAL JAMB
3"=1'-0"

3 TYPICAL HOLLOW METAL HEAD

NEW WALL SECTION

3"=1'-0"


REFERENCE NOTES FOR DETAIL NO. 3


1 EXISTING CONCRETE FLOOR AND STEPS TO REMAIN

2 EXISTING 2X6 WOOD FRAMED WALL WITH GWB AT

3 EXISTING 2X6 JOISTS AT 16" O.C. TO REMAIN

INTERIOR FACE TO REMAIN

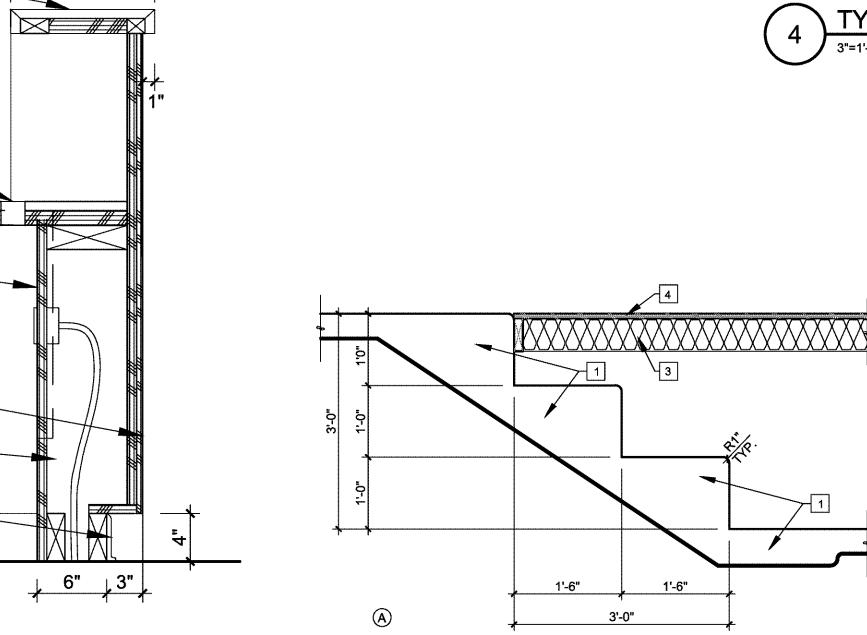

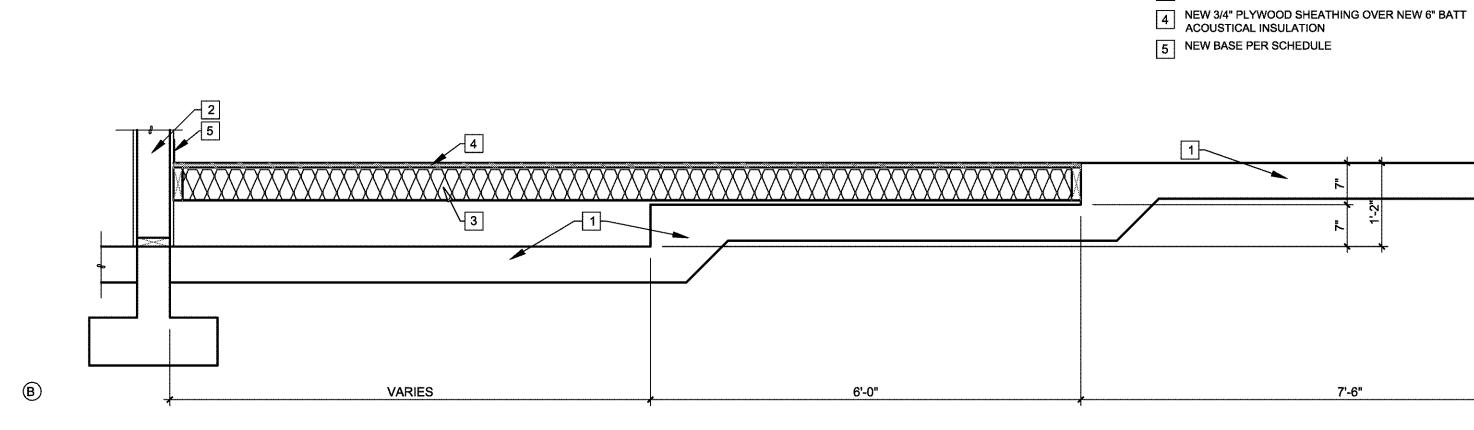

3 06.28.19 REVISION 3
 2 08.11.17 REVISION 2
 1 05.16.17 REVISION 1

Drawing:
DETAILS

Job No: 17016

Date: 04/18/2017

Sheet No:

(10) RECEPTION DESK DETAIL

SOLID SURFACE ON 3/4"

MORE INFO

MORE INFO

WHITE MELANINE

(2) 2"Ø GROMMETS

SOLID SURFACE ON 3/4"

PLYWOOD BOARD AND 3/4" WD SUB NOSING, SEE MATERIAL

LEGEND, SHEET A10.01 FOR

TONGUE & GROOVE OVER (2)

LAYERS OF 3/4" PLY, SEE

MATERIAL LEGEND, SHEET A10.01 FOR MORE INFO

AREA FOR ELECT. CONDUIT

CONT. 4" RUBBER BASE

PLYWOOD BOARD AND 3/4" WD

SUB NOSING, SEE MATERIAL

LEGEND, SHEET A10.01 FOR

OVERFRAMING SECTIONS

A9 0

STRUCTURAL NOTES

01.0 GENERAL NOTES

- 1. These notes set minimum standards for construction. The drawings govern over the Structural Notes
- to the extent shown.

 2. Contractor shall verify all dimensions and conditions on drawings and in field. Coordinate locations of openings through floors, roofs and walls with architectural, mechanical and electrical plans. Notify
- owner's representative of any discrepancies.

 3. Construction means, methods and all necessary temporary support prior to completion of vertical and lateral load systems is the sole responsibility of the contractor.
- Compliance with all safety and OSHA requirements is the sole responsibility of the contractor.
 All work shall be in compliance with 2014 edition of the "Oregon Structural Specialty Code" (OSSC) as amended by all other state and local codes, permits, and building department requirements that
- 6. Where reference is made to ASTM, AISC, ACI or other standards, the Code referenced issue shall
- apply.
 7. Design Criteria:

Table 1604.5	Risk Category	M.	
Roofs	Dead load	17 psf {10 psf / 7 psf}	
	Live load (snow)	25 psf per 1608.1	
***************************************	Ground snow load, P_g (for drift calculations)	20 psf	
	Flat-roof snow load, P _f	14 psf	
	Snow exposure factor, C _e	1.0	
	Snow importance factor, I _s	1.0	
	Thermal factor, C _t	1.0	
Wind	Basic wind speed	120 mph, 3-sec gust	
	Wind exposure	B, N-S; B, E-W	
	Internal pressure coeff, GC_{pi}	+/- 0.18	
	Components and cladding	Per ASCE 7, CHPT 30	
Seismic	Mapped spectral response, S_S and S_1	0.923 and 0.427	
	Site class	D	
	Seismic importance factor, I_E	1.25	
	Spectral response coeff., S _{DS} and S _{D1}	0.69 and 0.45	
	Seismic design category	D	
	Basic seismic force resisting system	Bearing wall system	
	Response modification factor, R	6 ½,	
**************************************	Seismic response coeff., C _S	0.134	
	Analysis procedure used	Equivalent lateral force	

8. Details shown on the drawings are intended to apply at all similar conditions and locations.9. Do not scale information from drawings.

02.0 FOUNDATIONS

ADD NEW P.T. 2X FULL

NEW SIMPSON HDU

NEW 2X PARTITION WALL EXTENSION -

REMOVE AND REPLACE

TO INSTALL NEW ANCHOR -

NEW P.T. 2X PLATE -

EXISTING SLAB IF REQUIRED

8 HOLD DOWN -

HEIGHT -

HEIGHT STUD NAIL WITH 16 D

@ 6" O.C. STAGGERED FULL

 Design soil pressure is 2000 psf LL plus DL, per original record documents and soils report dated March, 1989.

- EDGE NAIL TO ALL STUDS AT HOLD

- VERIFY EXISTING HOLD DOWN AND

EXISTING FOOTING

— DO NOT DRILL EXISTING REBAR

DOUBLE STUD

03.2 CONCRETE ANCHORS

- 1. Epoxy Anchors: Hilti HIT-RE 500-V3.
- a. Unless noted, install threaded rods into clean, dry holes to embed depth as shown on drawings. Comply with manufacturer's ICC-ES report for hole diameter and rod material. If embed depths are not shown, use manufacturer's minimum depths. Fill hole with enough epoxy to fill all void spaces and insert rod with clockwise twisting motion.
- b. Do not place when epoxy or concrete is less the 50 degrees Fahrenheit.c. Do not cut main reinforcing or break out back surface when drilling holes.
- c. Do not cut main reinforcing or break out back surface when drilling holes.3. Screw Anchors: Hilti Kwik HUS-EZ or Simpson Titen HD.
- a. Install to clean, dry holes to embed depth +1/2" as shown on drawings. Comply with manufacturer's ICC ES report for hole diameter. If embed depths are not shown, use manufacturer's minimum depths.
- b. Do not cut main reinforcing or break out back surface when drilling holes.
- c. Tighten the anchor into the base material until the head contacts the fixture.
- d. Provide standard washer under heads in contact with wood.
 e. Special inspection of holes is required prior to installing screw anchors. See the Special Inspection section of these notes.

05.0 STRUCTURAL AND MISCELLANEOUS STEEL

- 1. Detailing, fabrication and erection shall conform to the Steel Construction Manual of AISC.
- 2. The contractor shall be solely responsible for all OSHA requirements for safety and erection including, but not limited to, erection bolts, bracing, fall protection, etc.
- 3. All threaded rods shall be ASTM F1554 Grade 36, unless otherwise noted.

06.0 WOOD FRAMING

- All glue-laminated beams (GLB) shall be Douglas Fir 24F-V4 for simple span beams, 24F-V8 for beams with cantilevers or continuous spans, and Identification number 2 for columns except columns exposed to view shall be Identification number 3 per AITC 117 design specification. Beam appearance grade shall be industrial, except beams exposed to view shall be architectural.
- 2. All lumber species and grade to be as follows:

6" nominal & greater beams and stringers	DF #1-19 percent M.C.
Bucks, blocking, bridging and misc.	DF #3 or better
Structural 2x studs	DF #2 K.D. – 15 percent M.C.
Plates, sills and headers for wall framing	DF #2 K.D. – 15 percent M.C.
Sills, ledgers, plates, etc embedded in or in contact	Pressure treated Hem Fir #2
with concrete, not exposed to weather	AWPA UC2 (ACZA Not Allowed)

3. Sheathing shall be APA Rated Sheathing or Sturd-I-Floor, C-D grade, Exposure 1 with Performance Category and Span Rating as noted below. Each sheet shall bear an APA stamp. Install roof and floor sheathing with face grain perpendicular to supports and stagger end joints. Install wall sheathing either horizontal or vertical, and block all edges of sheathing with 2x4 or thicker blocking. Block roof and floor sheathing where noted on drawings and where plywood widths are less than 12 inches wide. Glue floor sheathing to all supports. Protect all sheathing from weather damage and moisture. Replace all buckled or soft sheets. Do not cover sheathing with permanent roofing or finishes until sheathing has a moisture content of less than 19%.

isnes until sheathing has a moisture content of less than 1376.				
Location	Performance Category	Span Rating		
Walls	15/32	32/16		

7/8" Ø F1554 THREADED ROD, EMBED

14" IN EXISTING FOOTING WITH HILTI

RE-500 V3 HAMMER DRILL HOLE AND

EXISTING 2X SILL PLATE, ADD 5/8" X

8" SIMPSON TITEN HD ANCHORS @

32" O.C. BETWEEN EXISTING SILL

ANCHORS. INSTALL WITH SIMPSON BP 5/8 WASHERS. PLACE TO AVOID

DRILLING REBARD IN CMU

CLEAN PER MFG REQUIREMENTS.

4. Framing anchors, joist hangers, post caps, etc., shall be by 'Simpson Strong-Tie'. Install per manufacturer's recommendations for tabulated maximum capacities with fasteners installed in all holes. Framing anchors attaching to pressure treated lumber shall be Z Max coated or hot dipped galvanized and attached with hot dipped galvanized (2.0 oz per square foot) or stainless steel nails or screws. Framing anchors installed at exterior locations exposed to weather are to be stainless steel with stainless steel fasteners.

- All bolt holes in wood to be 1/16 inch larger than the bolt. Do not ream or oversize bolt holes.
 All nailing shall be per Table 2304.9.1 of the IBC. Nails called for on the drawings shall be common for plywood nailing; box nails for framing; and type recommended by manufacturer for maximum capacity of hangers and connectors. Nail heads shall not penetrate the face veneer of plywood namels.
- Nails, bolts or lags in pressure treated lumber shall be hot dipped galvanized or stainless steel.
 Studs may be notched in the lower 1/5 of the height of stud for electrical and plumbing pipes, but no part of the notch is to be deeper than 25 percent of width of stud. Holes of diameters up to 1/3 of width of stud may be drilled in stud but not in center 1/3 of height. The edges of drilled holes are to be at least 5/8-inch from the face of the stud.
- Provide deflection space over all non-bearing walls located under open-web and plate connected wood trusses.

CONSTRUCTION OBSERVATION, INSPECTION AND TESTING

A. GENERAL

STAGGERED FULL HEIGHT

EXISTING 8" CMU SILL. VERIFY GROUTED SOLID, IF HOLLOW CELLS

EXISTING SLAB

ARE FOUND DRILL HOLE TOP AND

BOTTOM AND INSTALL 2000 PSI FINE

- Independent testing lab to be retained by owner to provide inspections and special inspections as described herein.
 Contractor is responsible to coordinate and provide on site access to all required inspections and
- Contractor is responsible to coordinate and provide on site access to all required inspections and notify testing lab in time to make such inspections.
- Do not cover work required to be inspected prior to inspection being made. If work is covered, uncover as necessary.
- 4. The contractor shall correct all deficiencies noted in the special inspection reports to bring the construction into compliance with the contract documents, addendum, RFI's and/or written instructions. The contractor is responsible to request summary reports from the special inspector at the time of the project substantial completion.

B. SPECIAL INSPECTIONS


Required special inspections shall be performed by an independent special inspector per Section 1701 of the International Building Code (IBC) for the following: 1,2,3


Item	Continuous4	Periodic ⁴	Comments
Concrete:	Anna Anna Anna Anna Anna Anna Anna Anna		Table 1705.3
Inspect hole size, depth and cleanliness and installation per manufacturers recommendations of all post-installed Epoxy and Screw Anchors		x	

- Special Inspection Program Footnotes

 1. Items checked with **X** shall be inspected in accordance with IBC Chapter 17 by certified special
- inspectors from a testing agency approved by the building official.

 2. Special inspection is not required for work performed by an approved fabricator meeting the
- requirements of IBC Section 1704.2.5.2
- The special inspector shall provide a copy of their report to the owner, architect, structural engineer, contractor and building official.
- engineer, contractor and building official.
 4. Continuous special inspection means full-time observation of the work requiring special inspection by an approved special inspector present in the area where the work is being performed. Periodic special inspection means part time or intermittent observation of the work at intervals necessary to confirm that work requiring special inspection is in compliance.

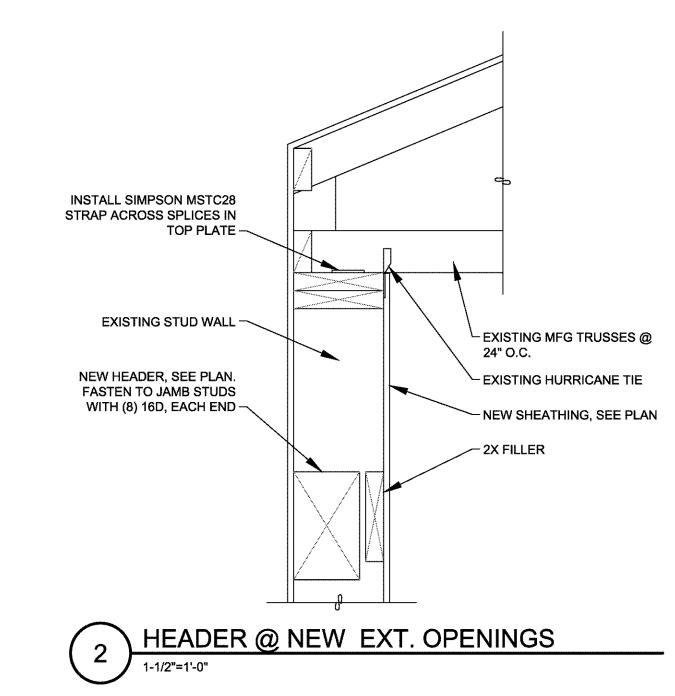

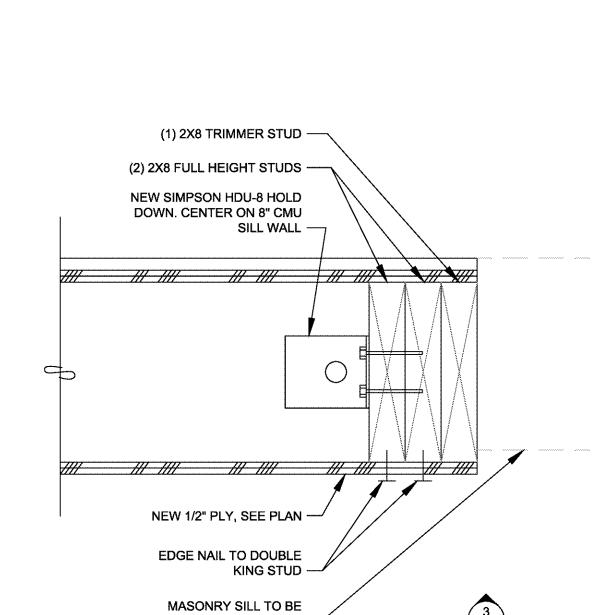

3 STRUCTURAL DETAIL @ NEW EXT. OPENING

DO NOT DRILL (E) REBAR





SCOTT EDWARDS ARCHITECTURE LLP

2525 E. Burnside St., Portland, OR 97214

phone:(503) 226-3617 www.seallp.com

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5035 ROCKDALE ST. NE

BROOKS, OREGON 97305

Date: 2019.06.28 11:59:00-07'00'

№ 08.11.17 REVISION 2
 № 05.16.17 REVISION 1

STRUCTURAL DETAILS

Job No: 17016

Date: 04/18/2017

Sheet No:


STRUCTURAL DETAIL @ INTERIOR WALL

7/8" Ø F1554 THREADED ROD, EMBED


14" IN EXISTING FOOTING WITH HILTI RE-500 V3 HAMMER DRILL HOLE AND CLEAN PER MFG REQUIREMENTS.

A9.02



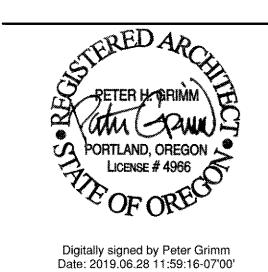

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(E) GIRDER TRUSS SIMPSON LCE4 EA. SIDE OF BEAM -(E) WALL SIMPSON LTS12 STRAP

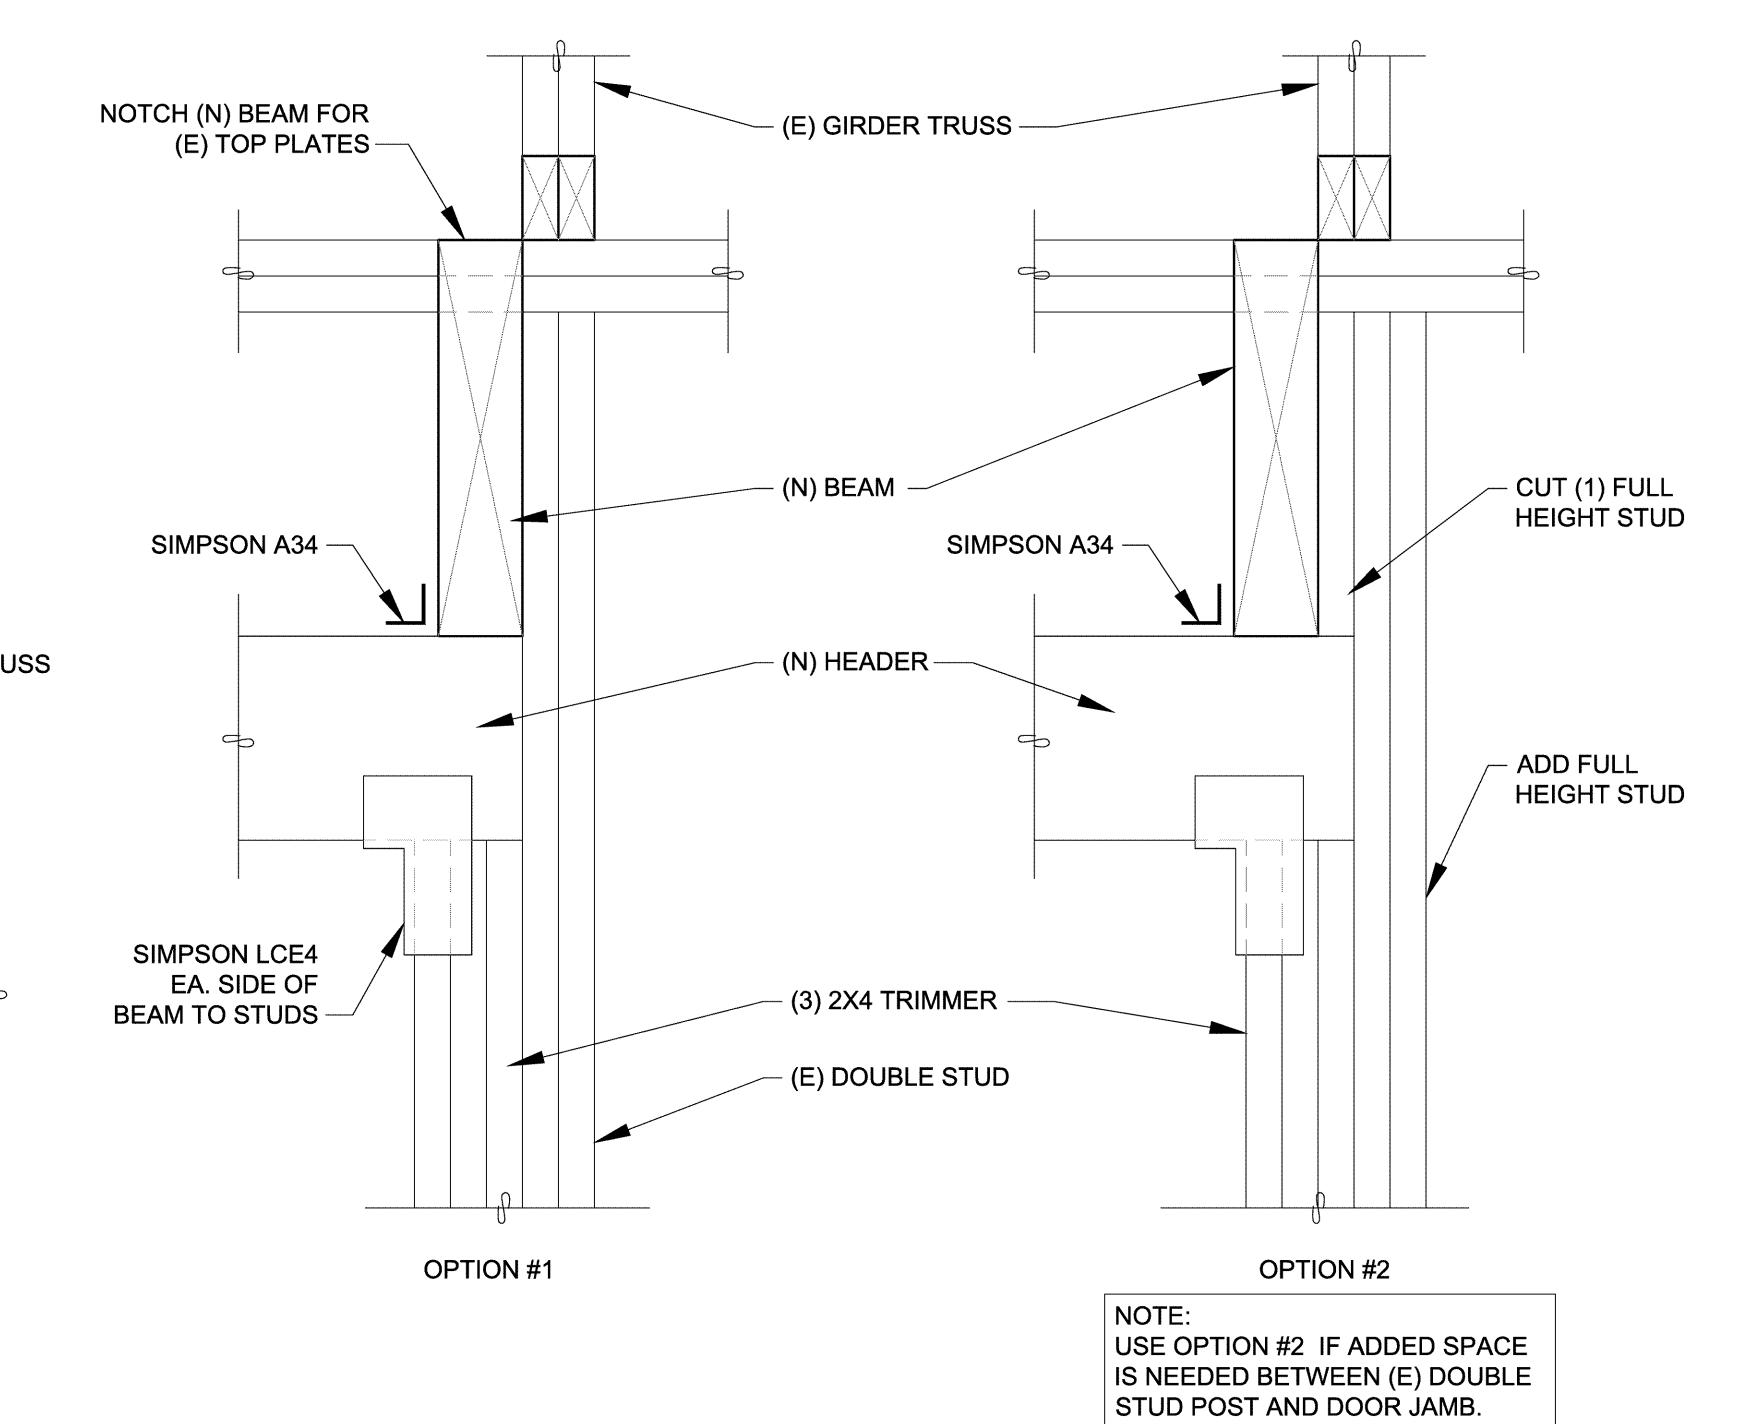- (1) SIMPSON LTP5

EA. SIDE OF BEAM,

(N) BEAM, SEE PLAN

- SIMPSON LCE4 EA.


SIDE OF BEAM


5 1/2"

STAGGERED

4 PLAN VIEW
3"=1'-0"

BEAM TO WALL CONNECTION

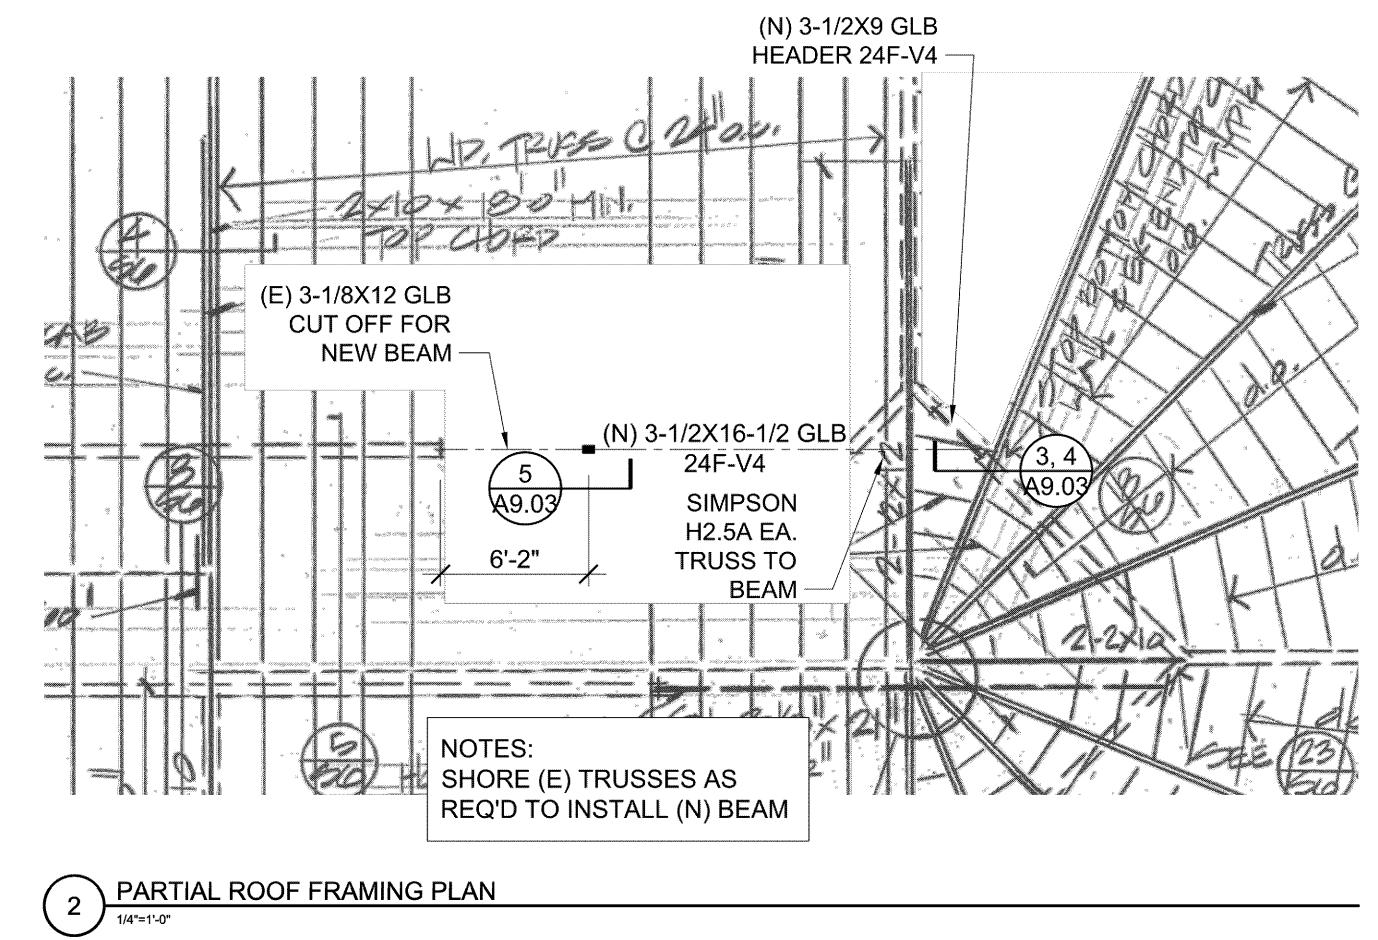

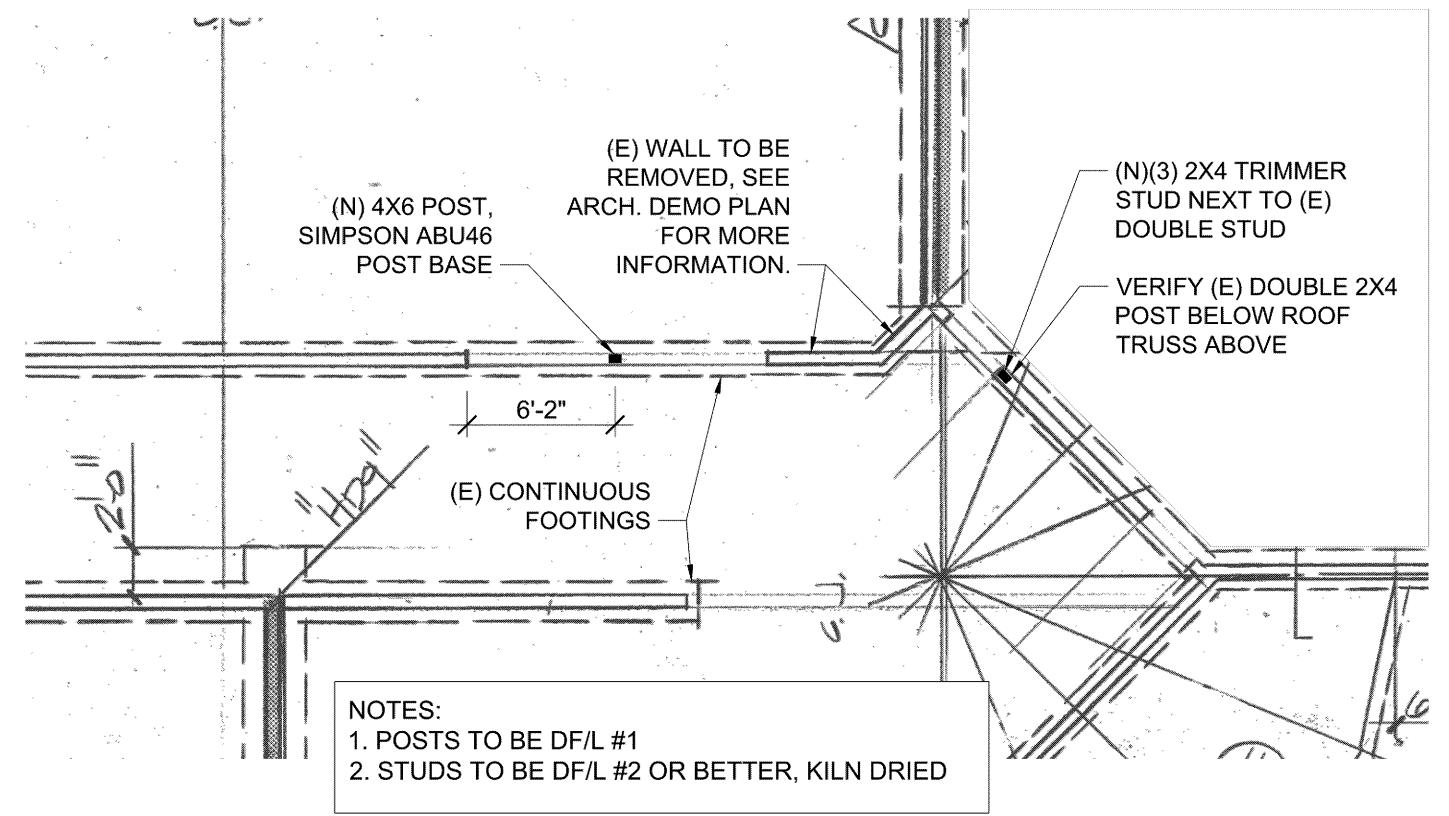

Sheet No: PARTIAL FOUNDATION PLAN
1/4"=1'-0"

SIMPSON ST6215

(E) BEAM, CUT FOR

(N) BEAM INSTALL

SIMPSON A34 -

5 BEAM TO COLUMN CONNECTION

3"=1'-0"

POST, SEE PLAN -

STRAP -

17016


04/18/2017

3 06.28.19 REVISION 3

2 08.11.17 REVISION 2

1 05.16.17 REVISION 1

DETAILS

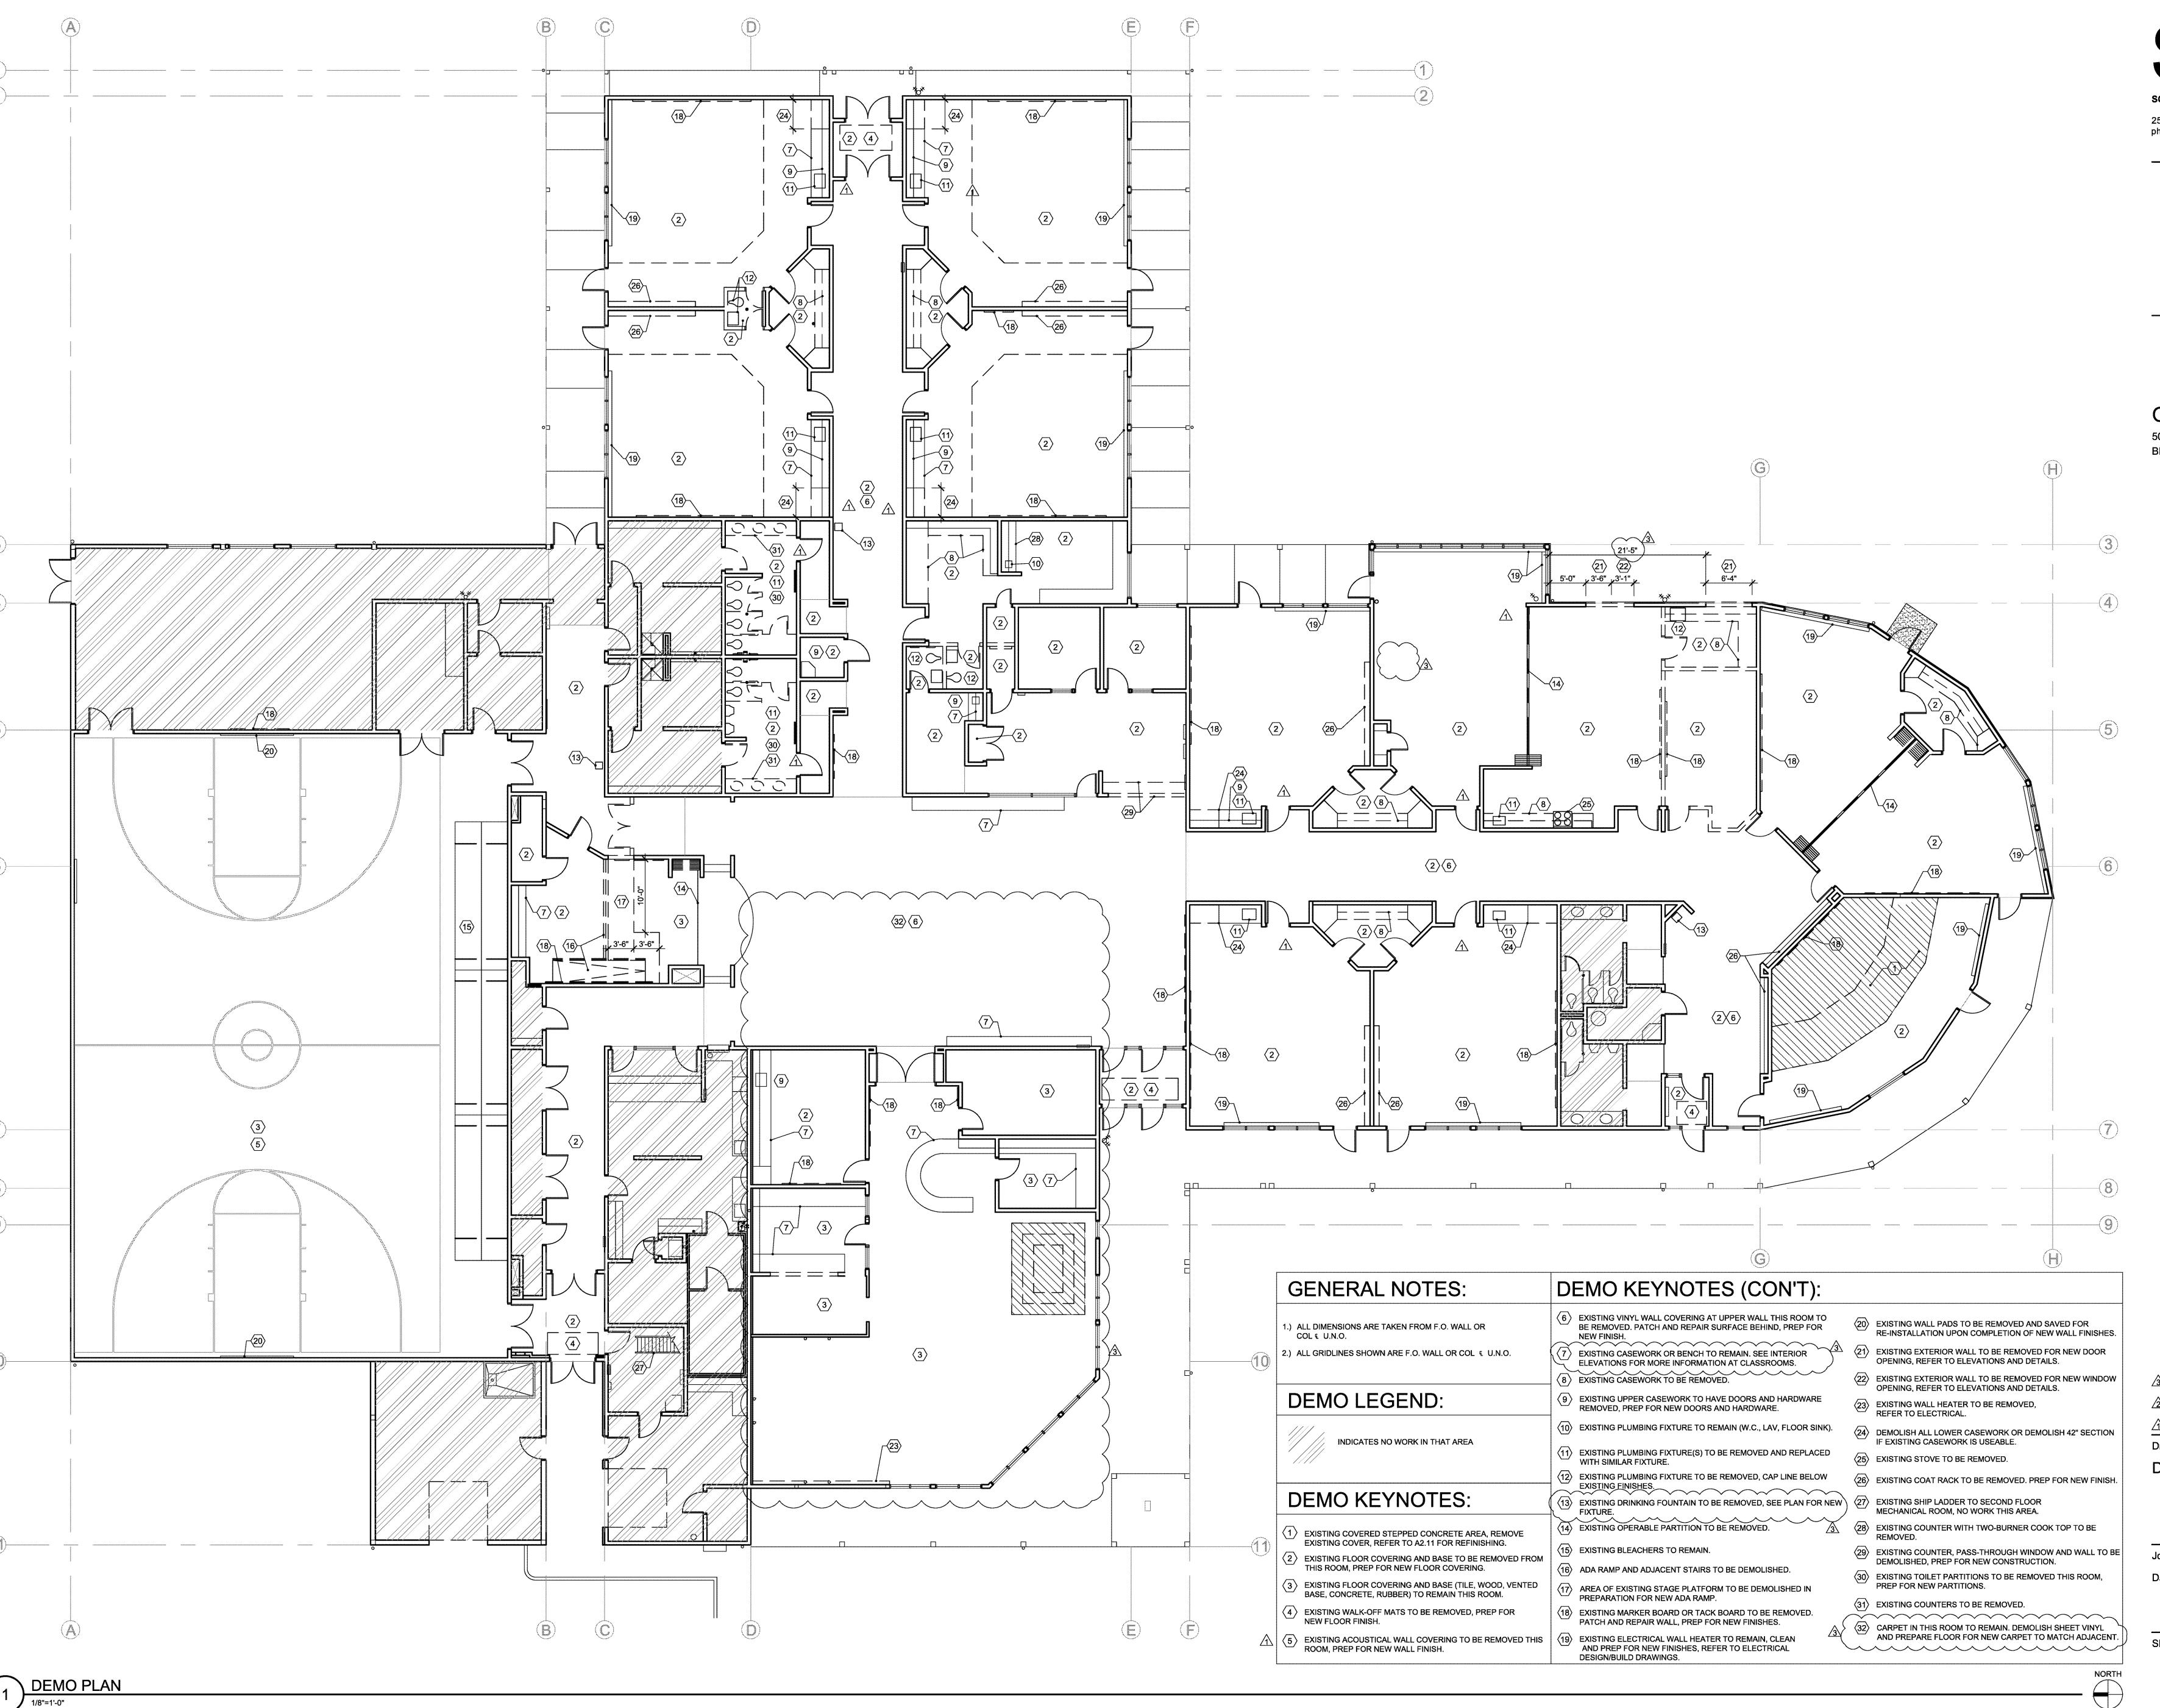



OCDC BROOKS

5035 ROCKDALE ST. NE BROOKS, OREGON 97305

08.11.17 REVISION 2

05.16.17 REVISION 1


DEMOLITION PLAN

Job No: 17016

nte: 04/18/2017

Sheet No:

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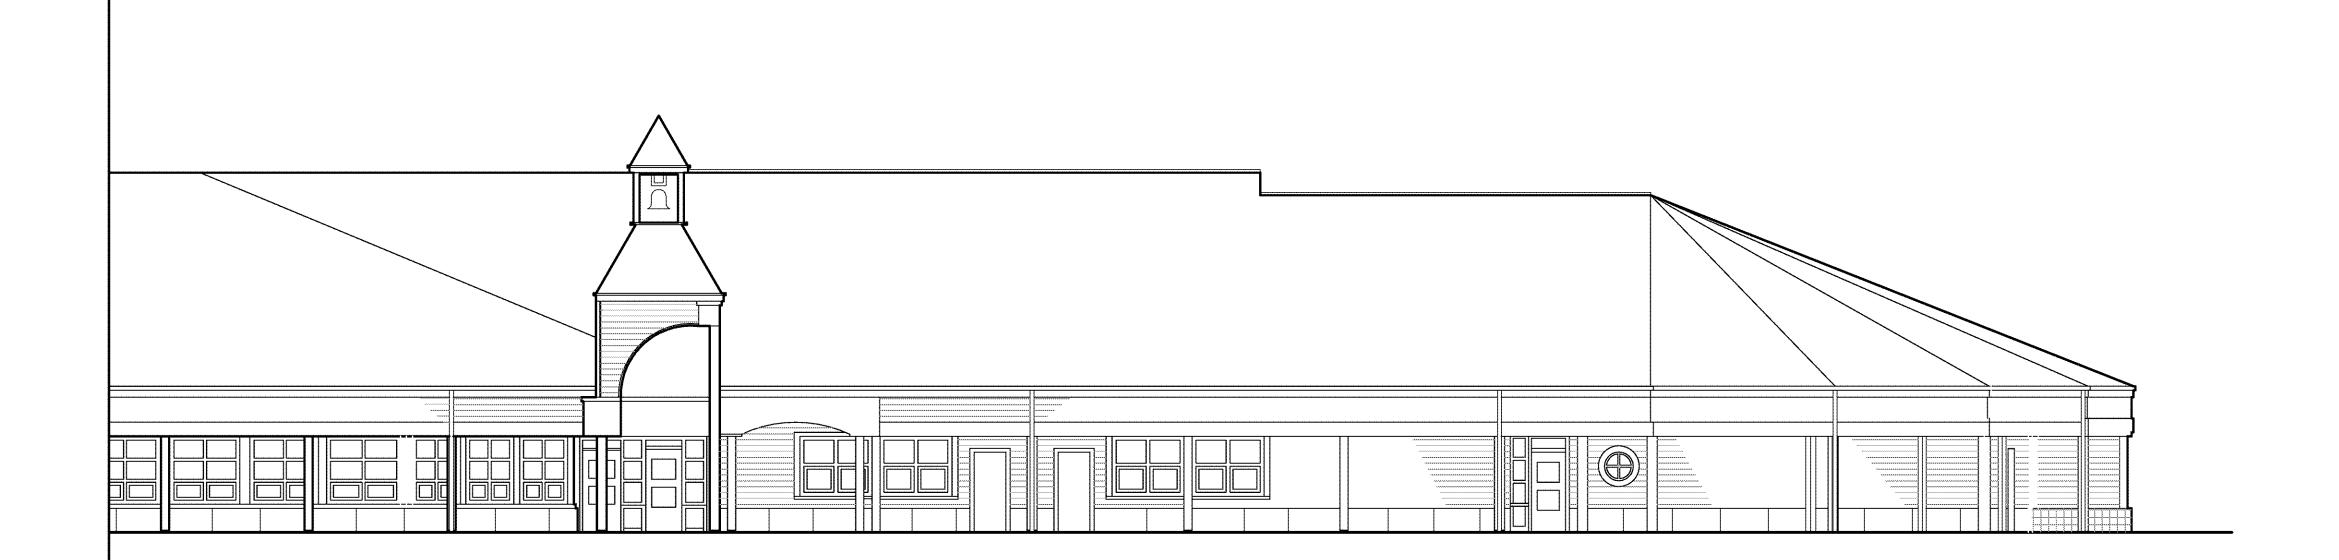
17016

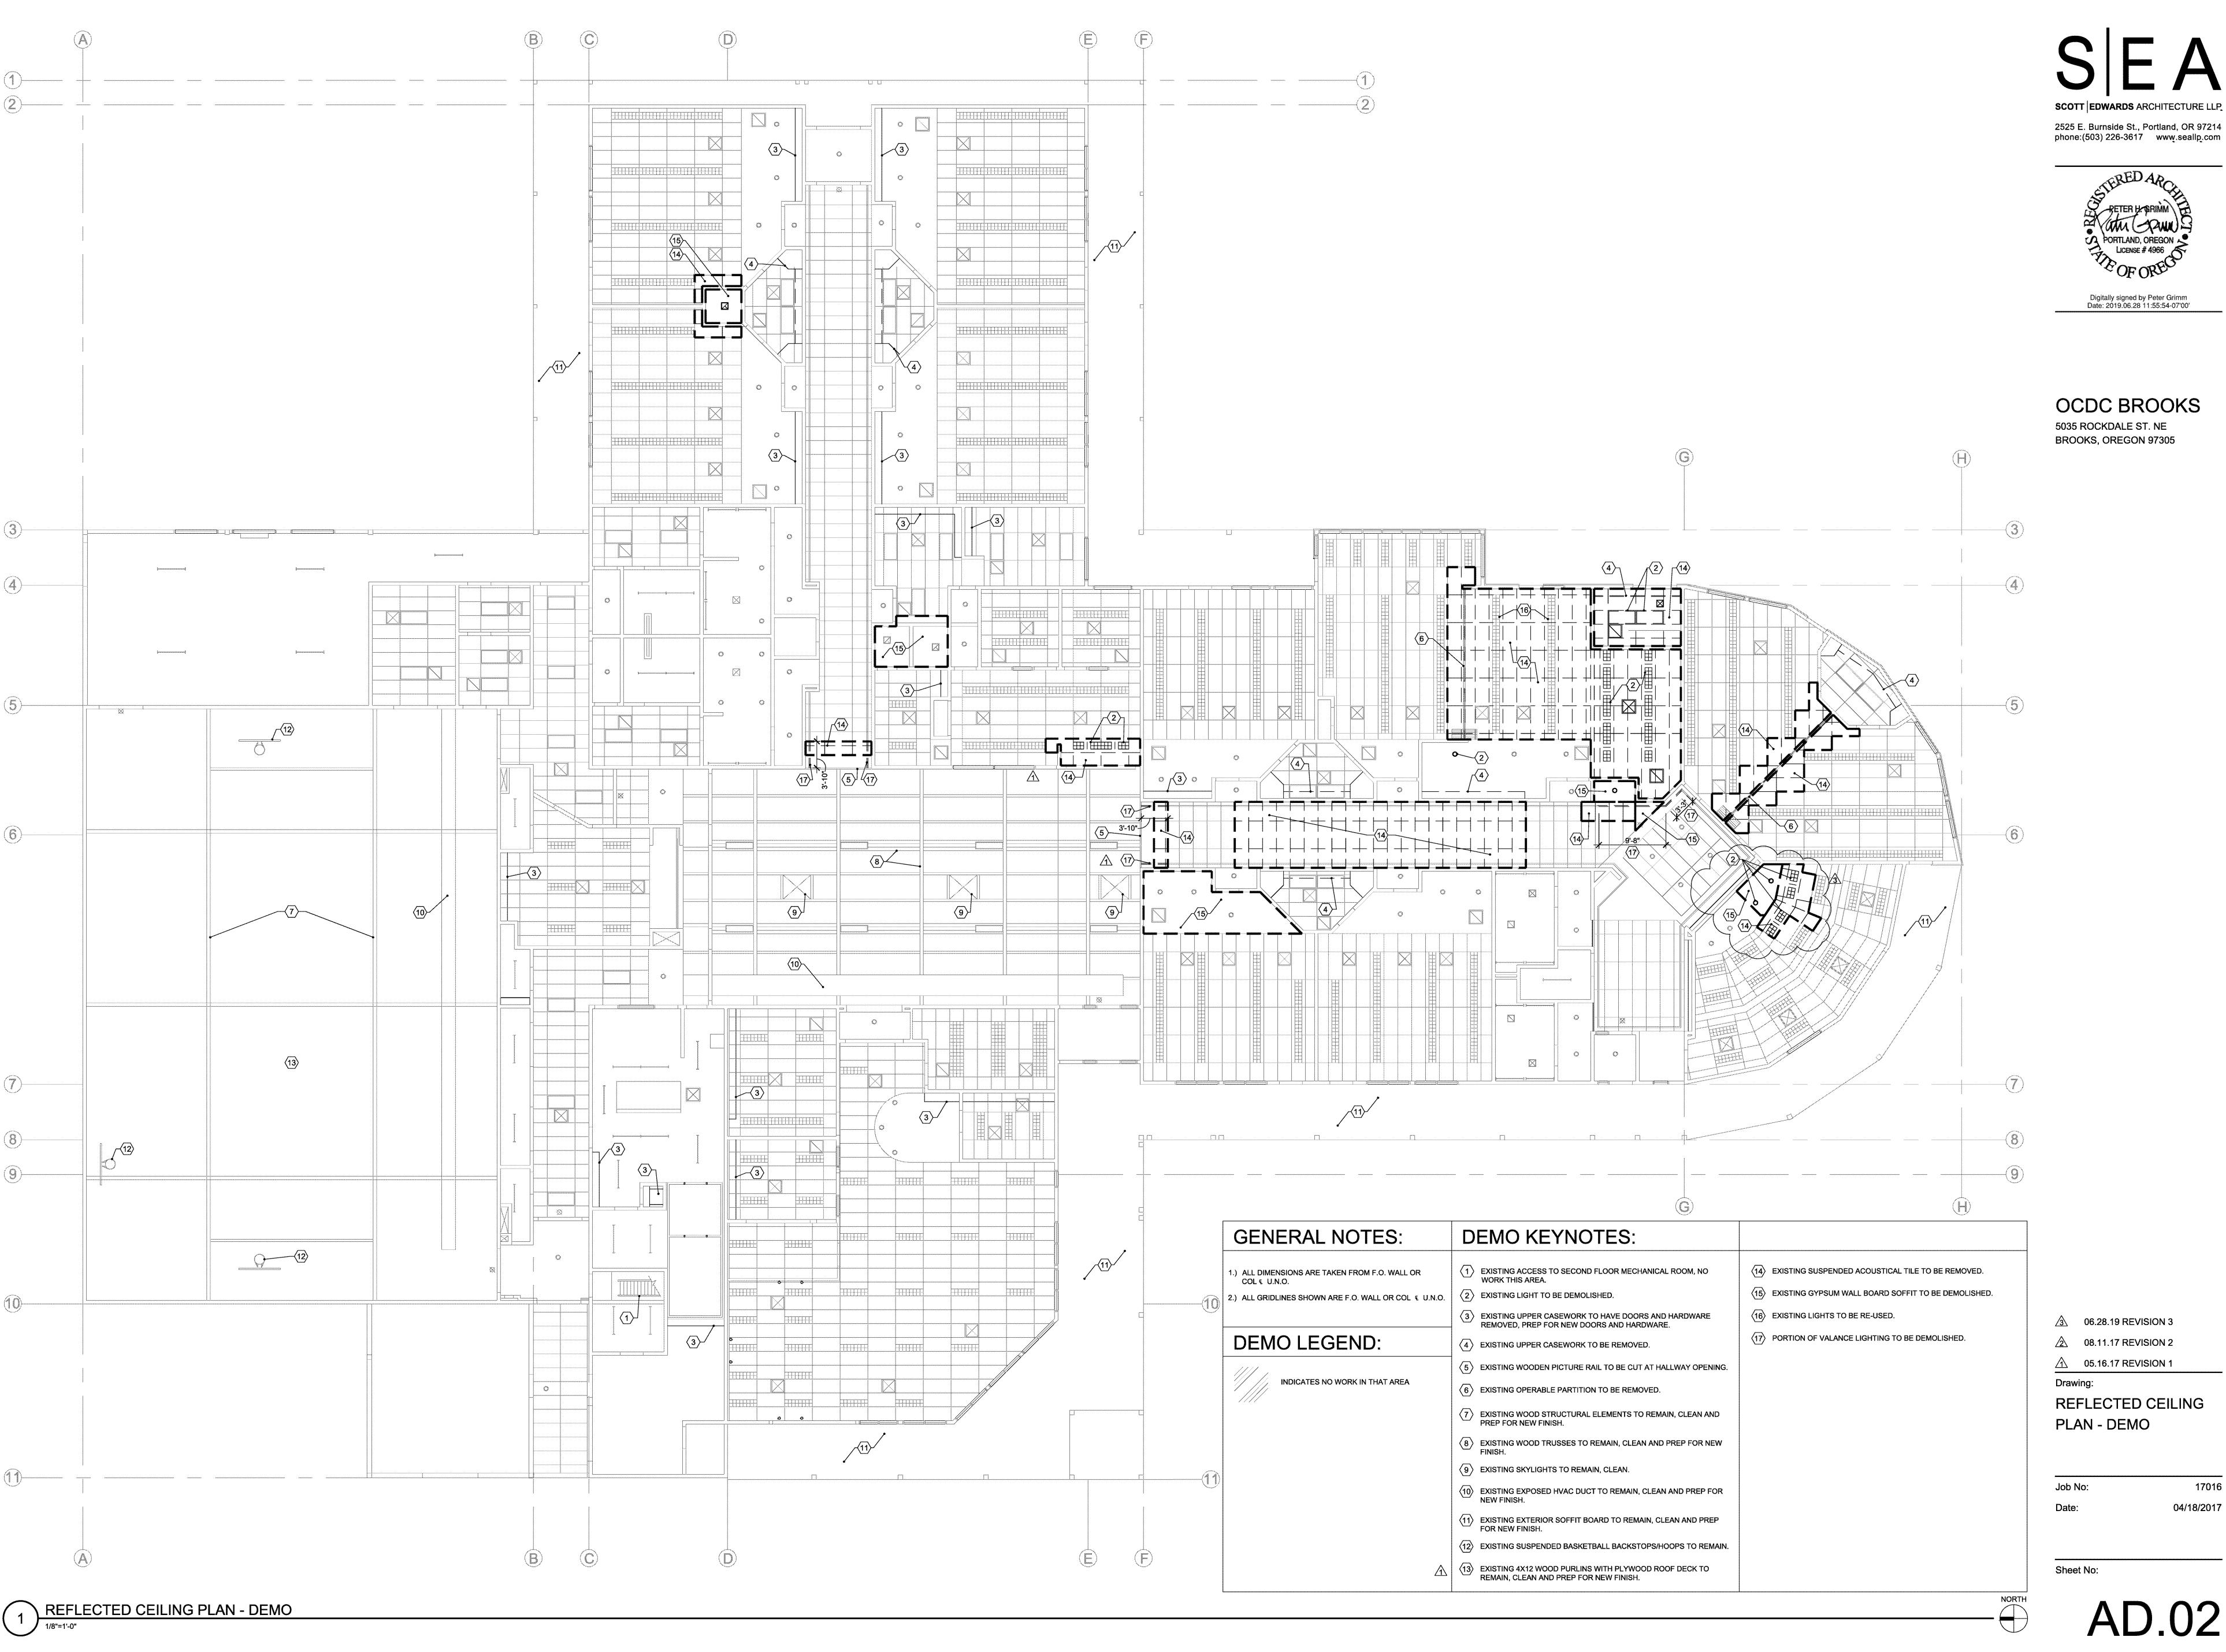04/18/2017

Digitally signed by Peter Grimm Date: 2019.06.28 11:55:54-07'00'

OCDC: BROOKS HEADSTART

5035 ROCKDALE ST. NE BROOKS, OR 97305





OF ARCHITECT, OWNER, AND GOVERNING BUILDING DEPARTMENT.

ROUTE DOCUMENTS TO THE ARCHITECT FOR REVIEW PER IBC

1. FIRE SPRINKLER SYSTEM INSPECTION.


PROVIDE (5) COPIES OF BIDDER DESIGNED SYSTEM DOCUMENTS.

UPON COMPLETION OF REVIEW BY THE ARCHITECT OR ENGINEER OF RECORD. THE CONTRACTOR SHALL BE RESPONSIBLE FOR ROUTING DOCUMENTS TO PERMIT AGENCY FOR PLANS REVIEW AND PAYING


(DEFERRED SUBMITTALS).

MECHANICAL
 ELECTRICAL
 PLUMBING

ANY PLANS CHECK AND PERMIT FEES.

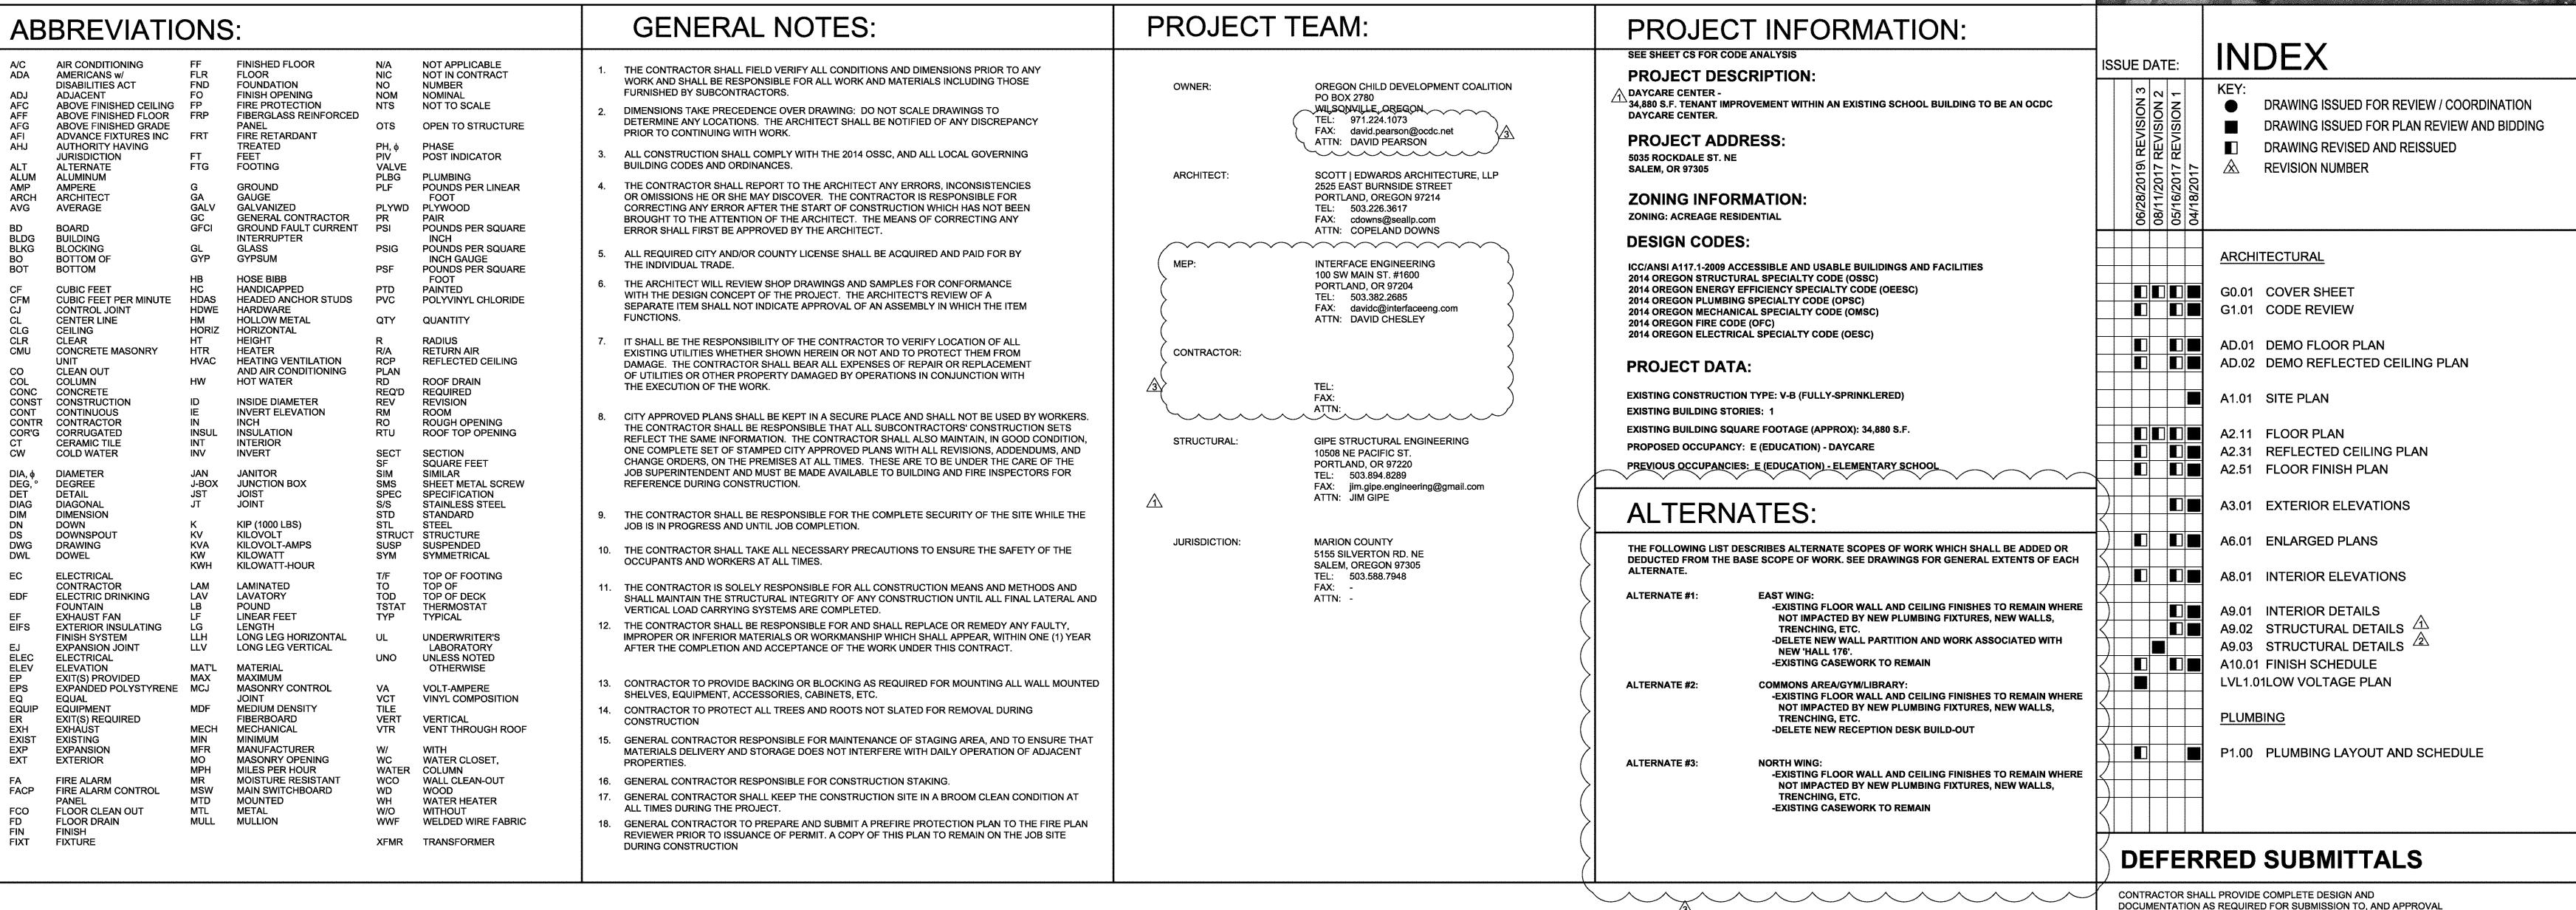

SCOTT EDWARDS ARCHITECTURE LLE 2525 E. Burnside St., Portland, OR 97214 phone:(503) 226-3617 www.seallp.com

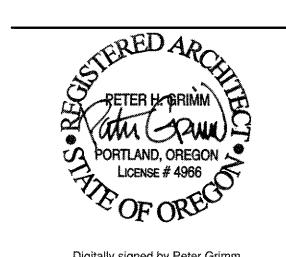

Date: 2019.06.28 11:54:49-07'00

OCDC BROOKS
5035 ROCKDALE ST. NE
BROOKS, OREGON 97305

∆ 06.28.19 REVISION 3

2 08.11.17 REVISION 2

05.16.17 REVISION 1

Drawing:


COVER SHEET

Job No:

b No: ate:


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SCOTT EDWARDS ARCHITECTURE LIP

SCOTT EDWARDS ARCHITECTURE LLP 2525 E. Burnside St., Portland, OR 97214 phone:(503) 226-3617 www.seallp.com

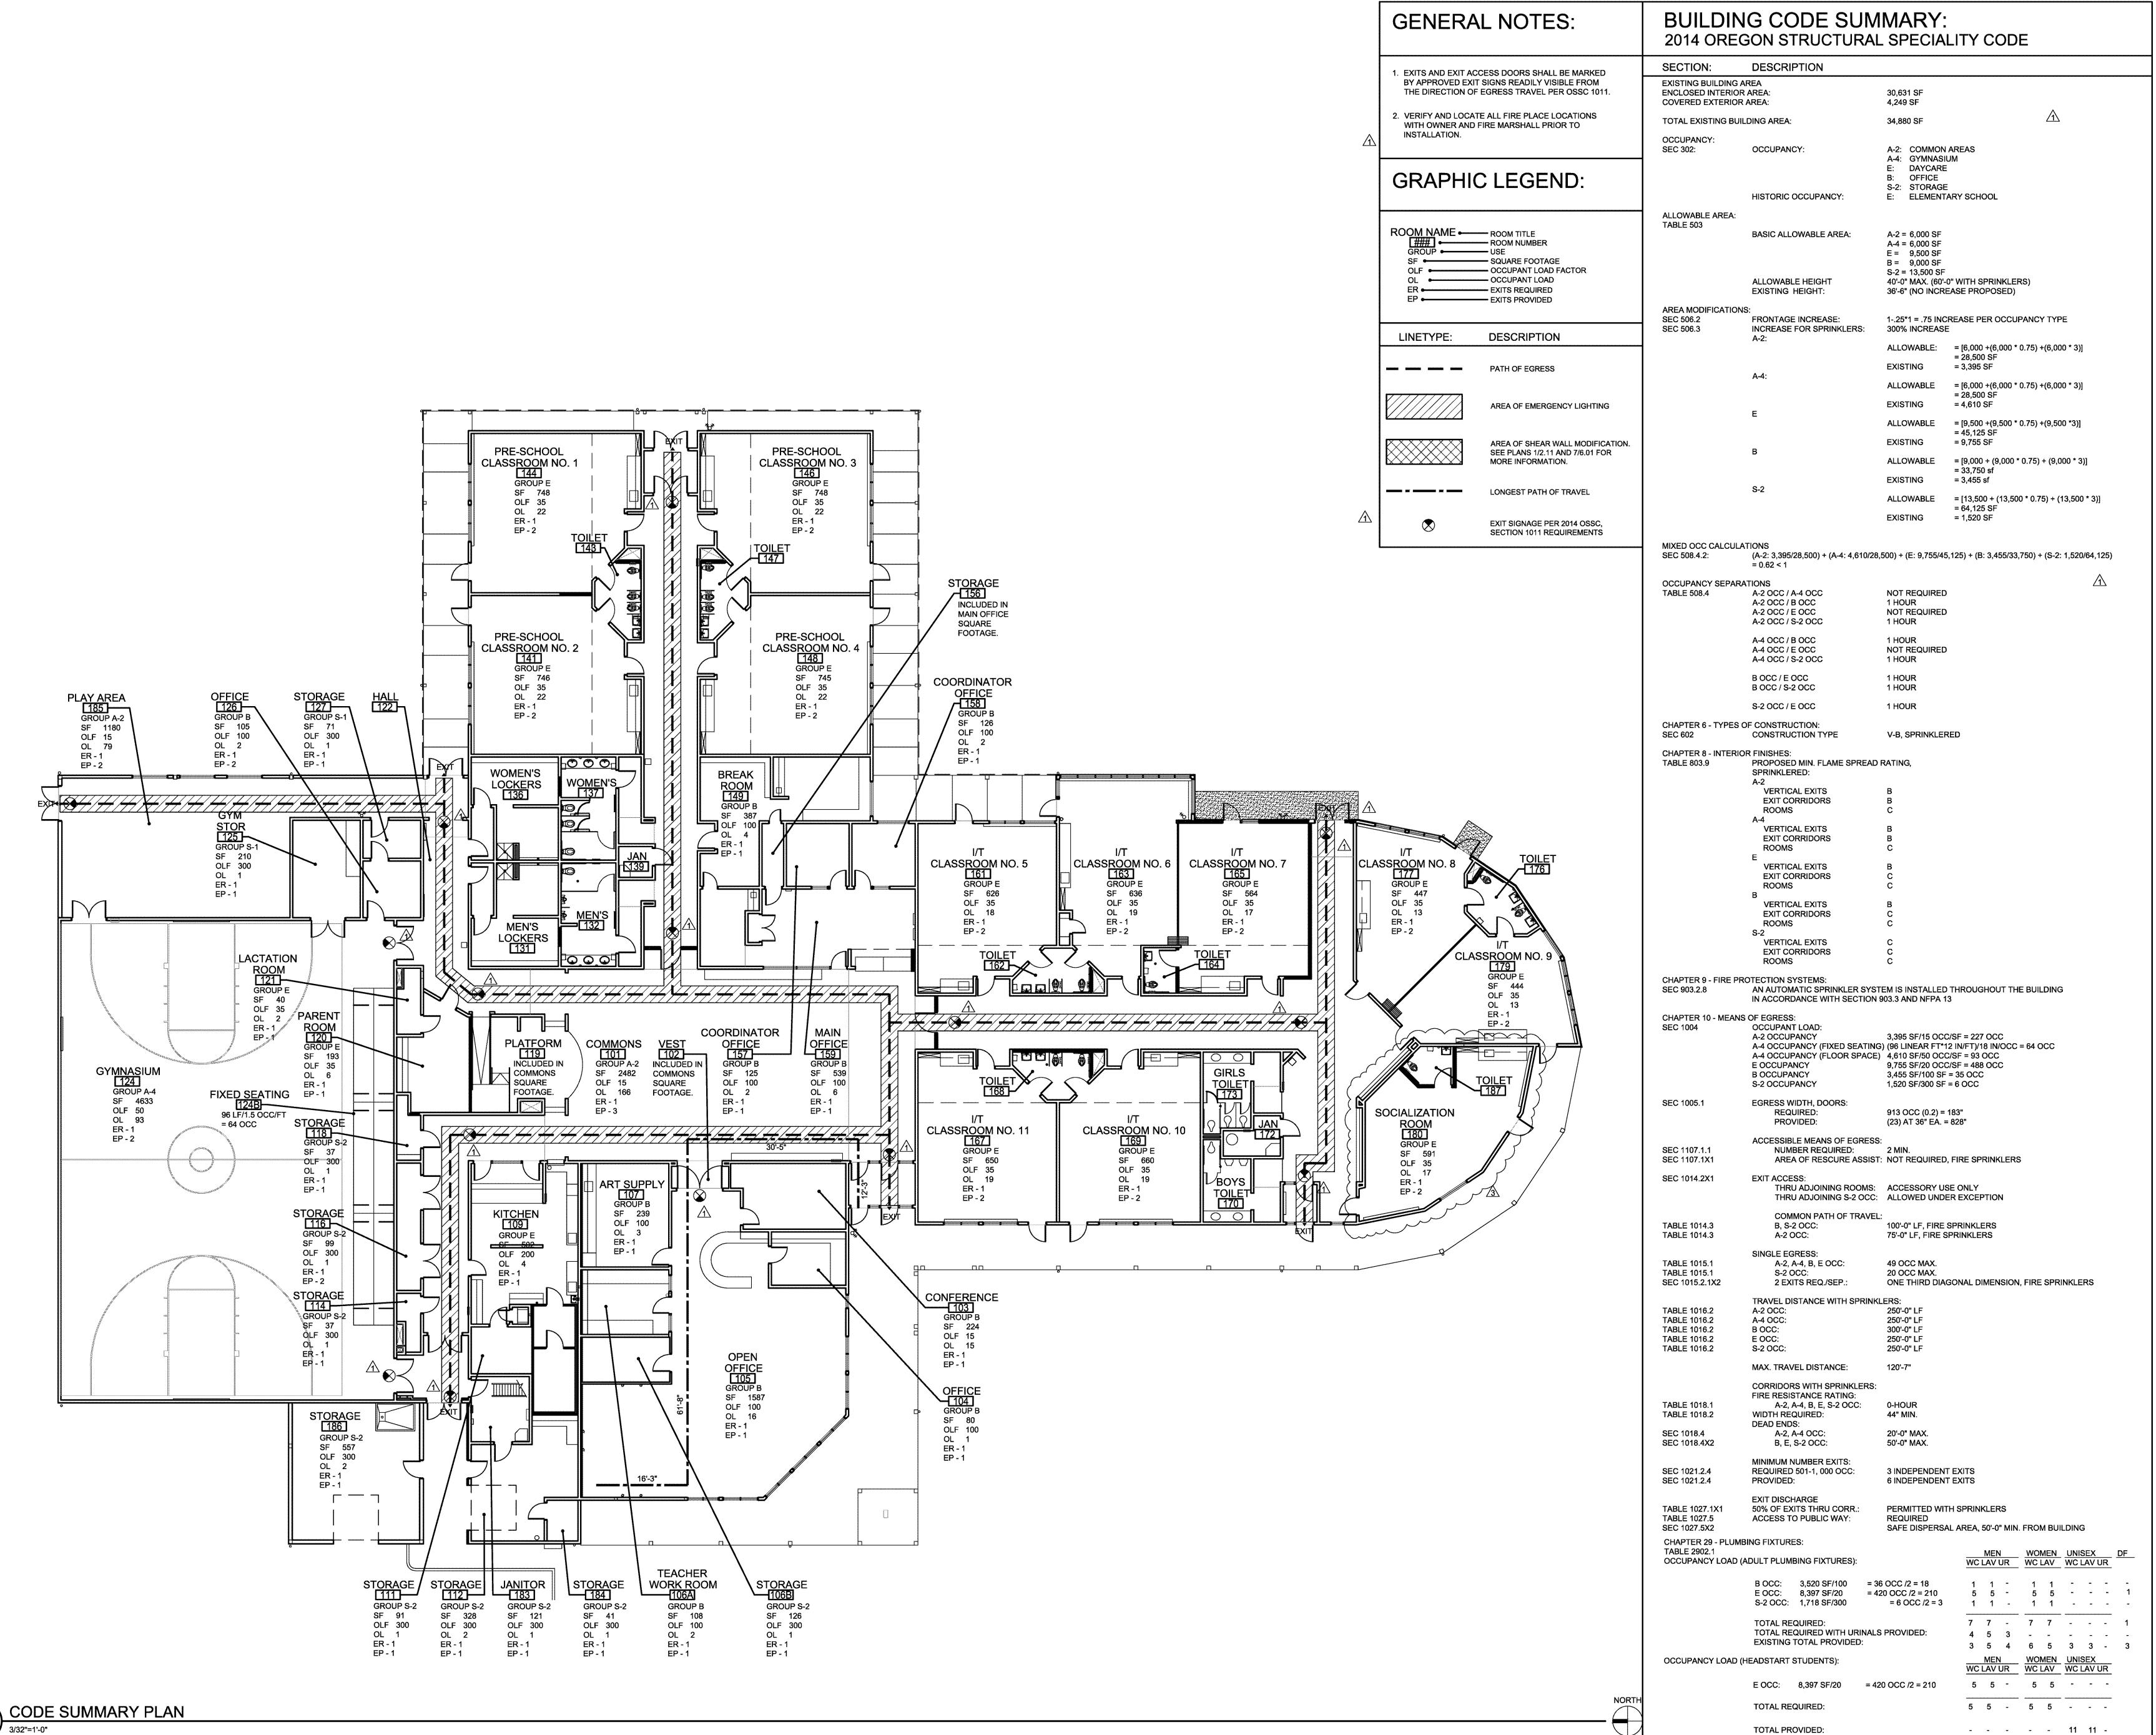

Date: 2019.06.28 11:55:22-07'00'

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5035 ROCKDALE ST. NE

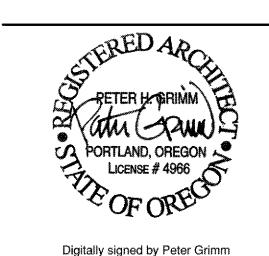BROOKS, OREGON 97305

3 06.28.19 REVISION 32 08.11.17 REVISION 2

05.16.17 REVISION 2

05.16.17 REVISION 1


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CODE SUMMARY


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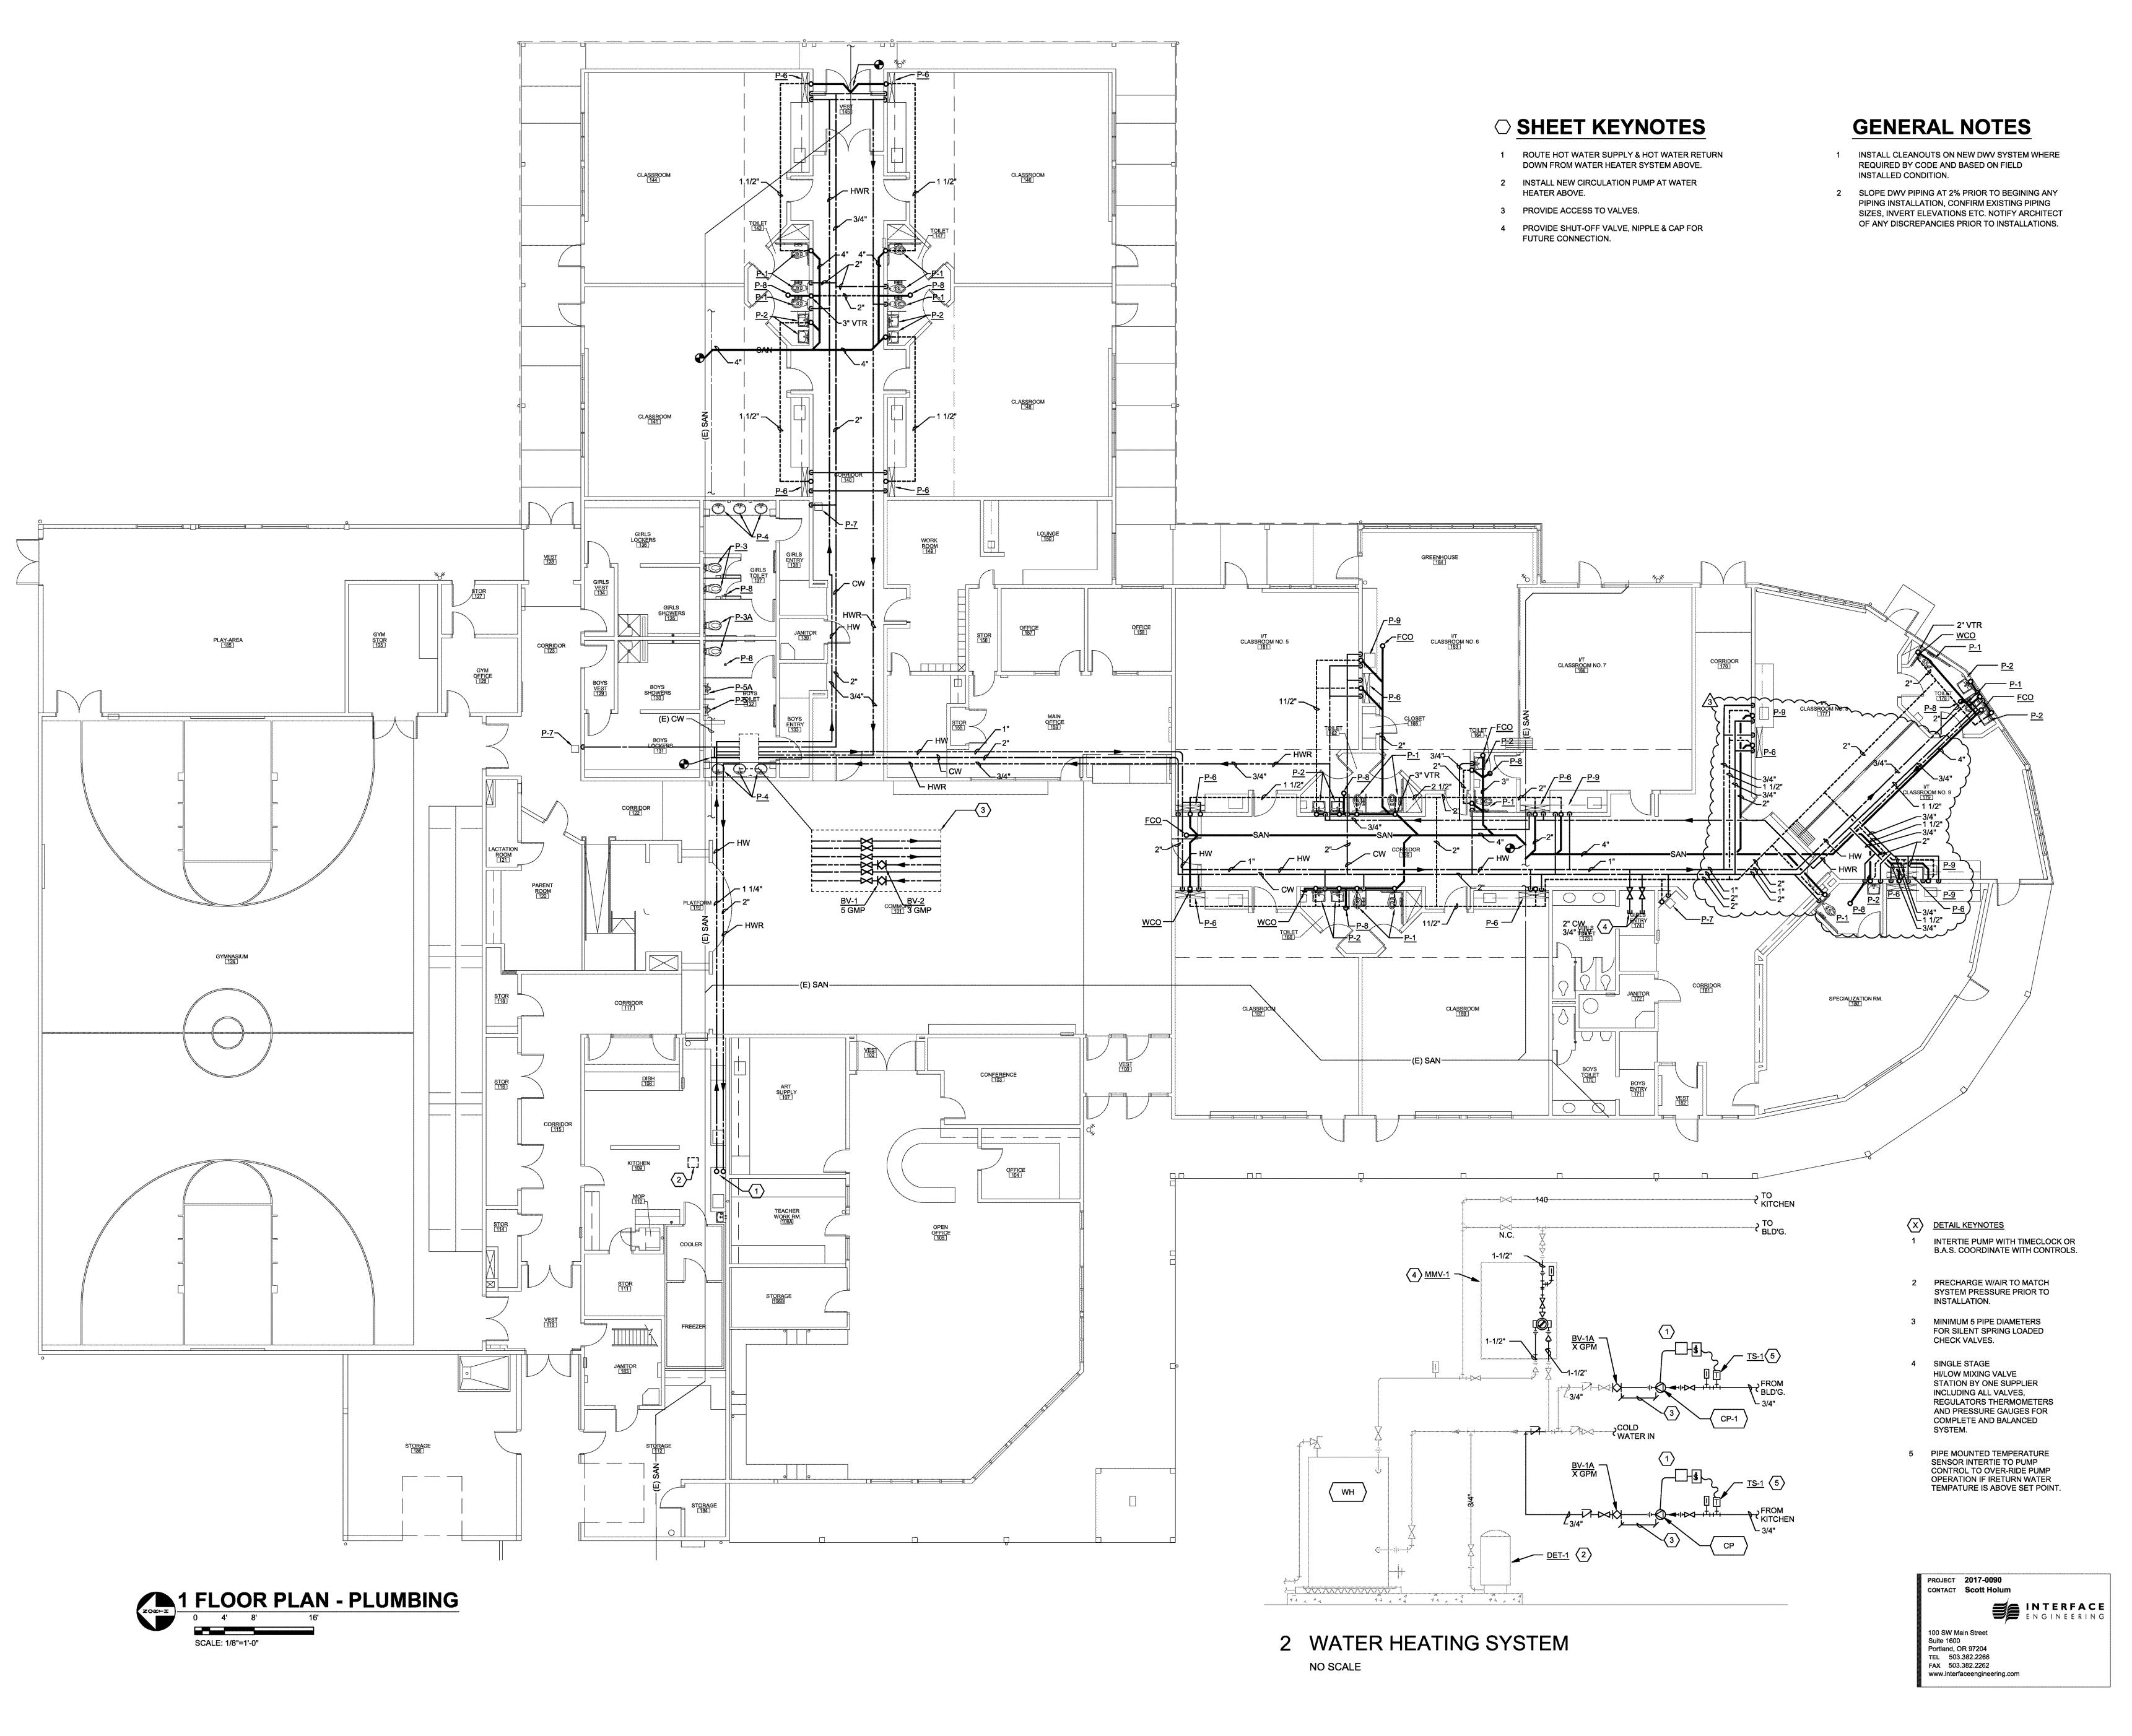
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3 06.28.19 REVISION 3 **2** 08.11.17 REVISION 2

1 05.16.17 REVISION 1

LOW VOLTAGE PLAN



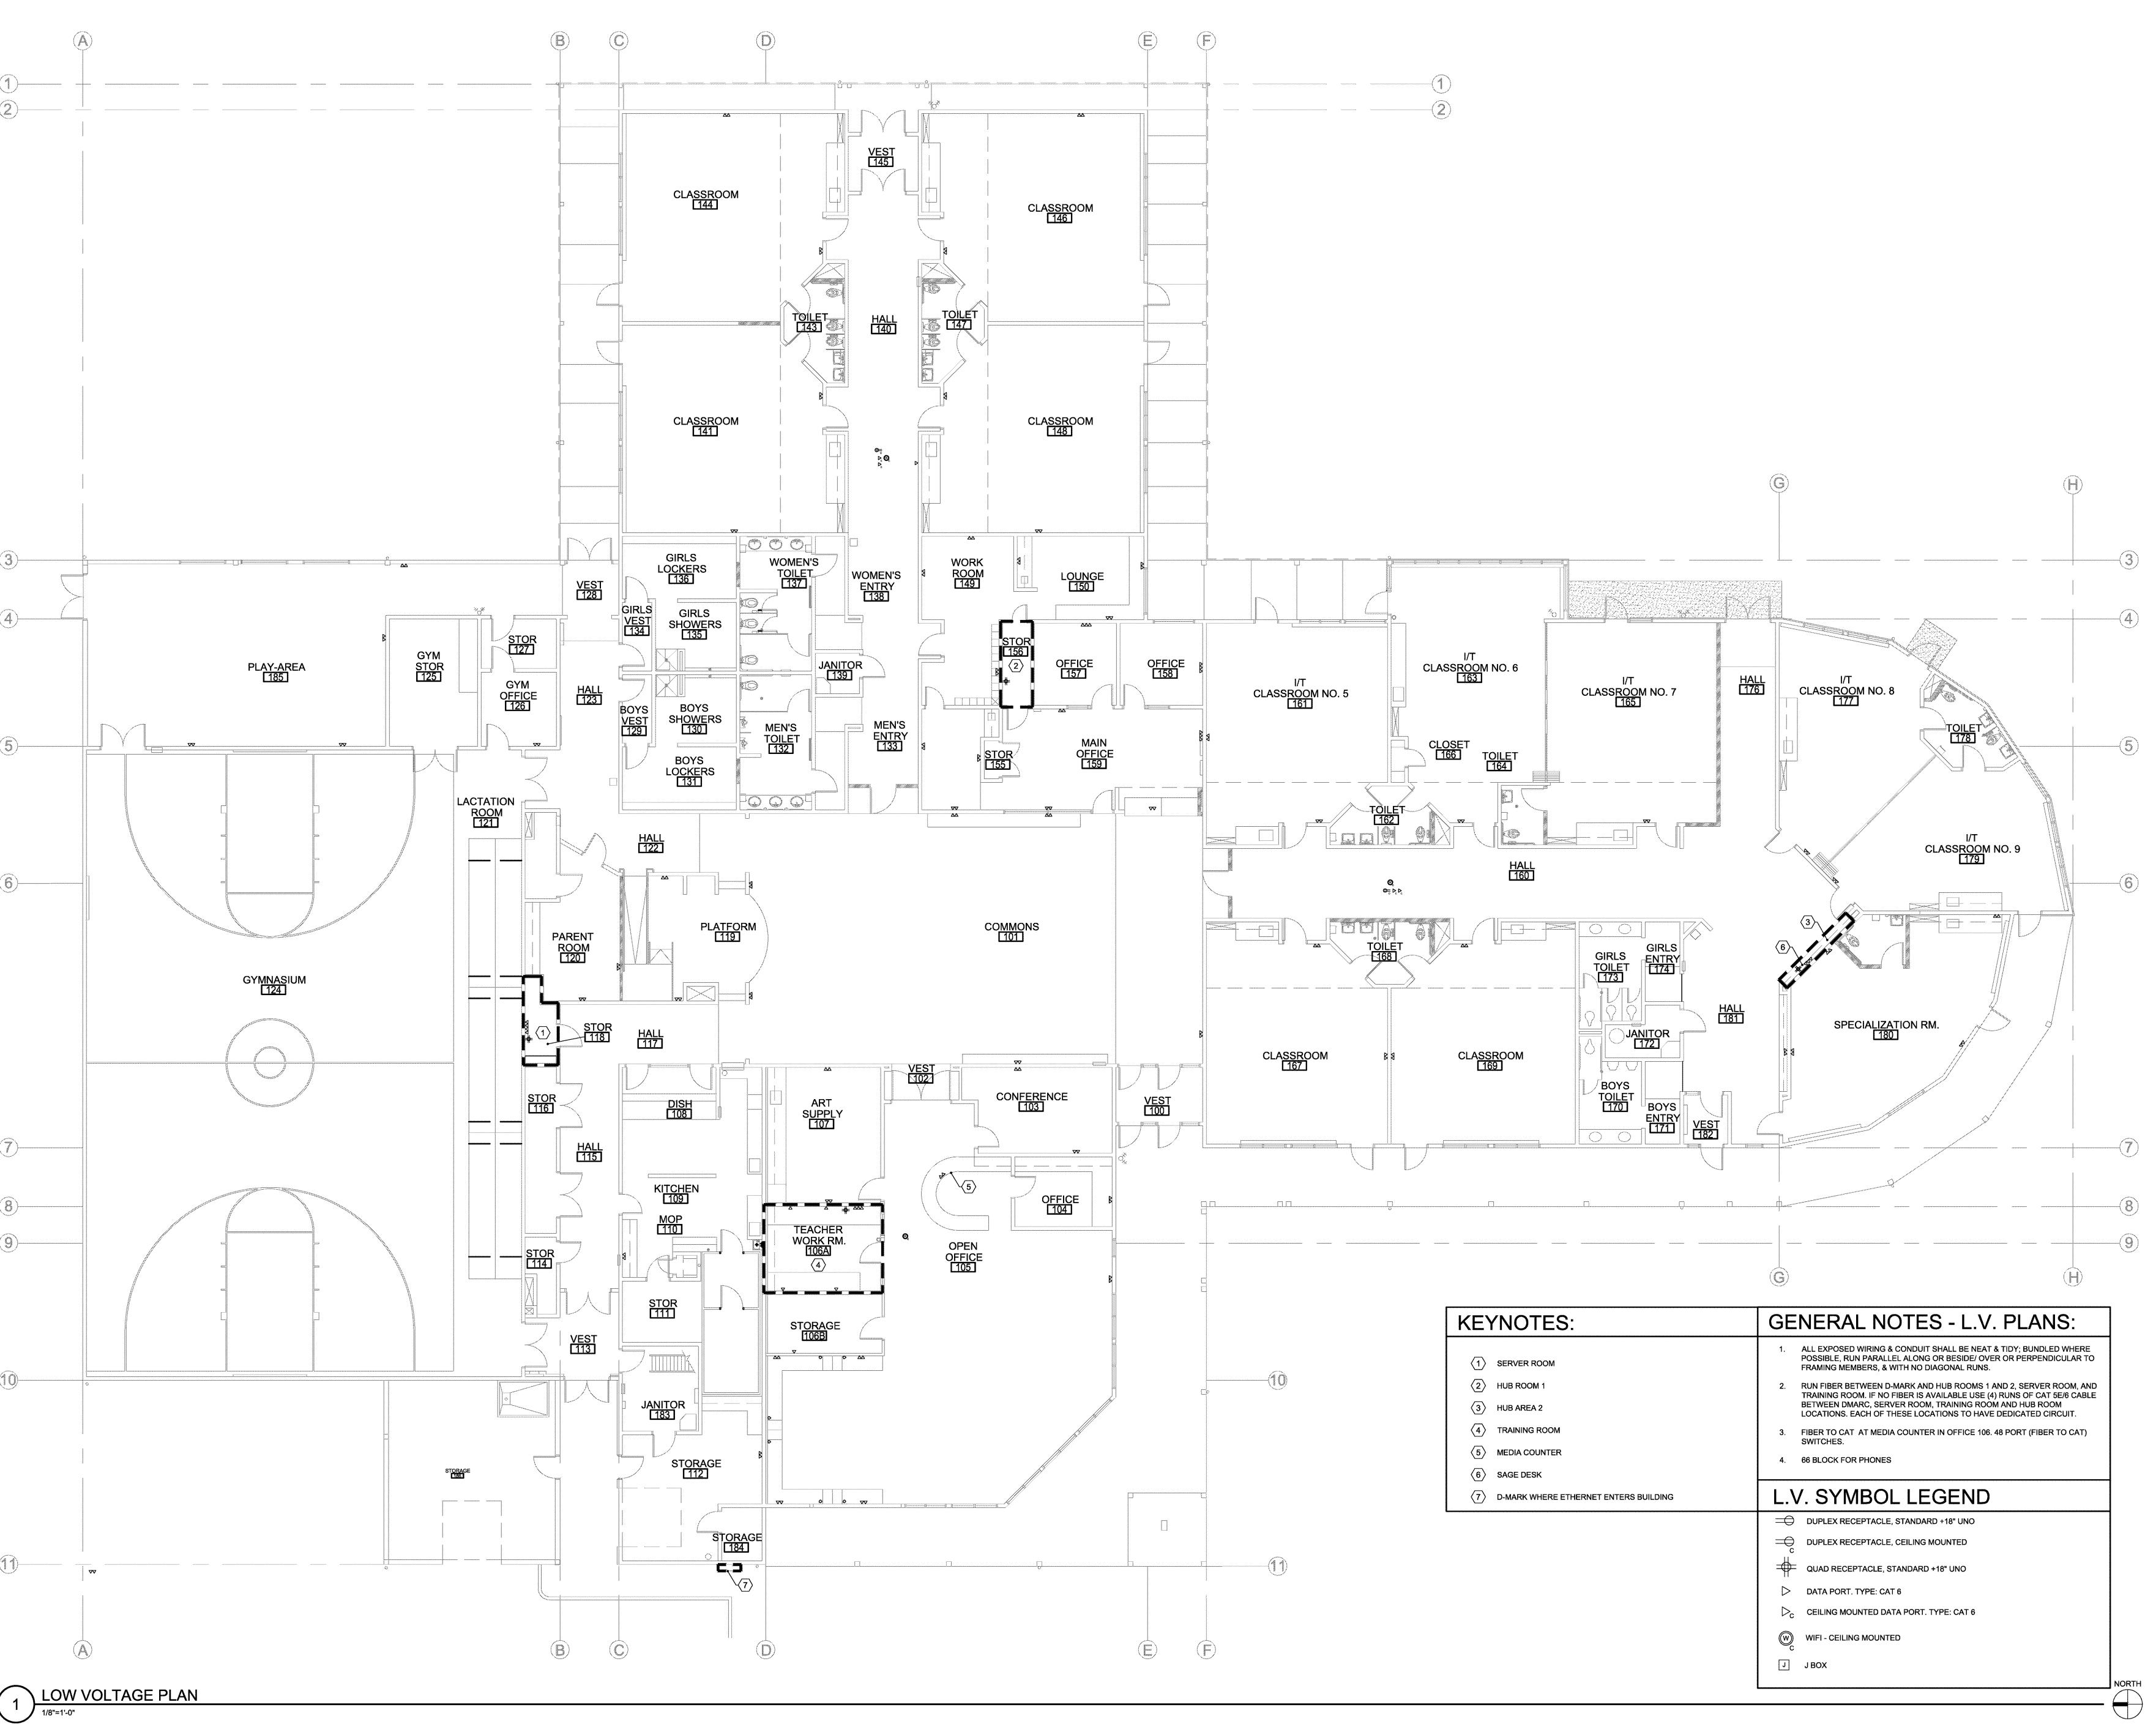

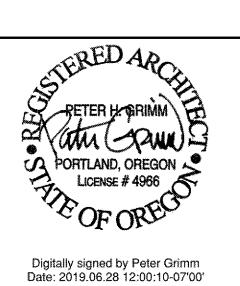100 SW Main Street
Suite 1600
Portland, OR 97204
TEL 503.382.2266
FAX 503.382.2262
www.interfaceengineering.com



5035 ROCKDALE ST. NE

FLOOR PLAN -PLUMBING

REVISIONS

3 06/28/2019 - REVISION 3

DRAWN BY

IEI

CHECKED BY

Scott Holum

Scott Holun
10B NO.
2017-0090

04/24/2017 SHEET NUMBER

1.0